

ready, set, lights out______

DESIGN DEVELOPMENT PACKAGE

GRADUATE THESIS: EXHIBITION & EXPERIENCE DESIGN

NAZ ERTUGRUL



	_flow.
	CLIENT
OK AND FEEL CLOOK AND FEELS	FID WEEKES (A
	VENUE
	MAIN VENUE: Superblue Miami, USA SATELLITE #1: Artscience Museum, Singapore SATELLITE #2: Silverstone Interactive Museum, UK SATELLITE #3: Yas Marina Circuit Racing School, UAE
WINGS	DESIGNER
WINGS	Naz Ertugrul 309 5th Ave
1PLES	New York, NY
VINGS	
1PLES	DISCLAIMER
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VINGS	may the information herein be used or disclosed in whole or in part, without the
WINGS	express written permission of Naz Ertugrul.
/INGS	KEY PLAN
E ELEMENTS: DIGITAL MEDIA	
ME AREA 1 ROUND CURTAIN CAROUSEL AXO	
ME AREA 1 PARTIAL FLOORPLAN	NOTES
ME AREA 1 SECTION ELEVATION	
S CURVED CURTAIN TRACK DETAILS	
CURVED CURTAIN TRACK DETAILS	
RY AREA DOME SECTION ELEVATIONS	
RY AREA DOME DETAILS	

DRAWING LIST

DRAWN BY NAZ ERTUGRUL

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SCALE



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EX508 GRAPHIC TYPE A DRAW

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EX511 GRAPHIC TYPE C DRAW

EX512 GRAPHIC TYPE C EXAM

EX513 GRAPHIC TYPE D DRAW

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EX605 DETAIL DRAWING: MTS

EX606 DETAIL DRAWING: ENTR

EX607 DETAIL DRAWING: ENTR

DRAWING SYMBOLS

3 DRAWING TITLE SCALE

DRAWING TITLE



DETAIL REFERENCE KEY



SECTION CUT



CENTERLINE



BREAKLINE

EXHIBIT CODES

XX

THEME AREA

XX

AREA ZONE WITHIN THE THEME AREA



MATERIAL CODE



AV CODE



GRAPHIC CODE



LIGHTING CODE



CLIENT







VENUE

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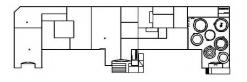
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KEY PLAN



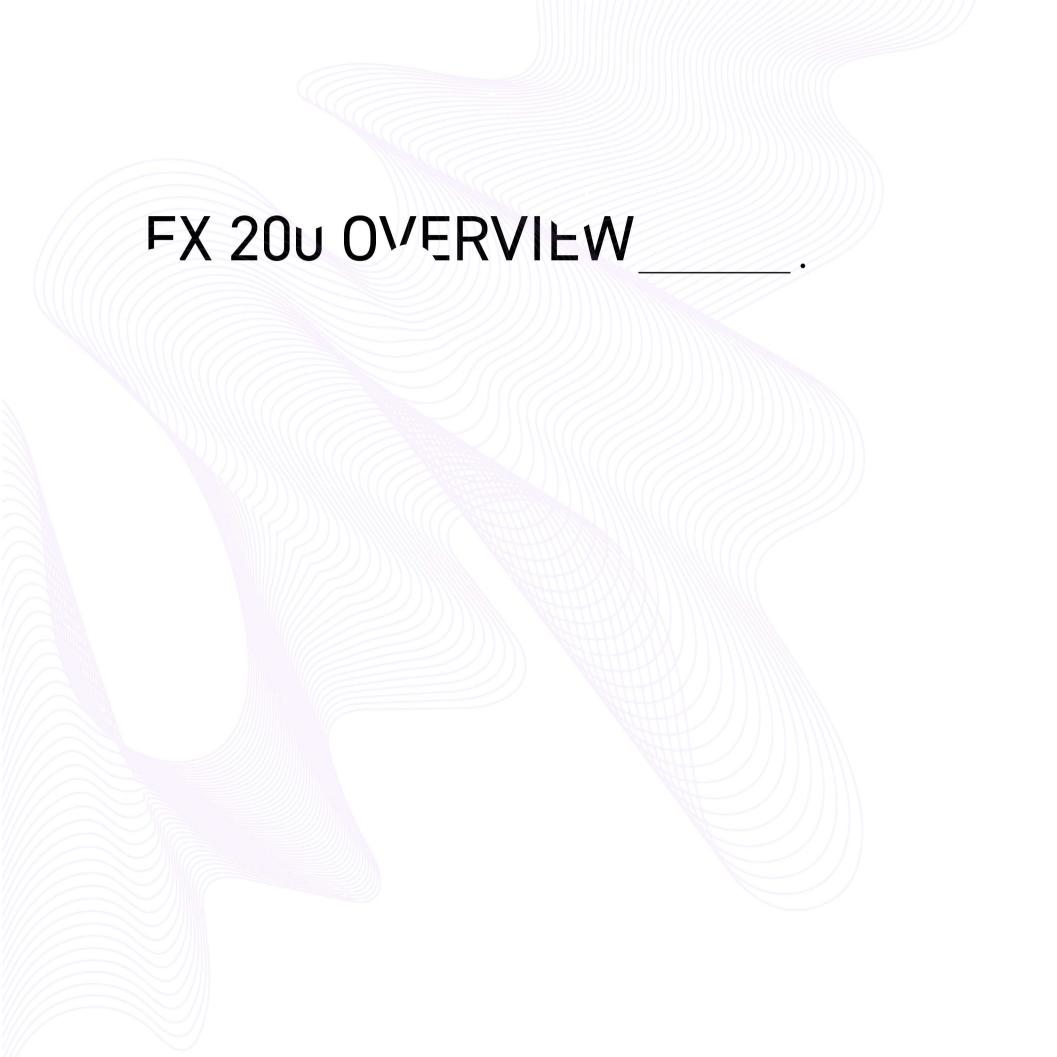
NOTES

DRAWING SYMBOLS

DRAWN BY NAZ ERTUGRUL

EX103





THESIS STATEMENT

this is your own phonemenon*_____.

Today's audiences are often chronicle-obsessed and co-dependent on smartphones to record moments for social appearance and photo likes, which results in a lack of presence in the moment and disengagement with the intentions of the setting.

Repurposing the use of smartphones in interpretive experiences to break the barrier between the camera lens and the individual can enable audiences to chronicle experiences for the purpose of fostering a deeper awareness of and connection to themselves, and their surroundings.

The use of customized smartphone applications as tools that can enhance the activation of the designed environment will facilitate audiences to identify and chronicle their meaningful moments, code-switch throughout their experience, and create their own journey.



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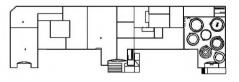
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NOTES

THESIS STATEMENT

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EX201

N/A



PROJECT

Reach to inspire uninitiated young women to become interested in motorsport racing to pursue as a career or a hobby.

Raise awareness on the under-chronicled female racing figures and pinpoint to multigenerational voices of women in the field of racing.

Support the mission and vision of the chosen venues by advocating for F1's diversity campaign of "We Race as One" and highlight the work of the W series.

Highlight the themes of gender diversity, motorsport's history, psychology, accessibility, inclusivity and innovation.

Create a sophisticated, scholarly and entertaining content which fits with the rest of content presented in the selected main and satellite venues.

Encourage the audience to form empathetical and social connections for themselves and their surroundings.









MAIN VENUE: Superblue Miami, USA SATELLITE #1: Artscience Museum, Singapore SATELLITE #2: Silverstone Interactive SATELLITE #3: Yas Marina Circuit Racing School, UAE

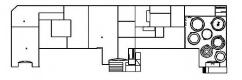
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GOALS

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EX202.01

FDUCATIONAL

About the athletes' flow experience as a feature of motorsport racing and drawing connections to any other subject field that consists high-focus activities which would initiate similar yet unique experiences.

About the multifaceted scholarship of the elements that construct a racing experience. From the design of the tracks to the engineering of the cars.

About the physical and psychological impacts of the flow experience on a human body.

The differences between written, visual, and auditory chronicling and their impact on designed experiences.

About the profound dynamic between mental presence, social engagement and their impact on forming mnemonic experiences which lead to long lasting memories.

About the physical, emotional, and sensorial triggers that foster social connection amongst themselves and their surroundings.

Find associations amongst the described content, curated experiences, and their contemporary life-style hobbies and activities.



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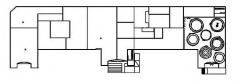
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KEY PLAN



NOTE

GOALS

DRAWN BY NAZ ERTUGRUL

EX202.02

SCALE

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FXPERIENCE

The different dimensions of flow experience.

Channeling familiar and unfamiliar emotions.

Different spatial and emotional journeys in tangent to venue specific content composition.

Multi-sensorial activities for elevated experiences.

Creative thinking, curiosity and elements of surprise and awe.



CLIEN







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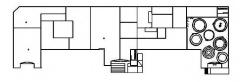
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KEY PLAN



NOTE

GOALS

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EX202.03

SCALE

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SUBJECT

The flow experience, "Csikszentmihalyi" of F1 automobile racing through the multigenerational voices of women.

The designed experience can become a platform to broadcast gender diversity in motorsport racing and inspire young females to become interested in pursuing racing as a career or a hobby.

CLIENIS

FIA, Federation Internationale de l'Automobile (F1's & W Series' Head Organization) Apple (Smartphone Technology Company) Adobe (Design Software Company)

VENUES

Superblue Miami, USA
ArtScience Museum, Singapore
Silverstone Interactive Museum, UK
Yas Marina Circuit Racing School, UAE

AUDIEINCF

Young Rising Female Athletes
Uninitiated Young Females
Female E-sport Gamers & Streamers
Motorsport Racing Fans (F1, Indycar, etc.)
Sport Enthusiasts



CLIEN







VENUE

MAIN VENUE: Superblue Miami, USA SATELLITE #1: Artscience Museum, Singapore SATELLITE #2: Silverstone Interactive Museum, UK SATELLITE #3: Yas Marina Circuit Racing School. UAE

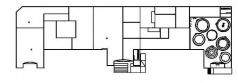
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KEY PLAN



NOTE

PROJECT PARAMETERS

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EX203.01





"We believe that we are on the face of the earth to make great products and that's not changing. We are constantly focusing on innovating. We believe in the simple not the complex. We believe in deep collaboration and cross-pollination of our groups which allow us to innovate in a way that others cannot."



"We encourage diversity across the board and are building better and more accessible pathways into Motor Sport and Mobility alike. We foster gender equality, inclusivity in motoring and tourism, and access to motor racing."



"We want to build the world's most popular and inclusive female sporting series that inspires and empowers females to be part of motorsport on equal terms with men. In the process, we hope to create a platform to accelerate gender equality the world over."



"Changing the world through digital experiences. Great experiences have the power to inspire, transform, and move the world forward. Every great experience starts with creativity."



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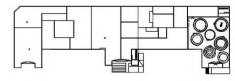
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NOTE

PROJECT PARAMETERS

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EX203.02

SCALE N



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CHEN







VENUE

MAIN VENUE: Superblue Miami, USA
SATELLITE #1: Artscience Museum, Singapore
SATELLITE #2: Silverstone Interactive
Museum, UK
Museum, UK
School, UAE

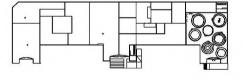
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KEY PLAN



NOTE:

BIG IDEA STATEMENT

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EX204

CALE N/A

TIG IDÉA STATEMENT

lose yourself in your imagination

An immersive co-authored story which unfolds the flow experience of F1 motorsport racing through the voices of multigenerational women. The story of flow sets a stage in conveying the enhanced future of female racing and constructs opportunities for young females to pursue the subject and get involved.

The exhibition will act as a designed stage that is tasked to alter according to various activities/experiences listed under the subject of motorsport racing. The intention of the setting is to become synonymous for providing the optimal climate where flow experience will thrive.

Through multiple activities, the audience will become a part of the script taking place in the stages by acting and learning through industry professionals' experiences. The activities will develop around the flow experience's impacts on the mind, body and soul while witnessing some on the spot. Therefore, the exhibition will also recognize the flow experience as a connecting medium for increasing meaningful social connections within individuals and their surroundings.

'MAI IS FLOW?

levitate in flow state

A holistic sensation that people feel when they act with total involvement.

A mental state characterized by total immersion, focus and involvement in a task.

A state of complete absorption or engagement in an activity and refers to the optimal experience.





CLIEN







VENITE

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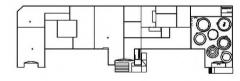
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KEY PLAN



NOTES

CONCEPT BUBBLE DIAGRAM

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EX205

N/A





CONCEPT FLOORPLAN
SCALE: 1/16"=1'-0"



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VENUE

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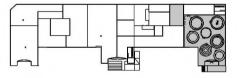
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KEY PLAN



NOTES

CONCEPT FLOORPLAN

DRAWN BY NAZ ERTUGRUL

EX206

SCALE 1/16"=1'-0"



STAFF RULES

2 staff members per each activity zone.

Guiding from one activity zone to another if needed, or if any audience member needs to exit before completing the journey.

Introductions and warnings for each activity for containing heavy light and sound effects.

Provide qr codes for certain activities for the audience to complete the experience.



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VENUE

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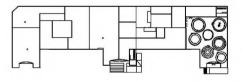
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STAFF ROLES

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EX207









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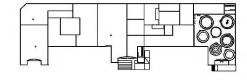
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KEY PLAN



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SUPERBLUE MIAMI, USA

2022 MIAMI GP МАУ 8ТН,

SPRING

2022

SILVERSTONE INTERACTIVE MUSEUM, UK JULY 3RD, 2022 SILVERSTONE GP

SUMMER

2022

GP ARTSCIENCE MUSEUM, SINGAPORE SINGAPORE 2022 2ND, OCTOBER

WINTER

FALL 2022

YAS MARINA CIRCUIT RACING SCHOOL, UAE

GP

ABU DHABI

DECEMBER 10TH, 2022

2022

SPRING

SUPERBLUE MIAMI, USA

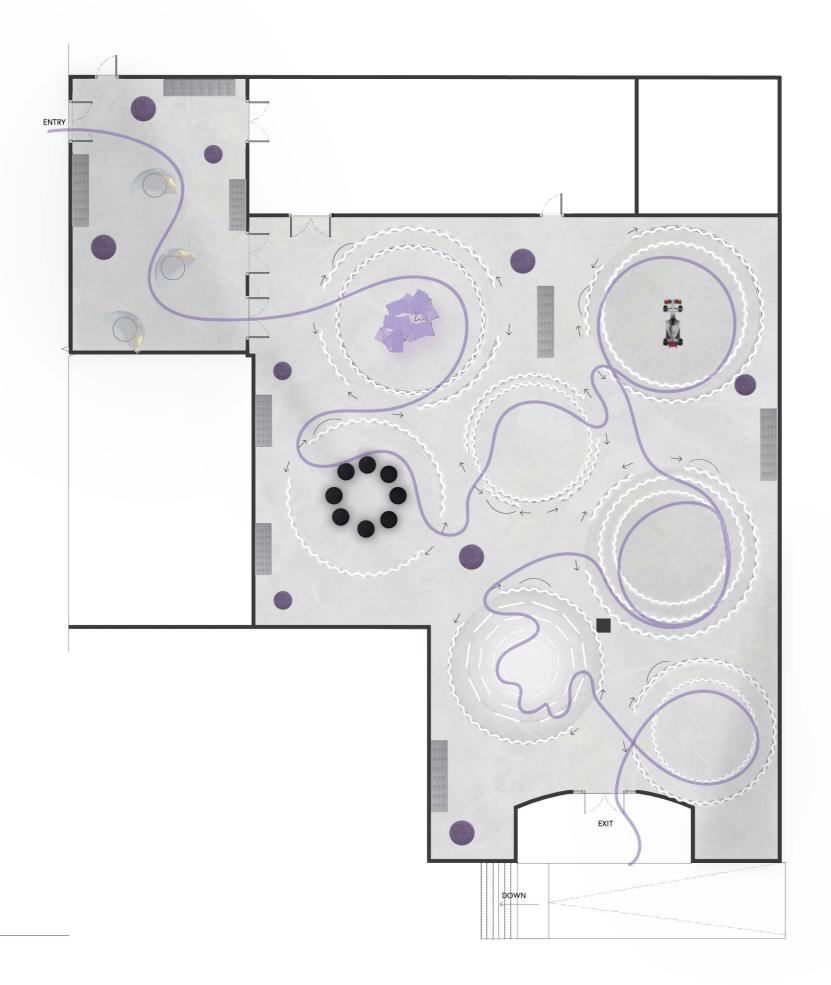
2023 MIAMI GP

TBA,

2023

PROJECT TIMELINE

EX208



CIRCULATION DIAGRAM
SCALE: 1/16"=1'-0"



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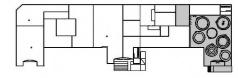
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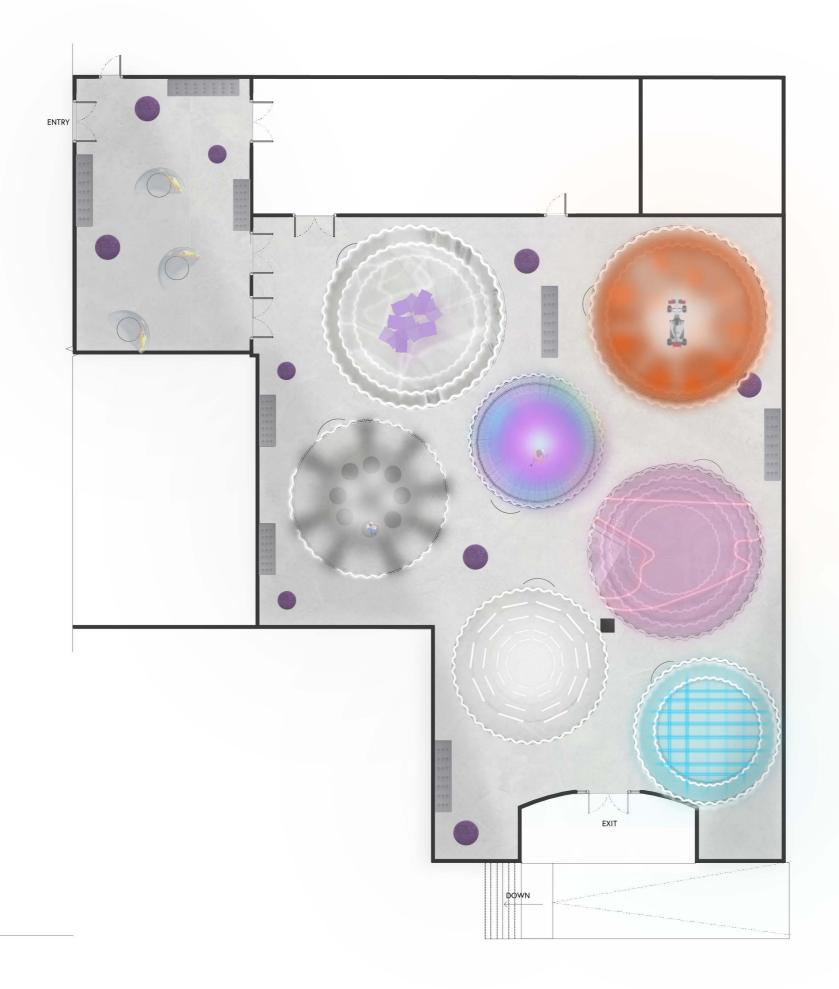
CIRCULATION DIAGRAM

DRAWN BY NAZ ERTUGRUL

EX209

SCALE 1/16"=1'-0"





RENDERED KEY PLAN SCALE: 1/16"=1'-0"



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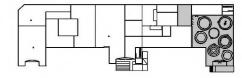
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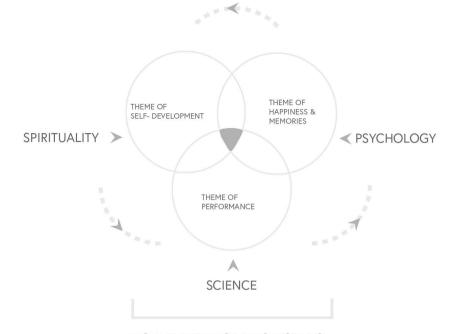
RENDERED KEY PLAN

DRAWN BY NAZ ERTUGRUL

EX210

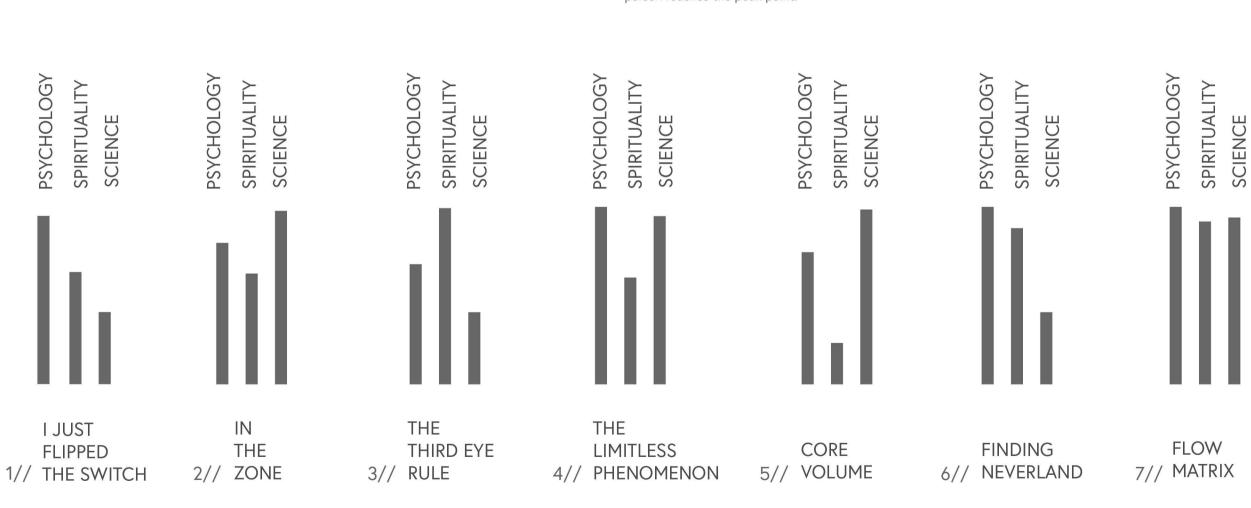
SCALE 1/16"=1'-0"





FLOW EXPERIENCE PERSPECTIVES

The complete flow state is experienced through different perspectives and when experienced through all three, a person reaches the peak point.





CLIENT







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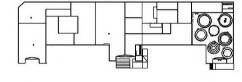
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KEY PLAN



NOTES

EXPERIENCE MAP

DRAWN BY NAZ ERTUGRUL

EX211

SCALE N/A

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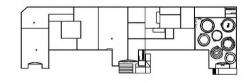
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KEY PLAN



NOTES

EMOTIONAL JOURNEY DIAGRAM

DRAWN BY NAZ ERTUGRUL

EX212.01

SCALE N/A N

1ST DIMENSION CHALLENGE-SKILL BALANCE
BEYOND AVERAGE EXPERIENCE
PERCEPTION OF CHALLENGE
MENTAL ENERGY INTO TASK

7TH DIMENSION

LOSS OF SELF-CONCIOUSNESS LACK OF OTHER THOUGHTS

8TH DIMENSION

DISTORTED SENSE OF TIME

9TH DIMENSION

PEAK FLOW STATE
SUM OF ALL 8 DIMENSIONS
ANTICIPATION OF REWARD
AUTOTELIC PERSONA
ENJOYABLE EXPERIENCE

3RD DIMENSION CLEAR GOALS
FULL CONNECTION TO TASK
RESPONSIVE TO CUES

2ND DIMENSION

RESPONSIVE TO CUES
AWARENESS ON PERFORMANCE

BEING AT ONE WITH A TASK

SENSE OF PEACE

MIND BODY HARMONY FEELING OF AUTOMACY

4TH DIMENSION EASY RECEIVAL OF INFO

EASY INTERPRETATION OF INFO EFFORTLESS PROCESSING NAVIGATING PERFORMANCE

5TH DIMENSION TOTAL FOCUS

TOTAL ENGAGEMENT ALL TYPE OF CONNECTEDNESS PRESENCE IN THE MOMENT

6TH DIMENSION SENSE OF CONTROL RISING CONFIDENCE

STATE OF EMPOWERMENT
CONTINUED PREDETERMINED CUES



INDIVIDUAL > ✓ OTHER INDIVIDUALS UNIVERSE





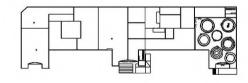
MAIN VENUE: Superblue Miami, USA SATELLITE #1: Artscience Museum, Singapore SATELLITE #2: Silverstone Interactive Museum, UK SATELLITE #3: Yas Marina Circuit Racing School, UAE

DESIGNER

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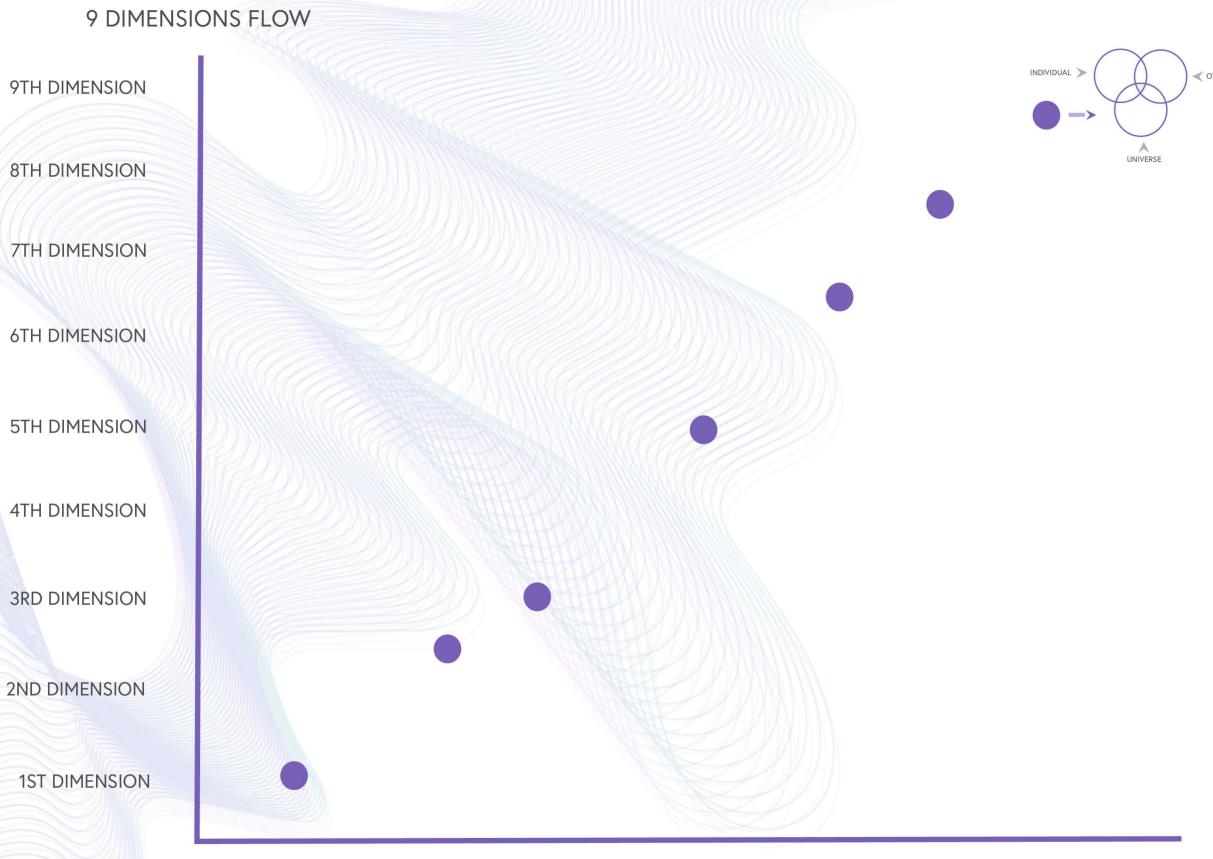
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KEY PLAN



NOTES

EMOTIONAL JOURNEY DIAGRAM DRAWN BY NAZ ERTUGRUL EX212.02 \bigcirc N SCALE



THE

LIMITLESS

PHENOMENON

FINDING

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CORE

VOLUME

FLOW

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RULE

THIRD EYE

'NTERPRFTIVE APPROACH

take	e the	driver's	seat	,
		G		

The interpretive approach for the exhibition will be achieved through utilizing a combination of the guided approach and the participatory approach. In some activities industry professionals will be introducing the audience to subject specific content through fast paced-intensive experiences as a part of the script that they will be performing, and in the other half enable the audience to take the driver's seat. The audience will be learning and engaging via participating, and following the script. Therefore, the collaboration initiated on the set will lead to the enrichment of displayed content and will enable it to be delivered through different methods as the performances and the environments will be constantly changing.



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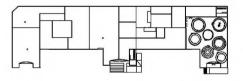
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NOTES

INTERPRETIVE APPROACH

DRAWN BY NAZ ERTUGRUL

EX213











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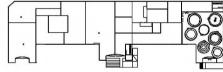
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KEY PLAN



RENDERING: ENTRY AREA

DRAWN BY NAZ ERTUGRUL

EX214



PESIGN STATEMENT

travel in the depths of 9 dimensions

An upbeat journey similar to a race setting where everything is ready to be on the move and with the activities and experiences taking place in it you turn it into a stage. Inspired by the collapsible traveling tent structures for race preparation, the space will be made out of small carousels surrounded with curtains that will create a tent like feel. Similar to the mechanical gear moving in different directions and making the machine work, these individual curtained hubs will move in left to right direction creating paths like a race circuit and remaking the experiential space for visitor flow from one activity to the other in time. The enclosed hubs will be made out of different materials and with multiple layers to convey the idea of depth and dimension when experiencing different stages of flow.









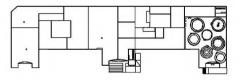
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DESIGN STATEMENT

DRAWN BY NAZ ERTUGRUI

EX215







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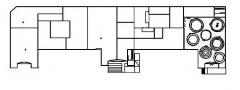
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KEY PLAN



NOT

RENDERING: EXHIBIT AXO CLOSED SYSTEM

DRAWN BY NAZ ERTUGRUL

EX216







CLIEN







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MAIN VENUE: Superblue Miami, USA SATELLITE #1: Artscience Museum, Singapore SATELLITE #2: Silverstone Interactive Museum, UK SATELLITE #3: Yas Marina Circuit Racing School, UAE

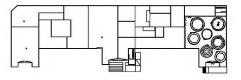
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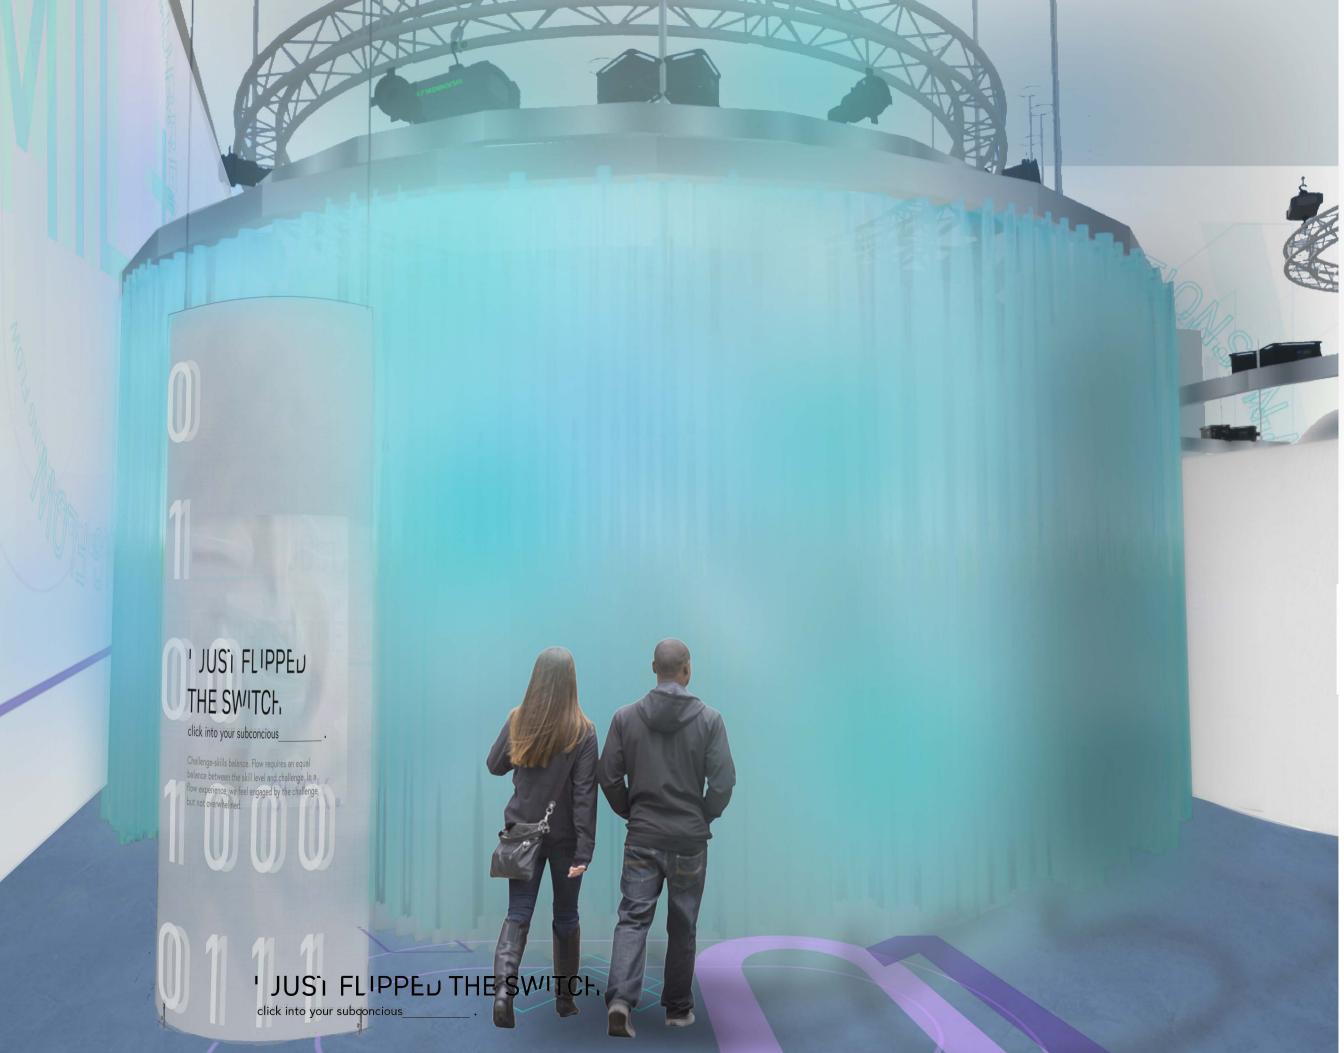
NOTE

RENDERING: EXHIBIT AXO OPEN SYSTEM

DRAWN BY NAZ ERTUGRUL

EX217











MAIN VENUE: Superblue Miami, USA SATELLITE #1: Artscience Museum, Singapore SATELLITE #2: Silverstone Interactive Museum, UK SATELLITE #3: Yas Marina Circuit Racing School, UAE

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KEY PLAN



RENDERING: THEME AREA 1

DRAWN BY NAZ ERTUGRUL

EX218.01



SEE
The changing atmosphere with lighting and visuals, video projections on the curtains.

Watch the performance that is taking place in their surrounding environment, and listen what the drivers' motivation behind driving.

LEARN

DO

An introductory on the main characters which are the drivers that will be appearing from time to time in this journey. The audience and learn the basics of what they do and why they do it. There will be an indication and introduction to the topic of flow as they are describing their first hand experiences.



CLIEN







VENUE

MAIN VENUE: Superblue Miami, USA SATELLITE #1: Artscience Museum, Singapore SATELLITE #2: Silverstone Interactive Museum, UK SATELLITE #3: Yas Marina Circuit Racing School, UAE

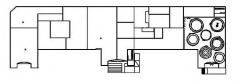
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KEY PLAN



NOTES

RENDERING: THEME AREA 1

DRAWN BY NAZ ERTUGRUL

EX218.02

SCALE

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VEN

MAIN VENUE: Superblue Miami, USA SATELLITE #1: Artscience Museum, Singapore SATELLITE #2: Silverstone Interactive Museum, UK SATELLITE #3: Yas Marina Circuit Racing School, UAE

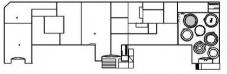
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KEY PL



NOTES

RENDERING: THEME AREA 1

DRAWN BY NAZ ERTUGRUL

EX218.03

SCALE

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VEN

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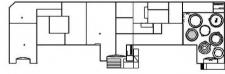
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KEY PLAN



NOTES

RENDERING: THEME AREA 2

DRAWN BY NAZ ERTUGRUL

EX219.01

SCALE N



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Audience will see a pit lane from a race setting, and feel like they are sitting inside the actual race car.

DO____

The audience will be conducting a role-play with the engineers on screen, getting ready for a race. In the meantime they will be utilizing their smartphones as a key component for the rest of the experience.

LEARN____

The audience will learn the role of the engineer and get a brief understanding of driver- engineer relationship as they are preparing to race. As the audience take off their journey inside the car they will get certain hints of what flow feels like, indicating the rush and the adrenaline that comes with traveling at a high speed.



CLIEN







VENUE

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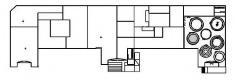
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NOTES

RENDERING: THEME AREA 2

DRAWN BY NAZ ERTUGRUL

EX219.02











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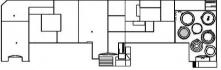
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KEY PLAN



RENDERING: THEME AREA 2

DRAWN BY NAZ ERTUGRUL

EX219.03

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VENUE

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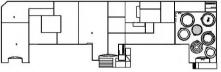
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KEY PLAN



NOTES

RENDERING: THEME AREA 3

DRAWN BY NAZ ERTUGRUL

EX220.01

CONT N/

⊕N

SEE	

Silhouettes of characters belonging to the exhibit "The Hidden Figures", the women behind scenes appear on the surrounding screens.

DO____

Utilize their smartphones as a mirror glass to look inside the silhouette's figure, and into their soul to learn short excerpts about the characters' experiences of flow.

LEARN

The audience will be looking into and learning more about flow also how it is defined by each individual. Learning what takes place in their headspace, and how their subconscious is shaped by the memories they have while experiencing flow. The trigger of focus is created by the gaze and eye contact which will unlock the state of flow.



CLIEN







VENUE

MAIN VENUE: Superblue Miami, USA SATELLITE #1: Artscience Museum, Singapore SATELLITE #2: Silverstone Interactive Museum, UK SATELLITE #3: Yas Marina Circuit Racing School, UAE

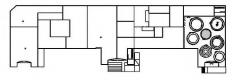
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NOTES

RENDERING: THEME AREA 3

DRAWN BY NAZ ERTUGRUL

EX220.02

SCALE N







CLIEN



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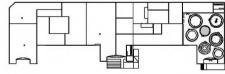
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NOTE

RENDERING: THEME AREA 3

DRAWN BY NAZ ERTUGRUL

EX220.03

SCALE N/

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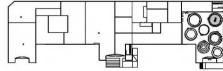


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RENDERING: THEME AREA 4

DRAWN BY NAZ ERTUGRUL

EX221.01





An abstract interpretation of the heat and the energy that the race car carries which is conveyed through the play of lighting. It will then unfold projection mapping of the race cars that the exhibition characters drove.

DO____

The audience will scan the projections and use their smartphones as a remote control to dissect the car into parts also add in their voice by creating a collage of the car with the rest of the participating audience.

LEARN____

Interesting facts about each component and the changes that has happened to the car over the years impacting its mechanics, technology and design. Also, the audience will learn about the specific cars that the characters drove and their significant memories about it.









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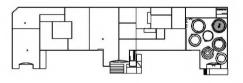
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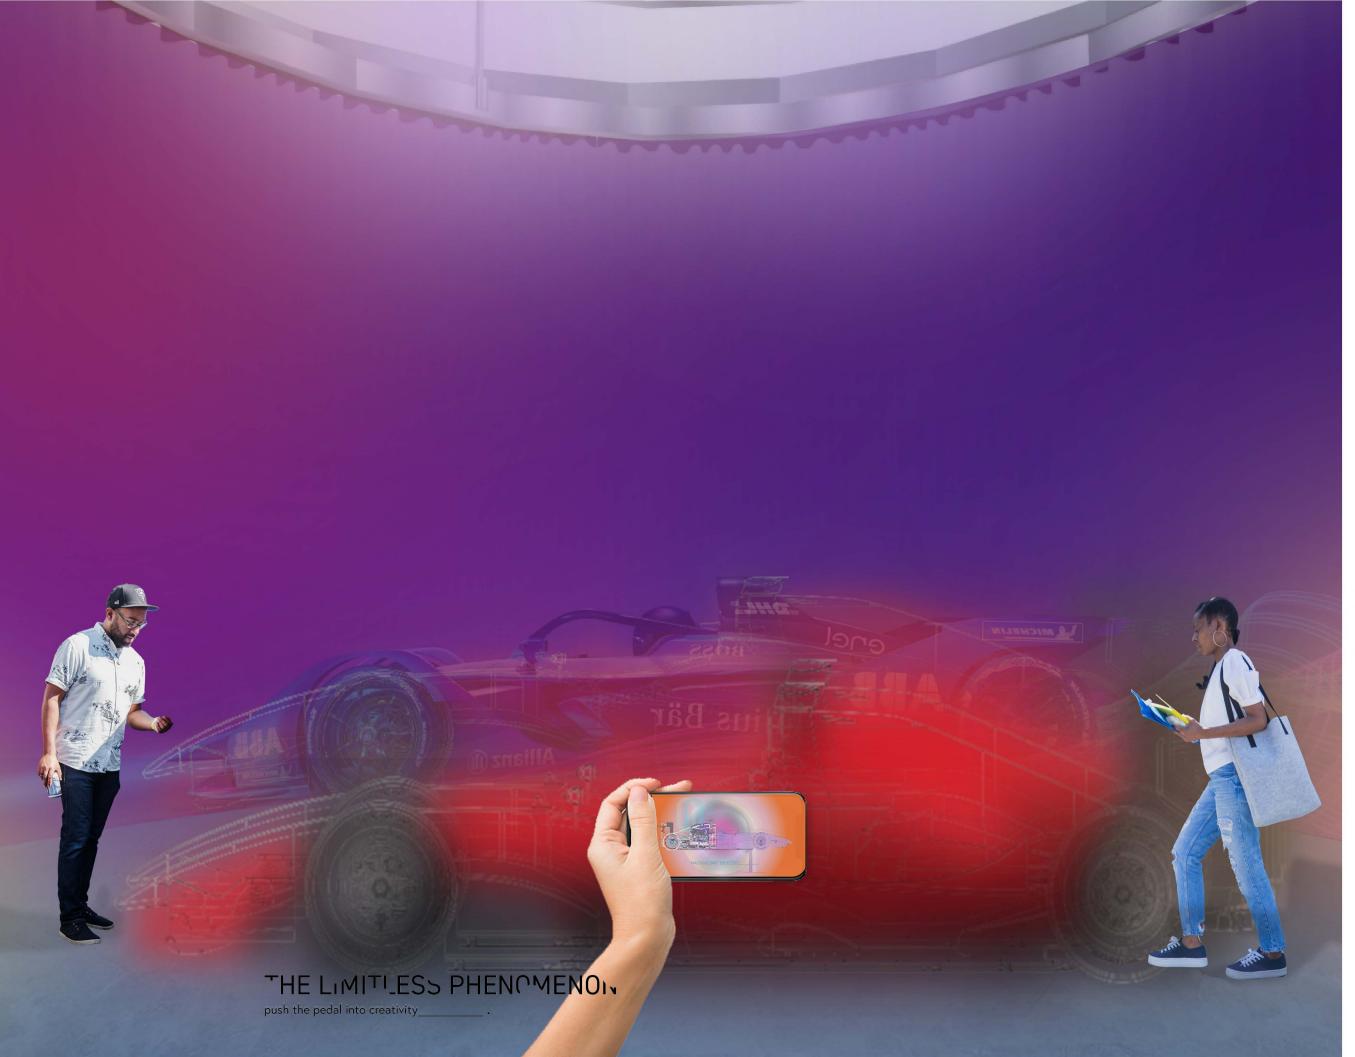
RENDERING: THEME AREA 4

DRAWN BY NAZ ERTUGRUL

EX221.02

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MAIN VENUE: Superblue Miami, USA SATELLITE #1: Artscience Museum, Singapore SATELLITE #2: Silverstone Interactive Museum, UK SATELLITE #3: Yas Marina Circuit Racing School, UAE

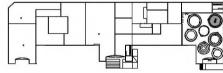
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NOTE

RENDERING: THEME AREA 4

DRAWN BY NAZ ERTUGRUL

EX221.03

SCALE

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CHEN







VENUE

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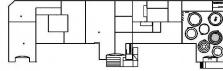
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KEY PLAN



NOTES

RENDERING: THEME AREA 5

DRAWN BY NAZ ERTUGRUL

EX222.01



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J		

The Virtual Miami Grand Prix, Hard Rock Stadium Circuit projected on all the surrounding surfaces. The circuit will change correlating with the exhibition's current location.

DO____

Scan an app clip code to enable the app and follow the arrows on their phones to complete a lap around the virtual Miami GP. By navigating the 4 wheels of the car and participate in a virtual pit stop as a team experience within the activity.

LEARN____

The audience will learn the unique conditions of the track from its engineering to design.

The factual information about the car's components such as the tires and the wings and their importance in a race experience. They will also discover how the track is impacting the conditions of the car as well as the driver's control over the car.



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VENUE

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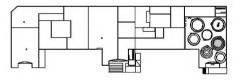
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NOTES

RENDERING: THEME AREA 5

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EX222.02

SCALE













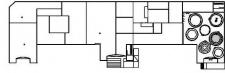
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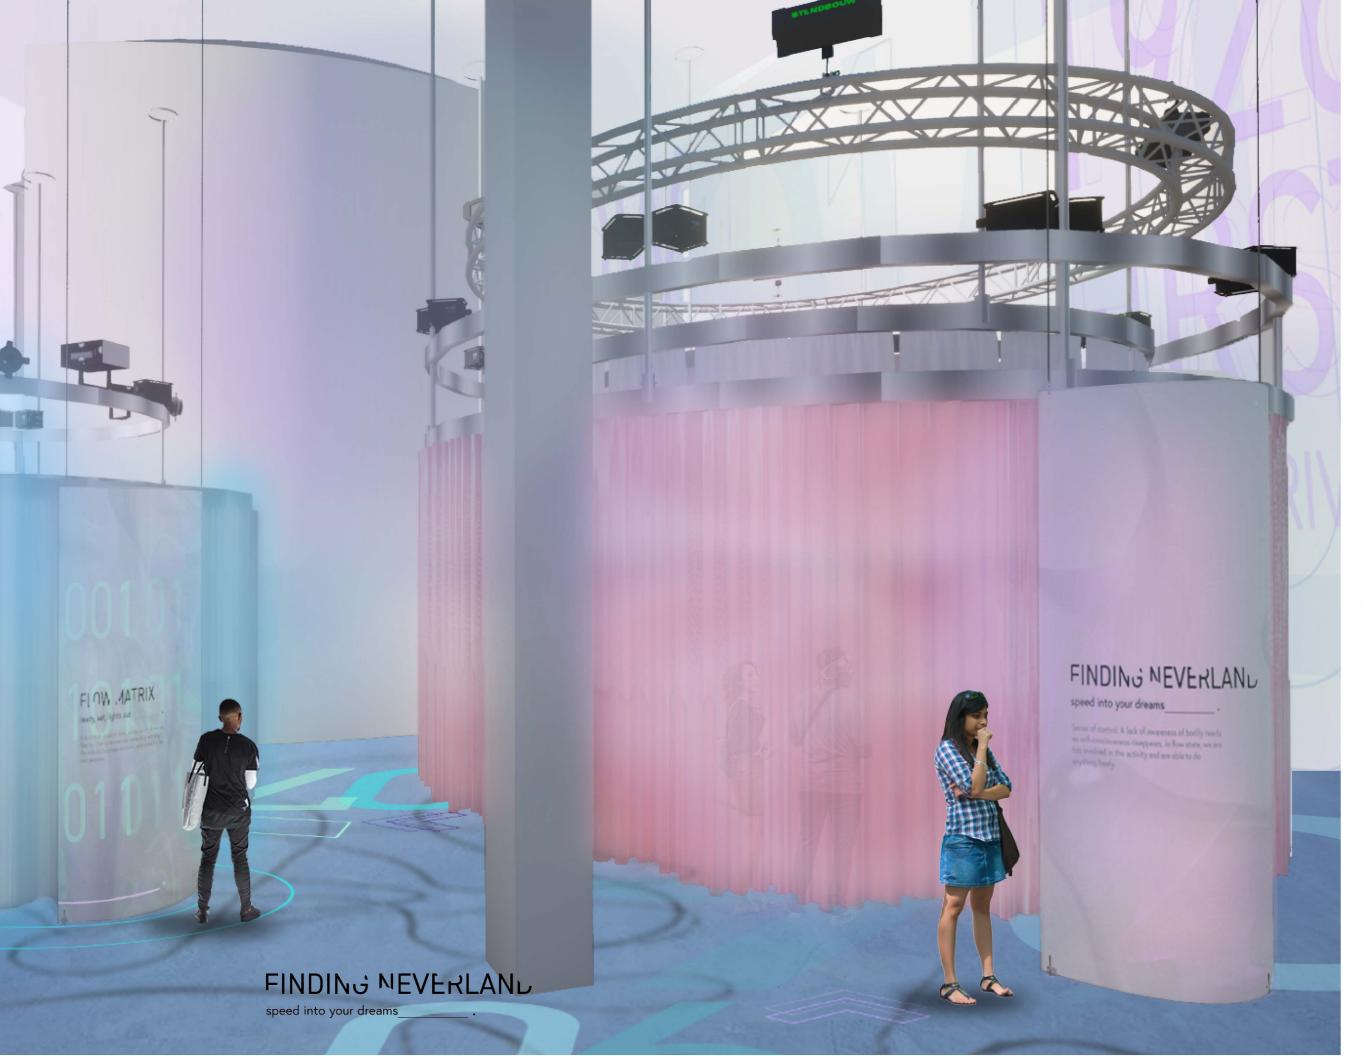


RENDERING: THEME AREA 5

DRAWN BY NAZ ERTUGRUL

EX222.03

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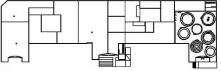
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KEY PL



NOTE

RENDERING: THEME AREA 6

DRAWN BY NAZ ERTUGRUL

EX223.01

CCALE



SEE	
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Moving suspended fabric panels with printed words and quotes from all characters reflecting on their experiences as a female in their respective industries. Also, video projections of the characters' career highlights will be overlayed on the fabric panels.

DO____

Walking inside the perimeter and walking in between layers while witnessing the evolving video poem.

LEARN____

About the challenges, vulnerable moments of the female characters. As well as their motivations and aspirations that they have for their subject field as well as themselves, as individuals.



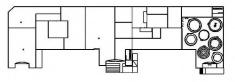




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SATELLITE #3: Yas Marina Circuit Racing

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RENDERING: THEME AREA 6

naz ertugrul

EX223.02







CHEN







VENUE

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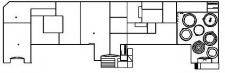
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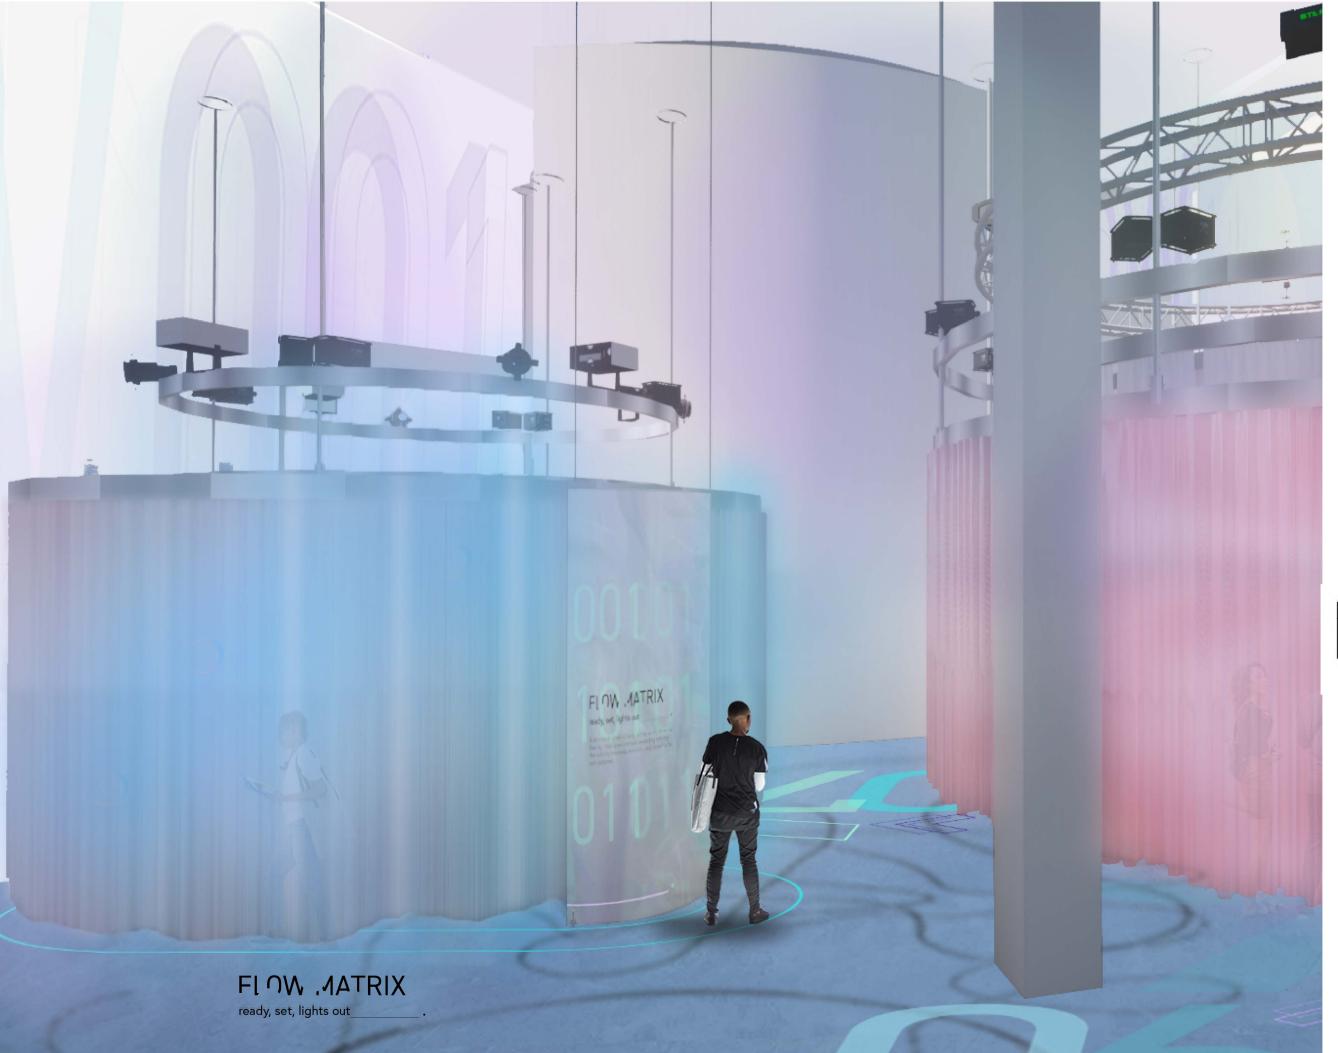
NOTES

RENDERING: THEME AREA 6

DRAWN BY NAZ ERTUGRUL

EX223.03







CHEN







VENUE

MAIN VENUE: Superblue Miami, USA SATELLITE #1: Artscience Museum, Singapore SATELLITE #2: Silverstone Interactive Museum, UK SATELLITE #3: Yas Marina Circuit Racing School, UAE

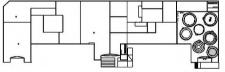
DESIGNER

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KEY PLAN



NOTES

RENDERING: THEME AREA 7

DRAWN BY NAZ ERTUGRUL

EX224.01

CALE N/



SEE

A neon arcade with laser beams creating a literal interpretation of a visual matrix. By adding a message, they will see the changes in the appearance of the matrix by change in its color and form.

DO____

The audience will scan the app clip code guided by the staff which will lead to another app window on their phones to enter an empowering message regarding their journey in this experience, their current feelings and emotions, or inspirations and aspirations. The message that gets entered will be saved in the software system to be broadcasted on the screens of all F1 tracks around the world when the races are taking place.

LEARN____

The audience will get an understanding of the journey that they have been a part of individually is a collective one. In which highlights the idea, that the very first experience to the last it is about active engagement and creating, building towards a collective flow experience that creates a long lasting impact.



CLIEN







VENUE

MAIN VENUE: Superblue Miami, USA SATELLITE #1: Artscience Museum, Singapore SATELLITE #2: Silverstone Interactive Museum, UK SATELLITE #3: Yas Marina Circuit Racing School, UAE

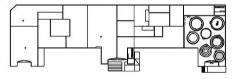
DESIGNER

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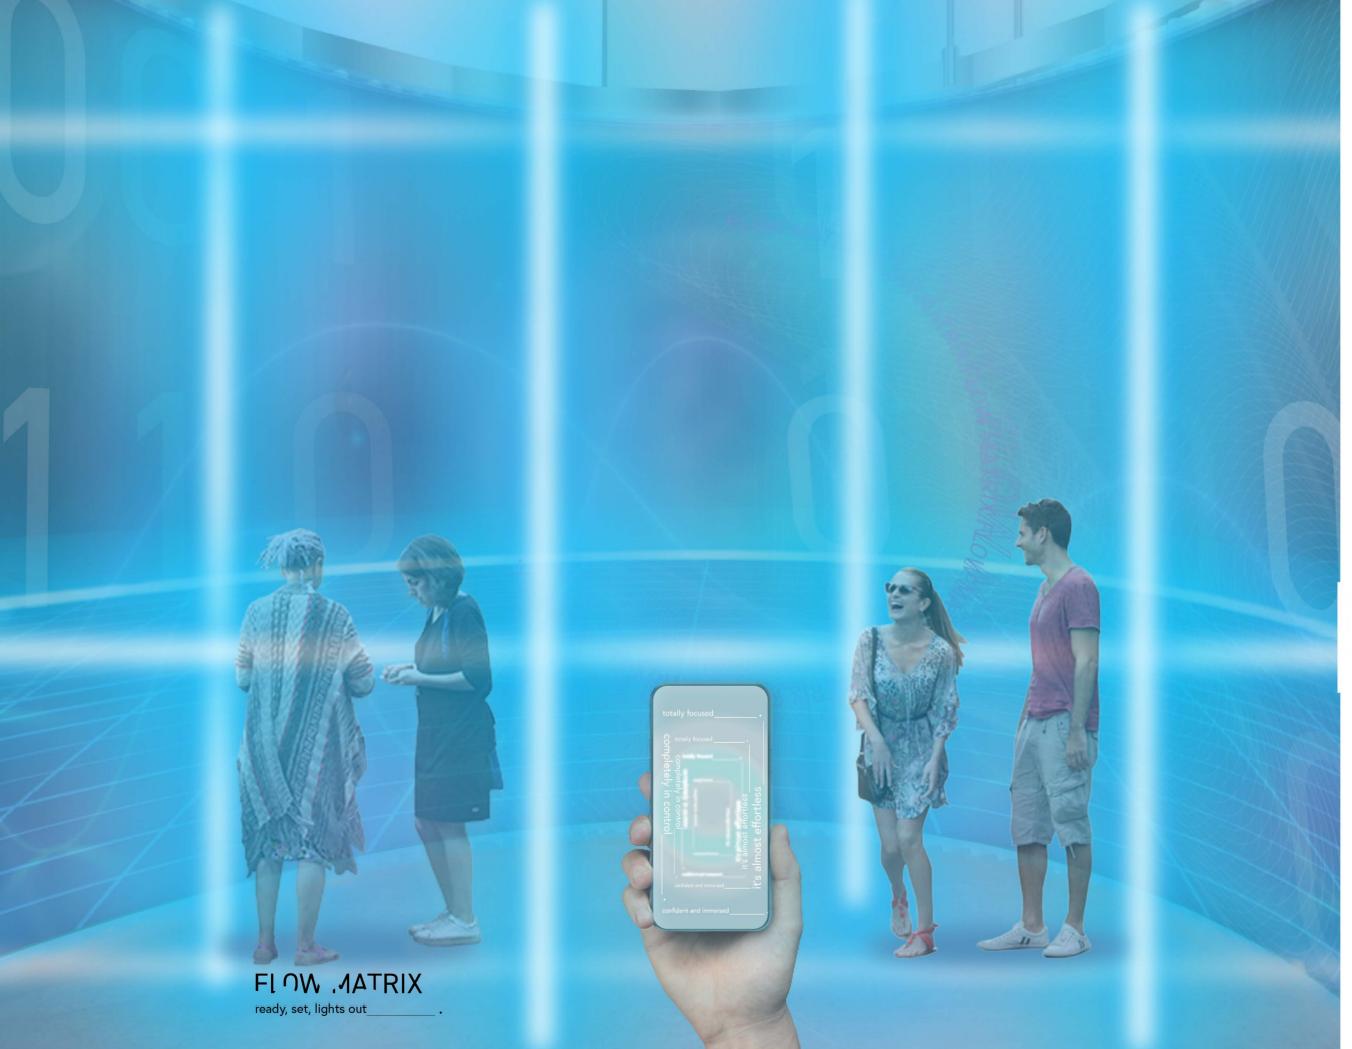
RENDERING: THEME AREA 7

DRAWN BY NAZ ERTUGRUL

EX224.02

SCALE











VENU

MAIN VENUE: Superblue Miami, USA SATELLITE #1: Artscience Museum, Singapore SATELLITE #2: Silverstone Interactive Museum, UK SATELLITE #3: Yas Marina Circuit Racing School, UAE

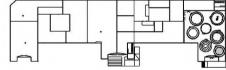
DESIGNER

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KEY PLAN



NOTES

RENDERING: THEME AREA 7

DRAWN BY NAZ ERTUGRUL

EX224.03

SCALE

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VENU

MAIN VENUE: Superblue Miami, USA SATELLITE #1: Artscience Museum, Singapore SATELLITE #2: Silverstone Interactive Museum, UK SATELLITE #3: Yas Marina Circuit Racing School, UAE

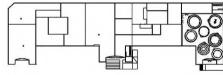
DESIGNER

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KEY PLAN



NOTES

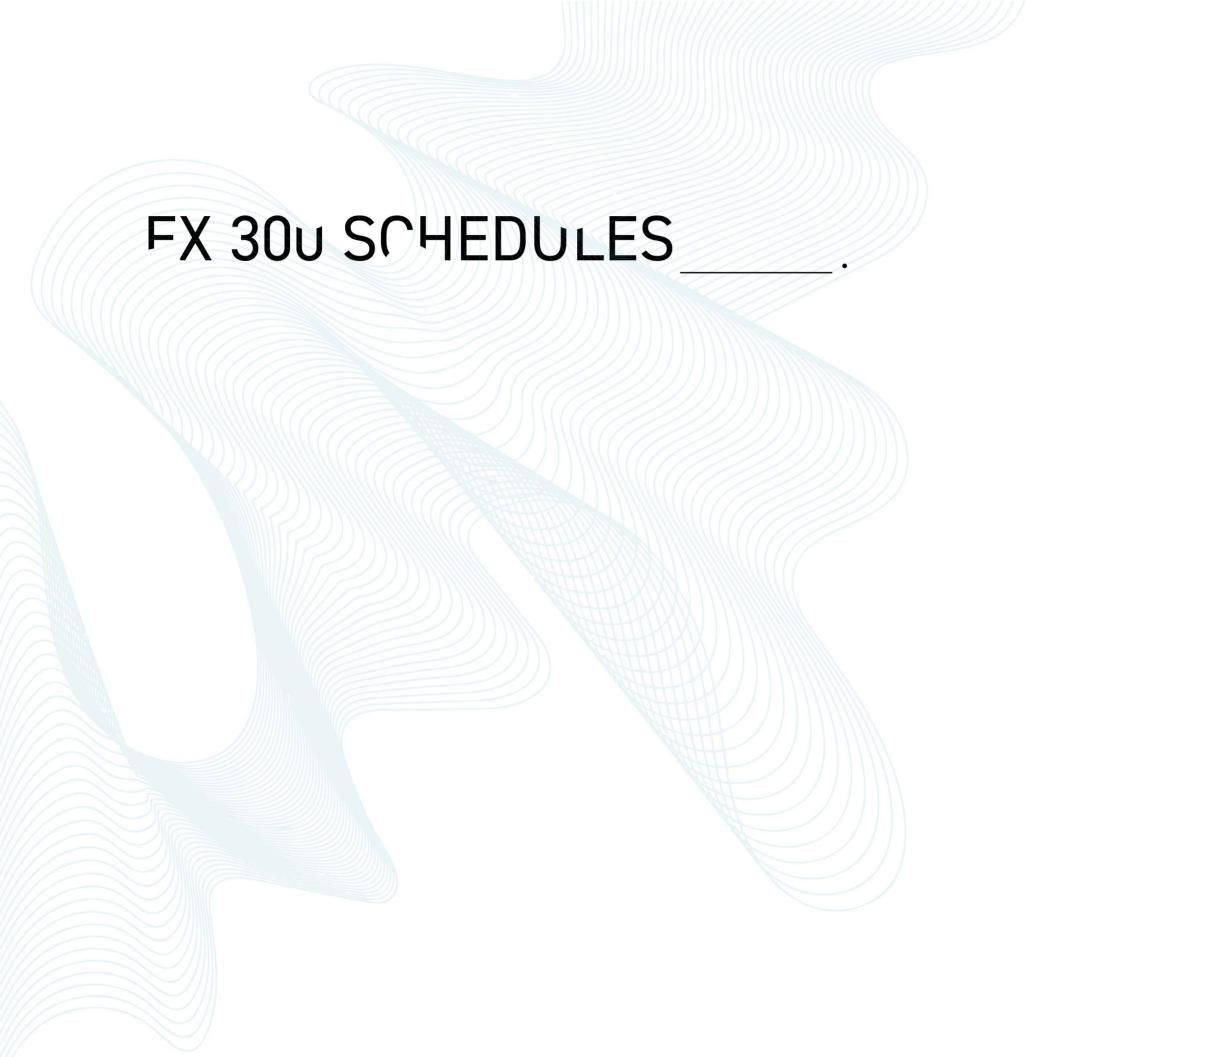
MODEL PHOTOS

DRAWN BY NAZ ERTUGRUL

EX225

SCALE





GRAPHIC SCHEDULE

02A.01.AV01

CODE	GRAPHIC TYPE	DESCRIPTION
01A.01.GR01-02	I	WALL PAINT EXPERIENTIAL INFOGRAPHIC
01A.02.GR01-02	1	WALL PAINT EXPERIENTIAL INFOGRAPHIC
01A.03.GR01-03	A	CUSTOM MOLDED ACRYLIC HEMISPHERE FOR ENTRY INTRODUCTION AREA
01A.04.GR01-03	A	CUSTOM MOLDED ACRYLIC HEMISPHERE FOR ENTRY INTRODUCTION AREA
01A.05.GR01-03	A	CUSTOM MOLDED ACRYLIC HEMISPHERE FOR ENTRY INTRODUCTION AREA
02A.01.GR01-02	В	DIGITAL GRAPHIC DIRECT PRINT FOR AREA INTRODUCTION
02A.02.GR01	G	DIGITAL DESIGN ADHESIVE PVC PRINT FOR WAYFINDING

PROJECTION GRAPHICS ON PLATINUM CURED SILICONE TUBING

C



CLIENT







VENUE

MAIN VENUE: Superblue Miami, USA SATELLITE #1: Artscience Museum, Singapore SATELLITE #2: Silverstone Interactive Museum, UK SATELLITE #3: Yas Marina Circuit Racing School, UAE

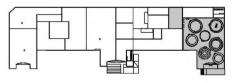
DESIGNER

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KEY PLAN



NOTES

GRAPHIC SCHEDULE

DRAWN BY NAZ ERTUGRUL

EX301.01









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V	EIA	U	_

MAIN VENUE: Superblue Miami, USA SATELLITE #1: Artscience Museum, Singapore SATELLITE #2: Silverstone Interactive Museum, UK SATELLITE #3: Yas Marina Circuit Racing School, UAE

DESIGNER

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KEY PLAN

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NOTES

GRAPHIC SCHEDULE

DRAWN BY NAZ ERTUGRUL

EX301.02

CODE	GRAPHIC TYPE	DESCRIPTION
03A.01.GR01-02	В	DIGITAL GRAPHIC DIRECT PRINT FOR AREA INTRODUCTION
03A.02.GR01-02	D	FROSTED SATIN ICE ACRYLIC SHEET WITH PEEL STICK ADHESIVE VINYL STICKERS FOR LABELS
03A.03.GR01	G	DIGITAL DESIGN ADHESIVE PVC PRINT FOR WAYFINDING
03A.01.MD01	E	DIGITAL INTERACTIVE MEDIA APP GRAPHICS FOR SMARTPHONES
03A.01.MD02	н	DIGITAL INTERACTIVE MEDIA APP GRAPHIC ICONS AND DIRECTIVES FOR SMARTPHONES
03A.01.AV01	С	PROJECTION GRAPHICS ON PLATINUM CURED SILICONE TUBING
04A.01.GR01-02	В	DIGITAL GRAPHIC DIRECT PRINT FOR AREA INTRODUCTION
04A.02.GR01-02	D	FROSTED SATIN ICE ACRYLIC SHEET WITH PEEL STICK ADHESIVE VINYL STICKERS FOR LABEL









WSER

MAIN VENUE: Superblue Miami, USA SATELLITE #1: Artscience Museum, Singapore SATELLITE #2: Silverstone Interactive Museum, UK SATELLITE #3: Yas Marina Circuit Racing School, UAE

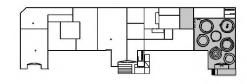
DESIGNER

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KEY PLAN



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DRAWN BY NAZ ERTUGRUL

EX301.03

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CODE	GRAPHIC TYPE	DESCRIPTION
04A.03.GR01	G	DIGITAL DESIGN ADHESIVE PVC PRINT FOR WAYFINDING
04A.01.MD01	E	DIGITAL INTERACTIVE MEDIA APP GRAPHICS FOR SMARTPHONES
04A.01.MD02	н	DIGITAL INTERACTIVE MEDIA APP GRAPHIC ICONS AND DIRECTIVES FOR SMARTPHONES
04A.01.AV01	С	PROJECTION GRAPHICS ON PLATINUM CURED SILICONE TUBING
05A.01.GR01-02	В	DIGITAL GRAPHIC DIRECT PRINT FOR AREA INTRODUCTION
05A.02.GR01-02	D	FROSTED SATIN ICE ACRYLIC SHEET WITH PEEL STICK ADHESIVE VINYL STICKERS FOR LABEL
05A.03.GR01	G	DIGITAL DESIGN ADHESIVE PVC PRINT FOR WAYFINDING
05A.01.MD01	E	DIGITAL INTERACTIVE MEDIA APP GRAPHICS FOR SMARTPHONES









A	N SERIES
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MAIN VENUE: Superblue Miami, USA SATELLITE #1: Artscience Museum, Singapore SATELLITE #2: Silverstone Interactive Museum, UK SATELLITE #3: Yas Marina Circuit Racing School, UAE

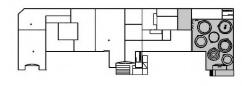
DESIGNER

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KEY PLAN



NOTES

GRAPHIC SCHEDULE

DRAWN BY NAZ ERTUGRUL

EX301.04

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CODE	GRAPHIC TYPE	DESCRIPTION
05A.01.MD02	Н	DIGITAL INTERACTIVE MEDIA APP GRAPHIC ICONS AND DIRECTIVES FOR SMARTPHONES
05A.01.AV01	С	PROJECTION GRAPHICS ON PLATINUM CURED SILICONE TUBING
06A.01.GR01-02	В	DIGITAL GRAPHIC DIRECT PRINT FOR AREA INTRODUCTION
06A.02.GR01-02	D	FROSTED SATIN ICE ACRYLIC SHEET WITH PEEL STICK ADHESIVE VINYL STICKERS FOR LABEL
06A.03.GR01	G	DIGITAL DESIGN ADHESIVE PVC PRINT FOR WAYFINDING
06A.01.MD01	E	DIGITAL INTERACTIVE MEDIA APP GRAPHICS FOR SMARTPHONES
06A.01.MD02	Н	DIGITAL INTERACTIVE MEDIA APP GRAPHIC ICONS AND DIRECTIVES FOR SMARTPHONES
06A.01.AV01	С	PROJECTION GRAPHICS ON PLATINUM CURED SILICONE TUBING

GRAPHIC SCHEDULE

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VENUE

MAIN VENUE: Superblue Miami, USA SATELLITE #1: Artscience Museum, Singapore SATELLITE #2: Silverstone Interactive Museum, UK SATELLITE #3: Yas Marina Circuit Racing School, UAE

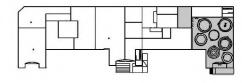
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KEY PLAN



NOTES

GRAPHIC SCHEDULE

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EX301.05

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CODE	GRAPHIC TYPE	DESCRIPTION
07A.01.GR01-02	В	DIGITAL GRAPHIC DIRECT PRINT FOR AREA INTRODUCTION
07A.02.GR01	G	DIGITAL DESIGN ADHESIVE PVC PRINT FOR WAYFINDING
07A.03.GR01-02	F	DIGITAL GRAPHIC DIRECT PRINT ON WHITE POWER MESH FABRIC FOR MURAL
07A.04.GR01-02	D	FROSTED SATIN ICE ACRYLIC SHEET WITH PEEL STICK ADHESIVE VINYL STICKERS FOR LABEL
07A.01.AV01	C	PROJECTION GRAPHICS ON WHITE POWER MESH FABRIC FOR MURAL
08A.01.GR01-02	В	DIGITAL GRAPHIC DIRECT PRINT FOR AREA INTRODUCTION
08A.02.GR01-02	D	FROSTED SATIN ICE ACRYLIC SHEET WITH PEEL STICK ADHESIVE VINYL STICKERS FOR LABEL
08A.03.GR01	G	DIGITAL DESIGN ADHESIVE PVC PRINT FOR WAYFINDING







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W SERIES	

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MAIN VENUE: Superblue Miami, USA SATELLITE #1: Artscience Museum, Singapore SATELLITE #2: Silverstone Interactive Museum, UK SATELLITE #3: Yas Marina Circuit Racing School, UAE

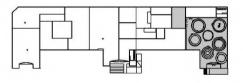
DESIGNER

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NOTES

GRAPHIC SCHEDULE

DRAWN BY NAZ ERTUGRUL

EX301.06

SCALE N/A

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CODE	GRAPHIC TYPE	DESCRIPTION
08A.01.MD01	E	DIGITAL INTERACTIVE MEDIA APP GRAPHICS FOR SMARTPHONES
08A.01.MD02	н	DIGITAL INTERACTIVE MEDIA APP GRAPHIC ICONS AND DIRECTIVES FOR SMARTPHONES
08A.01.AV01	С	PROJECTION GRAPHICS ON PLATINUM CURED SILICONE TUBING
09A.01.GR01-02	I	WALL PAINT EXPERIENTIAL INFOGRAPHIC
09A.02.GR01-02	1	WALL PAINT EXPERIENTIAL INFOGRAPHIC
09A.03.GR01-02	1	WALL PAINT EXPERIENTIAL INFOGRAPHIC
09A.04.GR01-02	1	WALL PAINT EXPERIENTIAL INFOGRAPHIC

GRAPHIC SCHEDULE

CODE	GRAPHIC TYPE	DESCRIPTION
09A.05.GR01	G	DIGITAL DESIGN ADHESIVE PVC PRINT FOR WAYFINDING
09A.06.GR01	G	DIGITAL DESIGN ADHESIVE PVC PRINT FOR WAYFINDING
09A.07.GR01	G	DIGITAL DESIGN ADHESIVE PVC PRINT FOR WAYFINDING
09A.01.MD01	E	DIGITAL INTERACTIVE MEDIA APP GRAPHICS FOR SMARTPHONES



CLIENT







VENUE

MAIN VENUE: Superblue Miami, USA SATELLITE #1: Artscience Museum, Singapore SATELLITE #2: Silverstone Interactive Museum, UK SATELLITE #3: Yas Marina Circuit Racing School, UAE

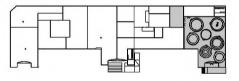
DESIGNER

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KEY PLAN



NOTES

GRAPHIC SCHEDULE

DRAWN BY NAZ ERTUGRUL

EX301.07

N/A

SCALE



GRAPHIC SPECIFICATION LIST

GRAPHIC TYPE	DESCRIPTION
A: ENTRY GRAPHICS	CUSTOM MOLDED ACRYLIC HEMISPHERE WITH A 4" THICK CLEAR NON-GLARE EXTRUDED ACRYLIC WEIGHTED BASE FABRICATOR TO ADVISE, MOUNTED WITH 1" THICK LASER CUT ACRYLITE SATINICE ACRYLIC SHEETS AND WITH SECOND SURFACE MOUNTED SOLYX DICHROIC POLYESTER FILM AND PEEL STICK ADHESIVE VINYL STICKER
B: AREA INTRODUCTION	CUSTOM HIGH RES DIGITAL GRAPHIC DIRECT PRINT ON VOLANDO VOILE SEMI SHEER FABRIC, STRETCHED WITH STAINLESS STEEL FABRIC WEIGHTS, SUPPORTED WITH SCULPTING WIRE SEWN AT THE HEM FOR A CURVED FRAME OUTLINE, AND SUSPENDED WITH STEEL CABLE STRING
C: PROJECTION GRAPHICS	PROJECTION GRAPHICS ON PLATINUM CURED SILICONE TUBING
D: LABELS	LASER CUT TO SIZE 1/8" THICK FROSTED SATIN ICE ACRYLIC SHEET WITH SECOND SURFACE MOUNTED SOLYX DICHROIC POLYESTER FILM AND PEEL STICK ADHESIVE VINYL STICKERS, MOUNTED ON TO THE FABRIC WITH 3M DISC MAGNETS
E: INTERACTIVE MEDIA APP	DIGITAL INTERACTIVE MEDIA APP GRAPHICS FOR SMARTPHONES
F: MURAL	CUSTOM HIGH RES DIGITAL GRAPHIC DIRECT PRINT ON WHITE POWER MESH FABRIC, STRETCHED WITH FABRIC TAPE FOR FLAT FRAME OUTLINE
G: WAYFINDING	STREETWRAP CUSTOM DIGITAL DESIGN ADHESIVE PVC PRINT ON THE GROUND
H: INTERACTIVE MEDIA DIRECTIVES	DIGITAL INTERACTIVE MEDIA APP GRAPHIC ICONS AND DIRECTIVES FOR SMARTPHONES
I: EXPERIENTIAL INFOGRAPHICS	BENJAMIN MOORE STANDARD FINISH WALL PAINT TO MATCH COLOR PALETTE:

PANTONE VIOLET 0631 C, PANTONE VIOLET U, PANTONE VIOLET C, PANTONE GREEN 0921 C,

PANTONE 319 C, PANTONE 263 C, 319 C,304 C, PANTONE WHITE, PANTONE 7458C, PANTONE 276 C(NAVY BLUE), PANTONE 182 C %80 AND %100 OPACITY



CLIENT







VENUE

MAIN VENUE: Superblue Miami, USA SATELLITE #1: Artscience Museum, Singapore SATELLITE #2: Silverstone Interactive Museum, UK SATELLITE #3: Yas Marina Circuit Racing School, UAE

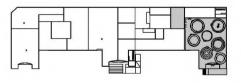
DESIGNER

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KEY PLAN



NOTES

GRAPHIC SPEC LIST

DRAWN BY NAZ ERTUGRUL

EX302

SCALE





						, OVV.
 MATERIAL	CODE	DESCRIPTION	FINISH	LOCATION	THUMBNAIL	CLIENT
FABRIC	FB.01	IRIDESCENT STAINLESS STEEL FABRIC	IRIDESCENT	OUTER ROUND CURTAIN THEME AREA 4		VENUE VENUE
FABRIC	FB.02	ALUMINUM DRAPERY CHAIN	POLISHED	OUTER ROUND CURTAIN THEME AREA 5		MAIN VENUE: Superblue Miami, SATELLITE #1: Artscience Muser SATELLITE #2: Silverstone Inter- Museum, UK SATELLITE #3: Yas Marina Circu School, UAE DESIGNER Naz Ertugrul 309 5th Ave New York, NY
FABRIC	FB.03	SILVER MIRROR ORGANZA	MIRROR	INNER ROUND CURTAIN THEME AREA 5		DISCLAIMER These drawings represent concurrence are not intended to be used for construction purposes. This is a
FABRIC	FB.04	POWER MESH FABRIC	WHITE	ROUND CURTAIN PANELS THEME AREA 2 & 6		unpublished and proprietary wo simultaneously protected under trade secret and like laws of the States and other countries. All r reserved. These materials may r reproduced, displayed, distribut may the information herein be u disclosed in whole or in part, wi express written permission of N Ertugrul.
FABRIC	FB.05	SHEER ORGANZA FABRIC	DUSTY SAGE	OUTER ROUND CURTAIN THEME AREA 1		KEY PLAN
FABRIC	FB.06	SHEER ORGANZA FABRIC	PURPLE	OUTER ROUND CURTAIN THEME AREA 3		NOTES
FABRIC	FB.07	VIOLET AMETHYST SILK STRING	AMETHYST	OUTER ROUND CURTAIN THEME AREA 7		
FABRIC	FB.08	SHEER ORGANZA FABRIC	PINK	OUTER ROUND CURTAIN THEME AREA 6		MATERIAL SCHE
FABRIC	FB.09	CUSTOM PRINTED VOLANDO VOILE FABRIC	SEMI SHEER CUSTOM PRINT	OUTER ROUND CURTAIN ALL THEME AREAS		SCALE N/A

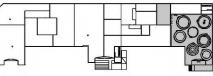






Superblue Miami, USA Artscience Museum, Singapore Silverstone Interactive Yas Marina Circuit Racing

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L SCHEDULE





MATERIAL	CODE	DESCRIPTION	FINISH	LOCATION	THUMBNAIL	CLIENT
FABRIC TAPE	FT.01	CURTAIN LEAD TAPE	N/A	ROUND CURTAIN HEM THEME AREA 2 & 6		VENUE
PLASTIC	PL.01	PLATINUM CURED SILICONE TUBING	SILICONE	INNER ROUND CURTAIN THEME AREA 1,3,4,5,7		MAIN VENUE: Superblue Miami, USA SATELLITE #1: Artscience Museum, Singapore SATELLITE #2: Silverstone Interactive Museum, UK SATELLITE #3: Yas Marina Circuit Racing School, UAE DESIGNER Naz Ertugrul 309 5th Ave New York, NY
PLASTIC	PL.02	CUSTOM MOLDED ACRYLIC HEMISPHERE	CLEAR ACRYLIC	DOME, 3D PRINT CAR BASE THEME AREA INTRODUCTION,4		DISCLAIMER These drawings represent concepts and are not intended to be used for construction purposes. This is an
PLASTIC	PL.03	CLEAR NON-GLARE EXTRUDED ACRYLIC SHEET	CLEAR	DOME BASE THEME AREA INTRODUCTION		unpublished and proprietary work simultaneously protected under copyright, trade secret and like laws of the United States and other countries. All rights reserved. These materials may not be reproduced, displayed, distributed nor may the information herein be used or disclosed in whole or in part, without the express written permission of Naz Ertugrul.
PLASTIC	PL.04	ACRYLITE SATINICE ACRYLIC SHEET	СОМ	DOME THEME AREA INTRODUCTION		KEY PLAN
PLASTIC	PL.05	SOLYX DICHROIC POLYESTER FILM	DICHROIC	DOME SHELL THEME AREA INTRODUCTION		NOTES
PLASTIC	PL.06	SOLYX DICHROIC POLYESTER FILM	DICHROIC	LABELS THEME AREA 6		
PLASTIC	PL.07	FROSTED SATIN ICE ACRYLIC SHEET	SATIN ICE	LABELS THEME AREA 6		MATERIAL SCHEDULE DRAWN BY NAZ ERTUGRUL EX303.02
						SCALE N/A N

CLEAR ACRYLIC

PLASTIC

PL.08

BLIND FASTENERS DOME NUMBER MOUNTING THEME AREA INTRODUCTION

П	W.
8	VV.

MATERIAL	CODE	DESCRIPTION	FINISH	LOCATION	THUMBNAIL
PLASTIC	PL.09	CUSTOM DIGITAL DESIGN ADHESIVE PRINT	PVC	FLOOR GRAPHIC ALL THEME AREAS	
PLASTIC	PL.10	PEEL AND STICK ADHESIVE VINYL	VINYL	DOME AND LABELS THEME AREA INTRODUCTION, 6	36" Adhesive Vinyl
PAINT	PT.01	BENJAMIN MOORE STANDARD FINISH WALL PAINT	STANDARD CLM PANTONE VIOLET 0631C	INTERIOR WALLS THEME AREA INTRODUCTION	
PAINT	PT.02	BENJAMIN MOORE STANDARD FINISH WALL PAINT	STANDARD CLM PANTONE COOL GRAY 1C	INTERIOR WALLS THEME AREA INTRODUCTION	
PAINT	PT.03	BENJAMIN MOORE STANDARD FINISH WALL PAINT	STANDARD CLM PANTONE PANTONE VIOLET C	INTERIOR WALLS ALL THEME AREAS	
PAINT	PT.04	BENJAMIN MOORE STANDARD FINISH WALL PAINT	STANDARD CLM PANTONE VIOLET U	INTERIOR WALLS ALL THEME AREAS	
PAINT	PT.05	BENJAMIN MOORE STANDARD FINISH WALL PAINT	STANDARD CLM PANTONE GREEN 0921	INTERIOR WALLS ALL THEME AREAS	
PAINT	PT.06	BENJAMIN MOORE STANDARD FINISH WALL PAINT	STANDARD CLM PANTONE 319 C	INTERIOR WALLS ALL THEME AREAS	







VENUE

MAIN VENUE: Superblue Miami, USA SATELLITE #1: Artscience Museum, Singapore SATELLITE #2: Silverstone Interactive Museum, UK SATELLITE #3: Yas Marina Circuit Racing School, UAE

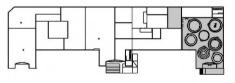
DESIGNER

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KEY PLAN



NOTES

MATERIAL SCHEDULE

DRAWN BY NAZ ERTUGRUL

EX303.03



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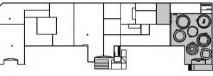
MATERIAL	CODE	DESCRIPTION	FINISH	LOCATION	THUMBNAIL	CLIENT
PAINT	PT.07	BENJAMIN MOORE STANDARD FINISH WALL PAINT	STANDARD CLM PANTONE 263C	INTERIOR WALLS ALL THEME AREAS		VENUE
PAINT	PT.08	BENJAMIN MOORE STANDARD FINISH WALL PAINT	STANDARD CLM PANTONE 276C	INTERIOR WALLS THEME AREA INTRODUCTION		MAIN VENUE: Su SATELLITE #1: Ar SATELLITE #2: Si Museum, UK SATELLITE #3: Ye School, UAE DESIGNER Naz Ertugrul 309 5th Ave
PAINT	PT.09	BENJAMIN MOORE STANDARD FINISH WALL PAINT	STANDARD CLM PANTONE WHITE	INTERIOR WALLS THEME AREA INTRODUCTION		New York, NY DISCLAIMER These drawings r are not intended construction purp
PAINT	PT.10	BENJAMIN MOORE STANDARD FINISH WALL PAINT	STANDARD CLM PANTONE 304C	INTERIOR WALLS ALL THEME AREAS		unpublished and simultaneously putrade secret and States and other reserved. These reproduced, displemay the informat disclosed in whole express written putrugrul.
PAINT	PT.11	BENJAMIN MOORE STANDARD FINISH WALL PAINT	STANDARD CLM PANTONE 7458C	INTERIOR WALLS ALL THEME AREAS		KEY PLAN
PAINT	PT.12	BENJAMIN MOORE STANDARD FINISH WALL PAINT	STANDARD CLM PANTONE 182C	INTERIOR WALLS ALL THEME AREAS		NOTES
METAL	ML.01	STEEL CABLE STRING	STEEL	HANGING FABRIC ALL THEME AREAS		
METAL	ML.02	METAL DRAPERY GROMMETS	SATIN MATTE	HANGING FABRIC ALL THEME AREAS	2"	MATERIAL DRAWN BY NAZ E





E: Superblue Miami, USA †1: Artscience Museum, Singapore †2: Silverstone Interactive 3: Yas Marina Circuit Racing

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IAL SCHEDULE

NAZ ERTUGRUL

EX303.04



THUMBNAIL	

ALL THEME AREAS

MATERIAL	CODE	DESCRIPTION	FINISH	LOCATION	THUMBNAIL
METAL	ML.03	STAINLESS STEEL HOOKED WEIGHTS	STAINLESS STEEL	STRETCHING FABRIC ALL THEME AREAS	
METAL	ML.04	3M NEODYMIUM DISC MAGNETS	NEODYMIUM	MOUNTING LABELS THEME AREA 6	
METAL	ML.05	ALUMINUM EXTRUSION FMS CURTAIN TRACK	CUSTOM POWDER COAT	ROUND CURTAIN ALL THEME AREAS	
METAL	ML.06	MTS METAL HOOK	ALUMINUM	ROUND CURTAIN ALL THEME AREAS	
METAL	ML.07	MTS SUSPENSION ROD	ALUMINUM	ROUND CURTAIN ALL THEME AREAS	
METAL	ML.08	MTS CEILING BRACKET	ALUMINUM	ROUND CURTAIN ALL THEME AREAS	
METAL	ML.09	MTS TRACK BRIDGE	ALUMINUM	ROUND CURTAIN ALL THEME AREAS	
METAL	ML.10	MTS TRACK	ALUMINUM	ROUND CURTAIN	

BRIDGE



CLIENT







VENU

MAIN VENUE: Superblue Miami, USA SATELLITE #1: Artscience Museum, Singapore SATELLITE #2: Silverstone Interactive Museum, UK SATELLITE #3: Yas Marina Circuit Racing School, UAE

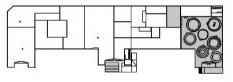
DESIGNER

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KEY PLAN



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MATERIAL SCHEDULE

DRAWN BY NAZ ERTUGRUL

EX303.05



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VENUE

MAIN VENUE: Superblue Miami, USA SATELLITE #1: Artscience Museum, Singapore SATELLITE #2: Silverstone Interactive Museum, UK SATELLITE #3: Yas Marina Circuit Racing School, UAE

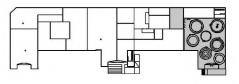
DESIGNER

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KEY PLAN



NOTES

MATERIAL SCHEDULE

DRAWN BY NAZ ERTUGRUL

EX303.06

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SCALE N/A

MATERIAL	CODE	DESCRIPTION	1111311	LOCATION	HIOMBINALE
METAL	ML.11	FOREST SHUTTLE M MOTOR 24 V DC	CUSTOM POWDER COAT	ROUND CURTAIN ALL THEME AREAS	
METAL	ML.12	FMS TRANSPORTER BELT	SILVER	ROUND CURTAIN ALL THEME AREAS	
METAL	ML.13	CEILING GRID FIRECODE CROSS TEE	GALVANIZED STEEL	SUSPENDED CEILING ALL THEME AREAS	
METAL	ML.14	CEILING GRID FIRECODE MAIN TEE	GALVANIZED STEEL	SUSPENDED CEILING ALL THEME AREAS	
METAL	ML.15	PERFORATED CEILING TILE	ALUMINUM	ROUND CURTAIN ALL THEME AREAS	
METAL	ML.16	FABRIC SCULPTING WIRE	ALUMINUM	ROUND CURTAIN ALL THEME AREAS	
METAL	ML.17	CUSTOM ROUND TRUSS & SUSPENSION RODS	STEEL	ROUND CURTAIN ALL THEME AREAS	

FINISH

STEEL

LOCATION

ROUND CURTAIN

ALL THEME AREAS

THUMBNAIL

DESCRIPTION

CUSTOM

LINEAR TRUSS &

SUSPENSION ROD

MATERIAL

METAL

CODE

ML.10

MATERIAL	CODE	DESCRIPTION	FINISH	LOCATION	THUMBNAIL
FURNITURE	FR.01	BUMPER OTTOMAN L	LILAC	SEATING ALL THEME AREAS	
FURNITURE	FR.02	BUMPER OTTOMAN XL	LILAC	SEATING ALL THEME AREAS	
FURNITURE	FR.03	PUFF PUFF BENCH	EDWARDS LIGHT GREY	SEATING ALL THEME AREAS	Ī Į
FURNITURE	FR.04	NOIR SQUARE INDOOR/OUTDOOR PIPED FLOOR PILLOW	NOIR	ROUND CURTAIN THEME AREA 1	
FURNITURE	FR.05	LARGE COTTON CUSHION ROUND BEAN BAG	BLACK	ROUND CURTAIN THEME AREA 2	460
ACCESSORY OBJECT	OBJ.01	XOMETRY CUSTOM 3D PRINTED F1 CAR	WHITE	ACCESORY THEME AREA 4	150 ST









VENUE

MAIN VENUE: Superblue Miami, USA SATELLITE #1: Artscience Museum, Singapore SATELLITE #2: Silverstone Interactive Museum, UK SATELLITE #3: Yas Marina Circuit Racing School, UAE

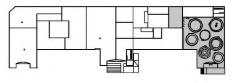
DESIGNER

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NOTES

MATERIAL SCHEDULE

DRAWN BY NAZ ERTUGRUL

N/A

EX303.07

SCALE

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CODE	TYPE	DESCRIPTION	MANUFACTURER	LOCATION	THUMBNAIL	CLIENT
AV.01	SOUND DOME	WIDE DISPERSION LOCALIZER SOUND DOME	BROWN INNOVATIONS	ROUND CURTAIN THEME AREA 2	1	TIERES (INC.)
AV.02	SOUND DOME	SINGLE LOCALIZER SOUND DOME	BROWN INNOVATIONS	ROUND CURTAIN THEME AREA INTRODUCTION	1	MAIN VENUE: Superblue Miami, USA SATELLITE #1: Artscience Museum, Singapore SATELLITE, Silverstone Interactive Museum, UK SATELLITE #3: Yas Marina Circuit Racing School, UAE DESIGNER Naz Ertugrul 309 5th Ave New York, NY
AV.03	LASER PROJECTOR	DLP LASER LARGE VENUE 31K LUMENS PROJECTOR	BARCO	ROUND CURTAIN THEME AREA 1,2,3,4,5,7		DISCLAIMER These drawings represent concepts and
AV.04	SPEAKER	X-8 HIGH FIDELITY POINT SOURCE SPEAKER	L-ACOUSTICS	ROUND CURTAIN THEME AREA 1,3,4,5,6,7		are not intended to be used for construction purposes. This is an unpublished and proprietary work simultaneously protected under copyright, trade secret and like laws of the United States and other countries. All rights reserved. These materials may not be reproduced, displayed, distributed nor may the information herein be used or disclosed in whole or in part, without the express written permission of Naz Ertugrul.
AV.05	SPEAKER	5XT POINT SOURCE SPEAKER	L-ACOUSTICS	ROUND CURTAIN THEME AREA 1,3,4,5,6,7		KEY PLAN
AV.06	AMPLIFIED CONTROLLER	LA4X AMPLIFIED CONTROLLER	L-ACOUSTICS	ROUND CURTAIN THEME AREA 1,3,4,5,6,7		NOTES NOTES
AV.07	AUDIO PROCESSOR	L-ISA MULTICHANNEL AUDIO PROCESSOR	L-ACOUSTICS	ROUND CURTAIN THEME AREA 1,3,4,5,6,7		
AV.08	PROJECTION MAPPING PROJECTOR	T2 SERIES 3RD GEN INDOOR/OUTDOOR LASER PROJECTOR	LUMITRIX	ROUND CURTAIN THEME AREA 4		AV SCHEDULE DRAWN BY NAZ ERTUGRUL EX304.01

CODE	TYPE	DESCRIPTION	MANUFACTURER	LOCATION	THUMBNAIL
AV.09	HAZE MACHINE	TITAN HAZER H2 1200 W HAZE MACHINE	FROGGY'S FOG	DOME THEME AREA INTRODUCTION	
AV.10	SPARK MACHINE	MK-E12 COLD SPARKLER FOUNTAIN	MOKA SFX	ROUND CURTAIN THEME AREA 4	99 775
AV.11	FOG MACHINE	MK-FO8 HALLOWEEN FOG MACHINE	MOKA SFX	ROUND CURTAIN THEME AREA 4	man of Voted









VENUE

MAIN VENUE: Superblue Miami, USA SATELLITE #1: Artscience Museum, Singapore SATELLITE #2: Silverstone Interactive Museum, UK SATELLITE #3: Yas Marina Circuit Racing School, UAE

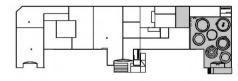
DESIGNER

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KEY PLAN



NOTES

AV SCHEDULE

DRAWN BY NAZ ERTUGRUL

EX304.02



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CODE	TYPE	DESCRIPTION	MANUFACTURER	WATTS	VOLTAGE	THUMBNAIL	CLIENT
L1	LED STROBE LIGHT	9 EYES DMX RGB MOVING STROBE LIGHT	FARGOR	160 WATTS	110 V		VENUE
L2	LED WASH LIGHT	COLOR-ADO 2-QUAD ZOOM LED WASH LIGHT	CHAUVET PROFESSIONAL	201 WATTS	120V		MAIN VENUE: Superblue Miami, USA SATELLITE #1: Artscience Museum, Singapore SATELLITE #2: Silverstone Interactive Museum, UK SATELLITE #3: Yas Marina Circuit Racing School, UAE DESIGNER Naz Ertugrul 309 5th Ave New York, NY
L3	LED SPOT	ETC COLORSOURCE 26° SPOT WITH CUSTOM CURVED SHAPE GOBO	ETC LIGHTING	147 WATTS	120V		DISCLAIMER These drawings represent concepts and are not intended to be used for
L4	LED SPOT	ETC COLORSOURCE 19° SPOT WITH CUSTOM CURVED SHAPE GOBO	ETC LIGHTING	147 WATTS	120V		construction purposes. This is an unpublished and proprietary work simultaneously protected under copyright, trade secret and like laws of the United States and other countries. All rights reserved. These materials may not be reproduced, displayed, distributed nor may the information herein be used or disclosed in whole or in part, without the express written permission of Naz Ertugrul.
L5	GLASS GOBO	ROSCO CUSTOM CURVED SHAPE GLASS GOBO	ROSCO	N/A	N/A		KEY PLAN
L6	LED SPOT	ETC COLORSOURCE 19° SPOT	ETC LIGHTING	147 WATTS	120V		NOTES
L7	LED SPOT	ETC COLORSOURCE 10° SPOT	ETC LIGHTING	147 WATTS	120V		
L8	LED PROJECTOR	ROSCO X-EFFECTS LED PROJECTOR WITH CUSTOM CURVED SHAPE GOBO	ROSCO	90W	100-240 VAC		LIGHTING SCHEDULE DRAWN BY NAZ ERTUGRUL EX305.01 SCALE N/A N









VENUE

MAIN VENUE: Superblue Miami, USA SATELLITE #1: Artscience Museum, Singapore SATELLITE #2: Silverstone Interactive Museum, UK SATELLITE #3: Yas Marina Circuit Racing School, UAE

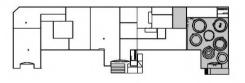
DESIGNER

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KEY PLAN



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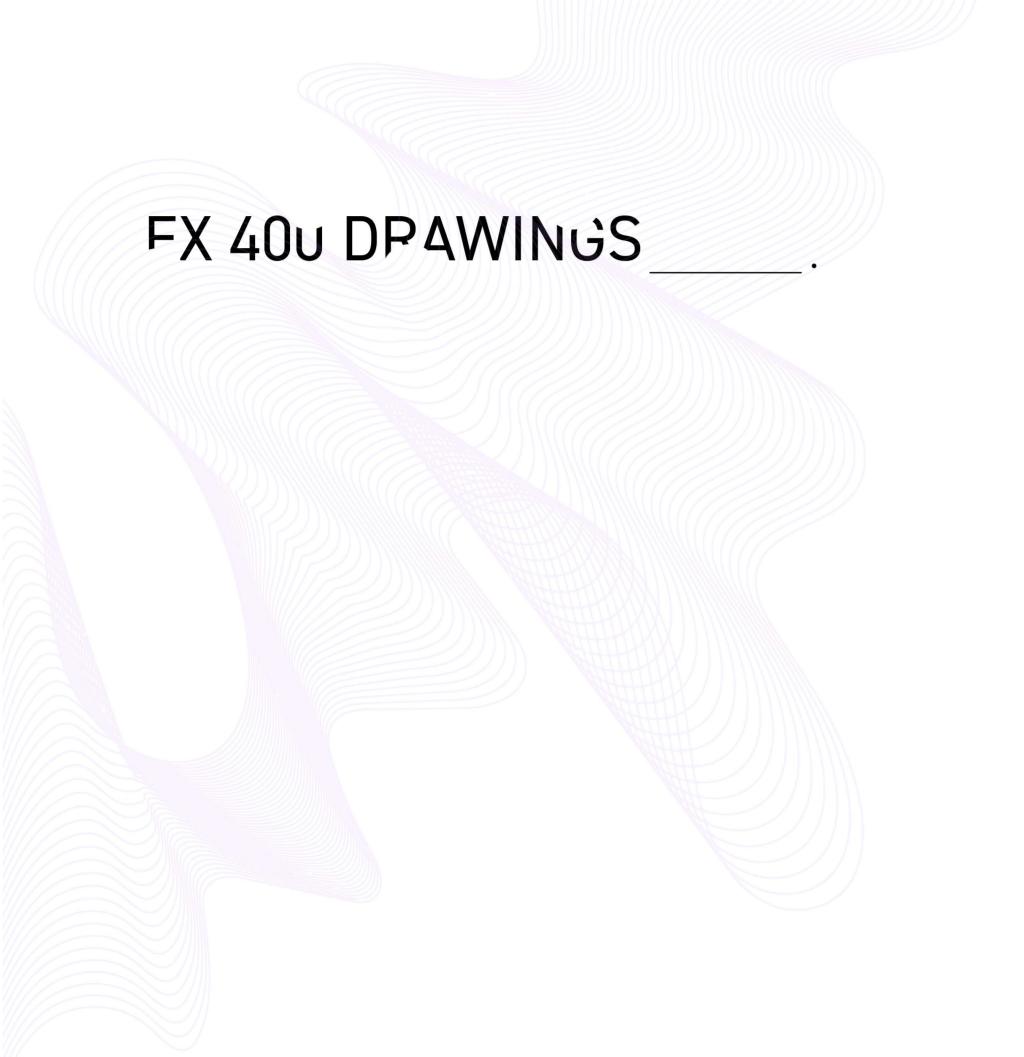
LIGHTING SCHEDULE

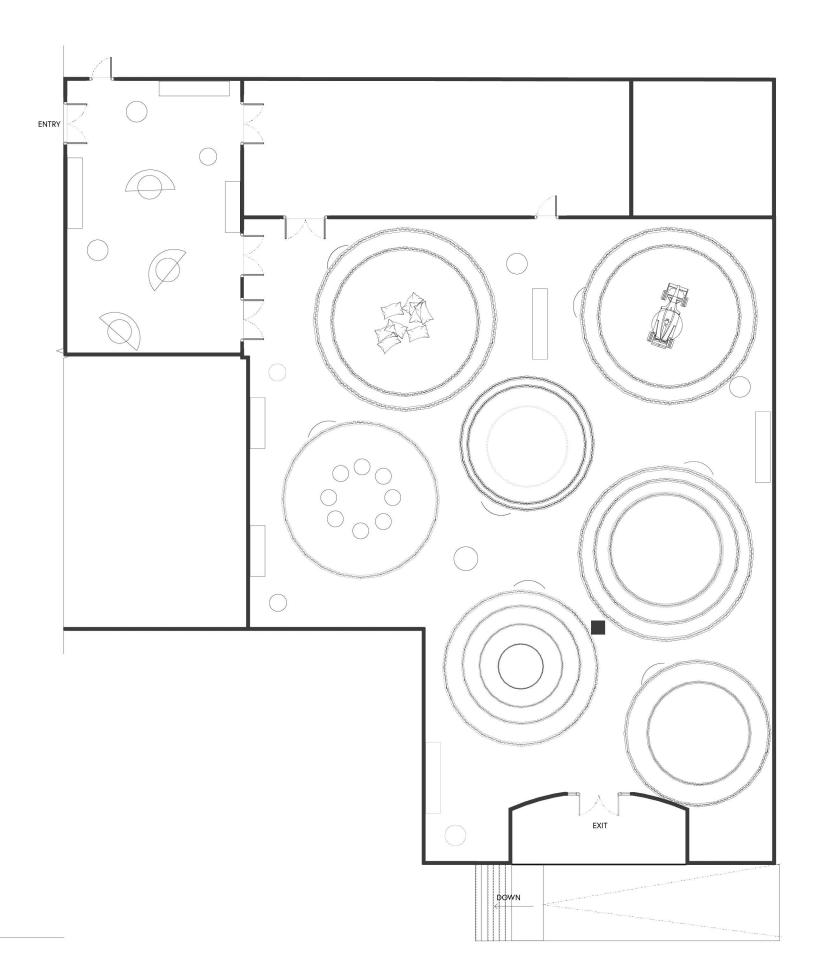
DRAWN BY NAZ ERTUGRUL

EX305.02



CODE	TYPE	DESCRIPTION	MANUFACTURER	WATTS	VOLTAGE	THUMBNAIL
L9	GLASS GOBO	ROSCO CUSTOM CURVED SHAPE GLASS GOBO	ROSCO	N/A	N/A	
L10	GLASS GOBO	ROSCO CUSTOM CURVED SHAPE GLASS GOBOT	ROSCO	N/A	N/A	
L11	GLASS GOBO	ROSCO CUSTOM CURVED SHAPE GLASS GOBO	ROSCO	N/A	N/A	
L12	DMX DIMMER CONTROLLER	CHAUVET DJ DESIGNER 48 CHANNEL DMX DIMMER CONTROLLER	CHAUVET PROFESSIONAL	N/A	115V	





FLOORPLAN: CLOSED SYSTEM SCALE: 1/16"=1'-0"



CLIEN







VENUE

MAIN VENUE: Superblue Miami, USA SATELLITE #1: Artscience Museum, Singapore SATELLITE #2: Silverstone Interactive Museum, UK SATELLITE #3: Yas Marina Circuit Racing School, UAE

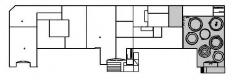
DESIGNER

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KEY PLAN



NOTES

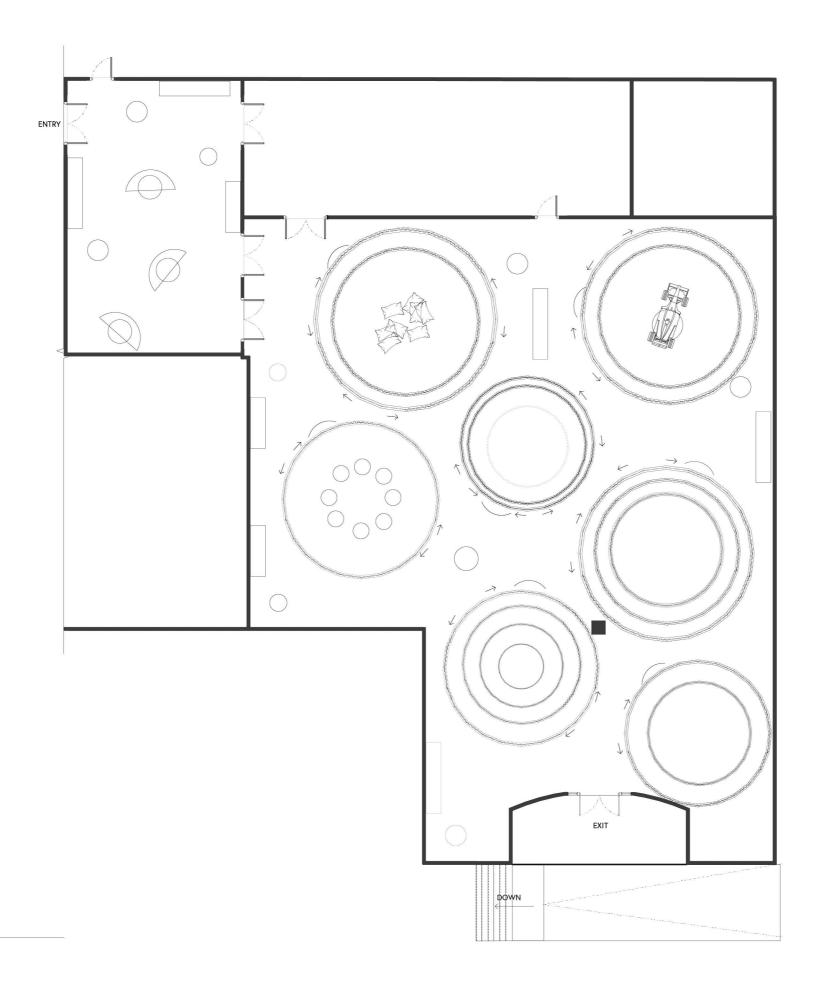
FLOORPLAN

DRAWN BY NAZ ERTUGRUL

EX401

SCALE 1/16"=1'-0"





FLOORPLAN: OPEN SYSTEM
SCALE: 1/16"=1'-0"



CLIEN







VENU

MAIN VENUE: Superblue Miami, USA SATELLITE #1: Artscience Museum, Singapore SATELLITE #2: Silverstone Interactive Museum, UK SATELLITE #3: Yas Marina Circuit Racing School, UAE

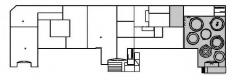
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KEY PLAN



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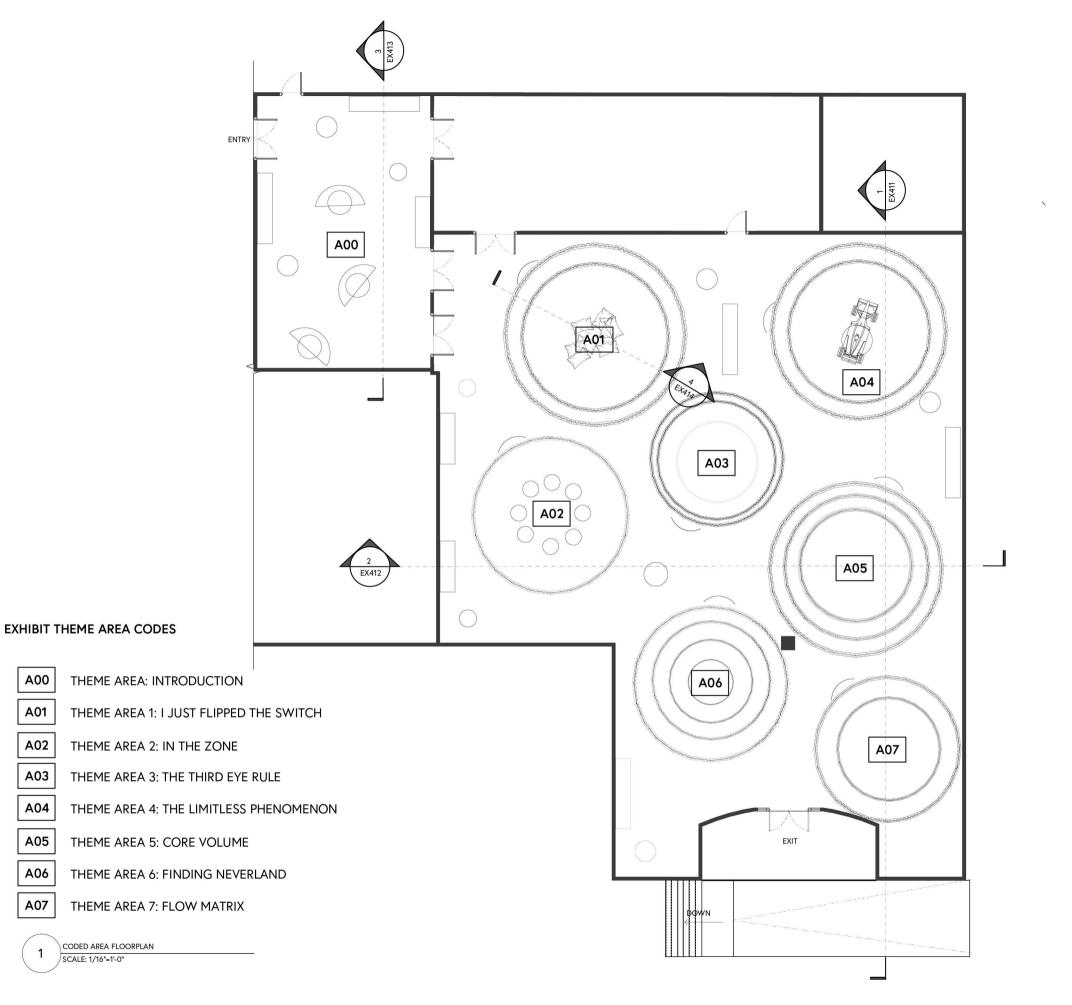
FLOORPLAN

DRAWN BY NAZ ERTUGRUL

EX402

SCALE 1/16"=1'-0"





A00

A01

A02

A03

A04

A05

A06

A07

CODED AREA FLOORPLAN SCALE: 1/16"=1'-0"









MAIN VENUE: Superblue Miami, USA SATELLITE #1: Artscience Museum, Singapore SATELLITE #2: Silverstone Interactive Museum, UK SATELLITE #3: Yas Marina Circuit Racing School, UAE

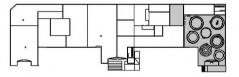
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KEY PLAN



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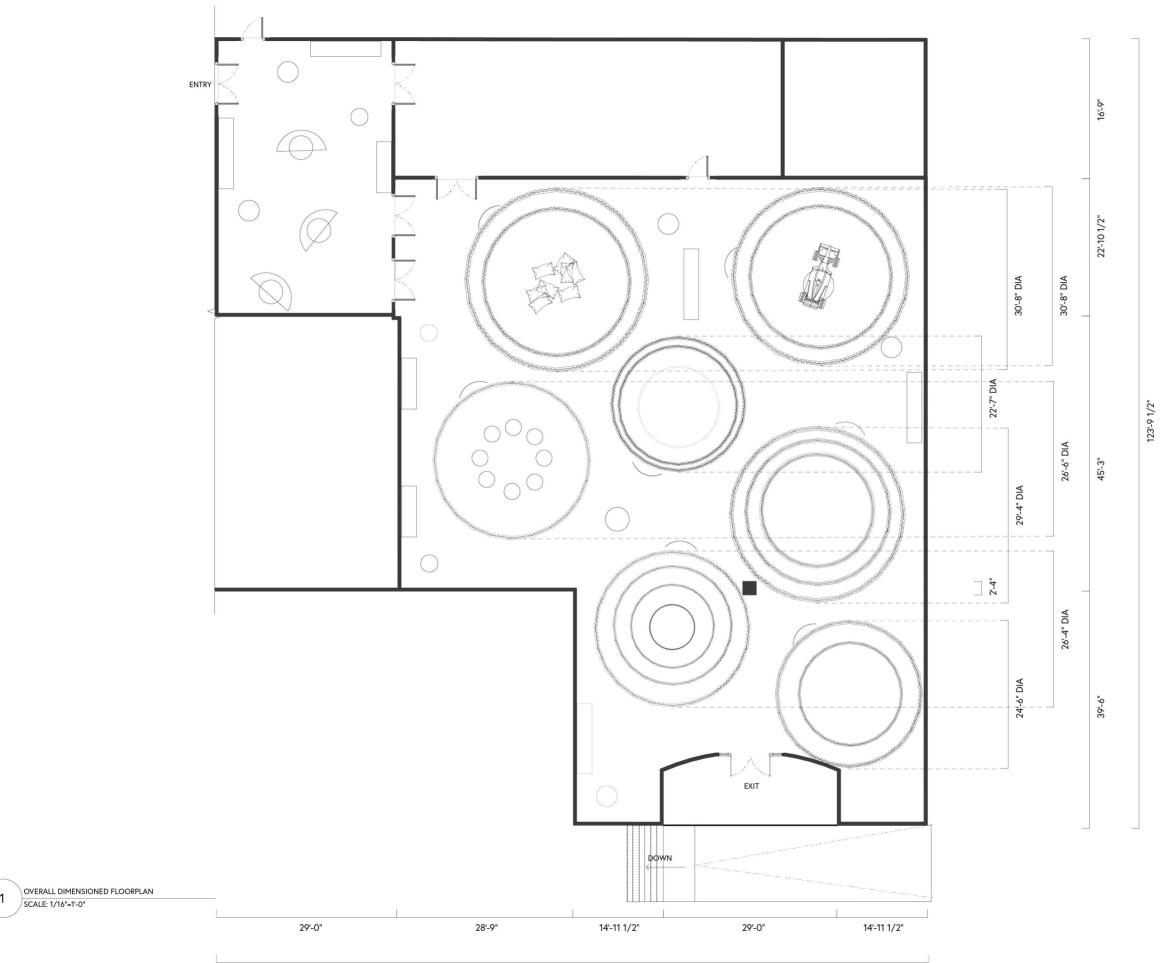
CODED AREA FLOORPLAN

DRAWN BY NAZ ERTUGRUL

EX403

1/16"=1'-0" SCALE







CLIE







VENU

MAIN VENUE: Superblue Miami, USA SATELLITE #1: Artscience Museum, Singapore SATELLITE #2: Silverstone Interactive Museum, UK SATELLITE #3: Yas Marina Circuit Racing School, UAE

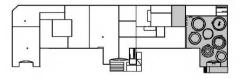
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KEY PLAN



NOTES

OVERALL DIMENSIONED FLOORPLAN

DRAWN BY NAZ ERTUGRUL

EX404

1/16"=1'-0"













MAIN VENUE: Superblue Miami, USA SATELLITE #1: Artscience Museum, Singapore SATELLITE #2: Silverstone Interactive Museum, UK SATELLITE #3: Yas Marina Circuit Racing School, UAE

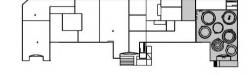
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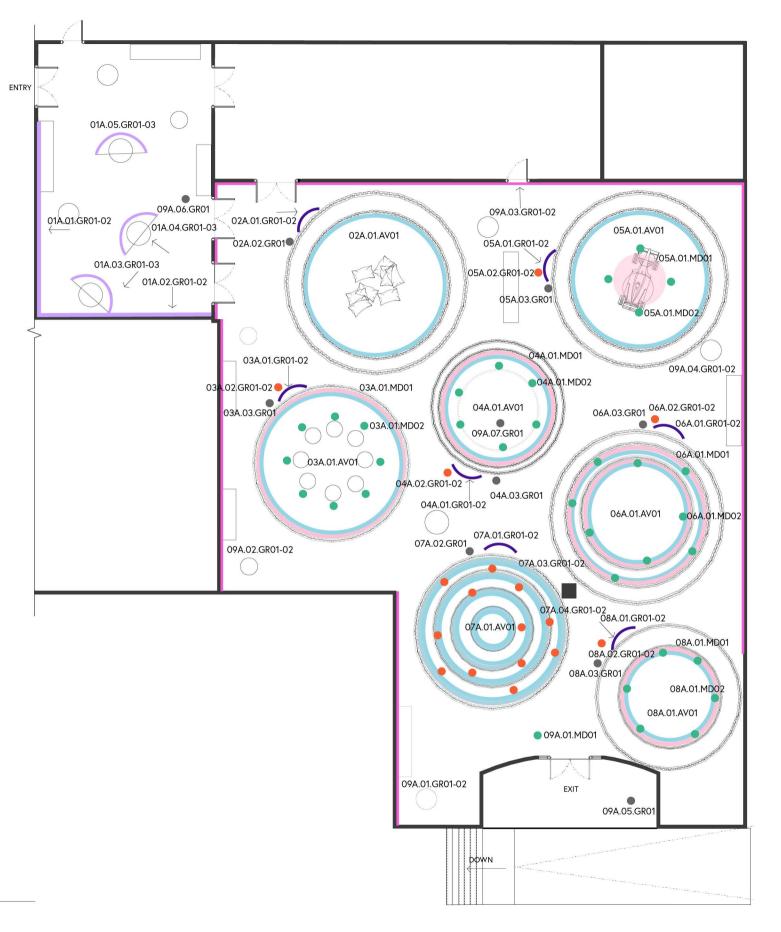
GRAPHIC LOCATION PLAN

DRAWN BY NAZ ERTUGRUL

EX405

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1/16"=1'-0" SCALE



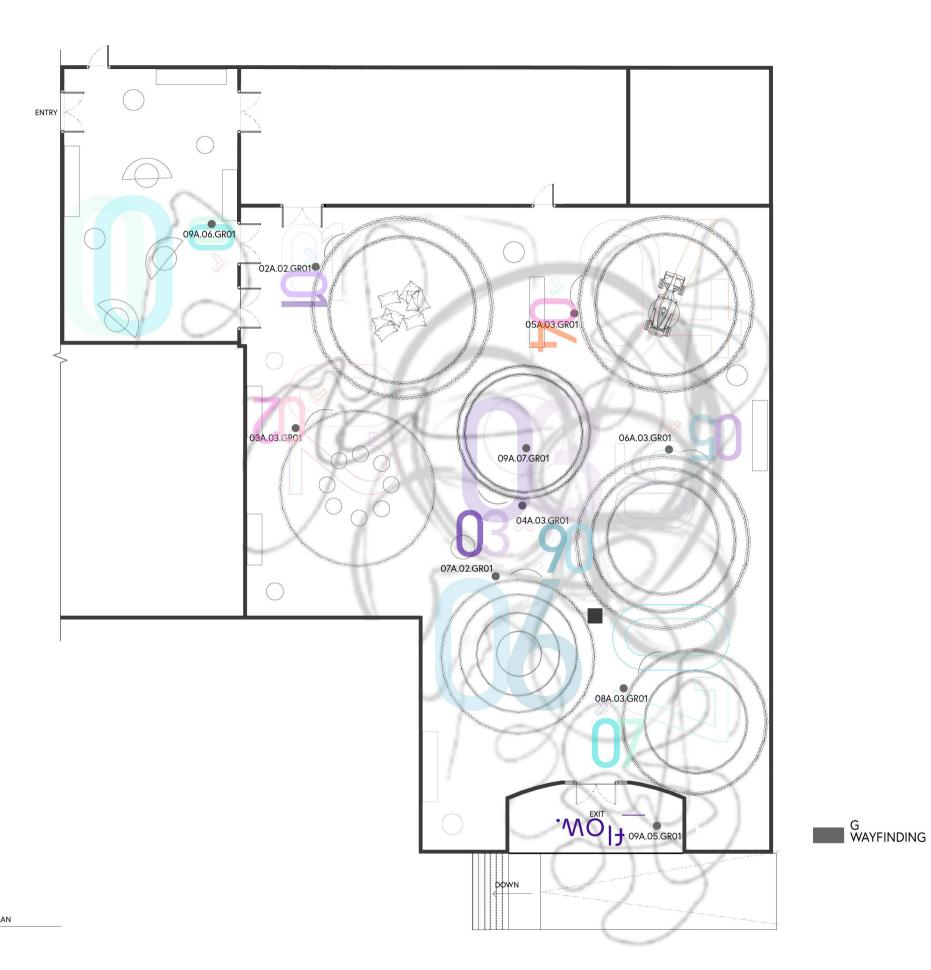
AREA INTRODUCTION C PROJECTION GRAPHICS LABELS INTERACTIVE MEDIA APP MURAL

A ENTRY GRAPHICS

G WAYFINDING

INTERACTIVE MEDIA **DIRECTIVES**

EXPERIENTIAL INFOGRAPHICS











VENUE

MAIN VENUE: Superblue Miami, USA SATELLITE #1: Artscience Museum, Singapore SATELLITE #2: Silverstone Interactive Museum, UK SATELLITE #3: Yas Marina Circuit Racing School, UAE

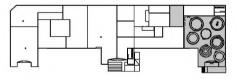
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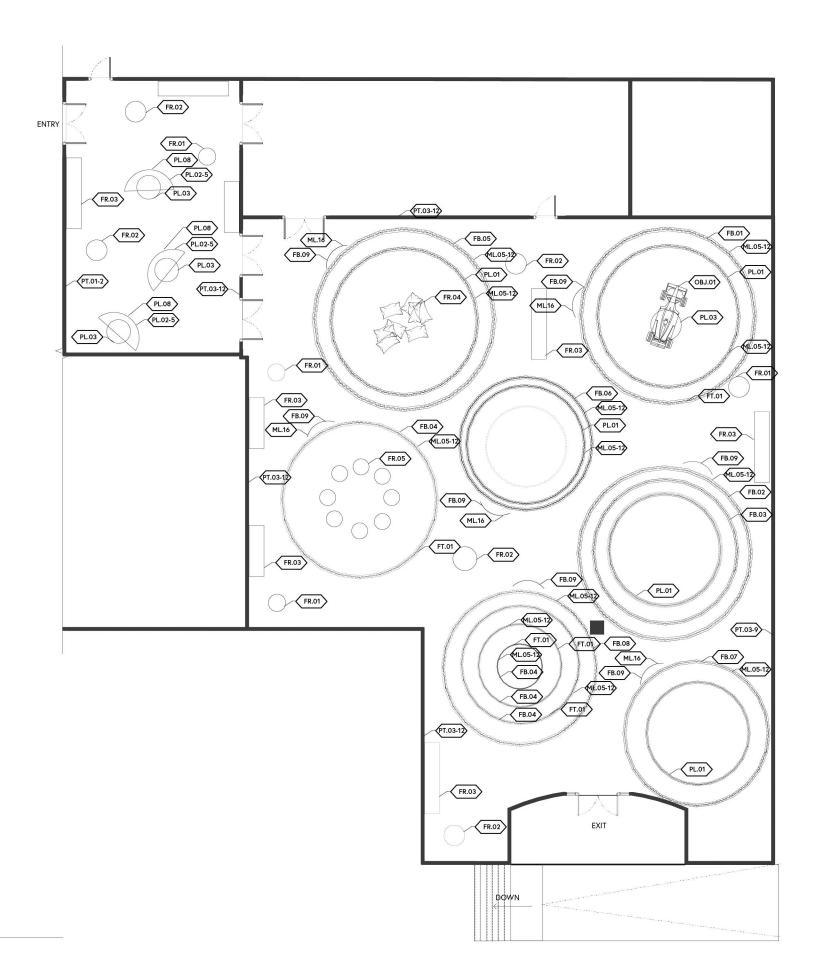
WAYFINDING GRAPHIC LOCATION PLAN

DRAWN BY NAZ ERTUGRUL

EX406

SCALE 1/16"=1'-0"





MATERIAL FLOORPLAN SCALE: 1/16"=1'-0"



CLIENT







VENU

MAIN VENUE: Superblue Miami, USA SATELLITE #1: Artscience Museum, Singapore SATELLITE #2: Silverstone Interactive Museum, UK SATELLITE #3: Yas Marina Circuit Racing School, UAE

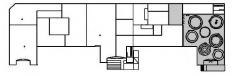
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KEY PLAN



NOTE

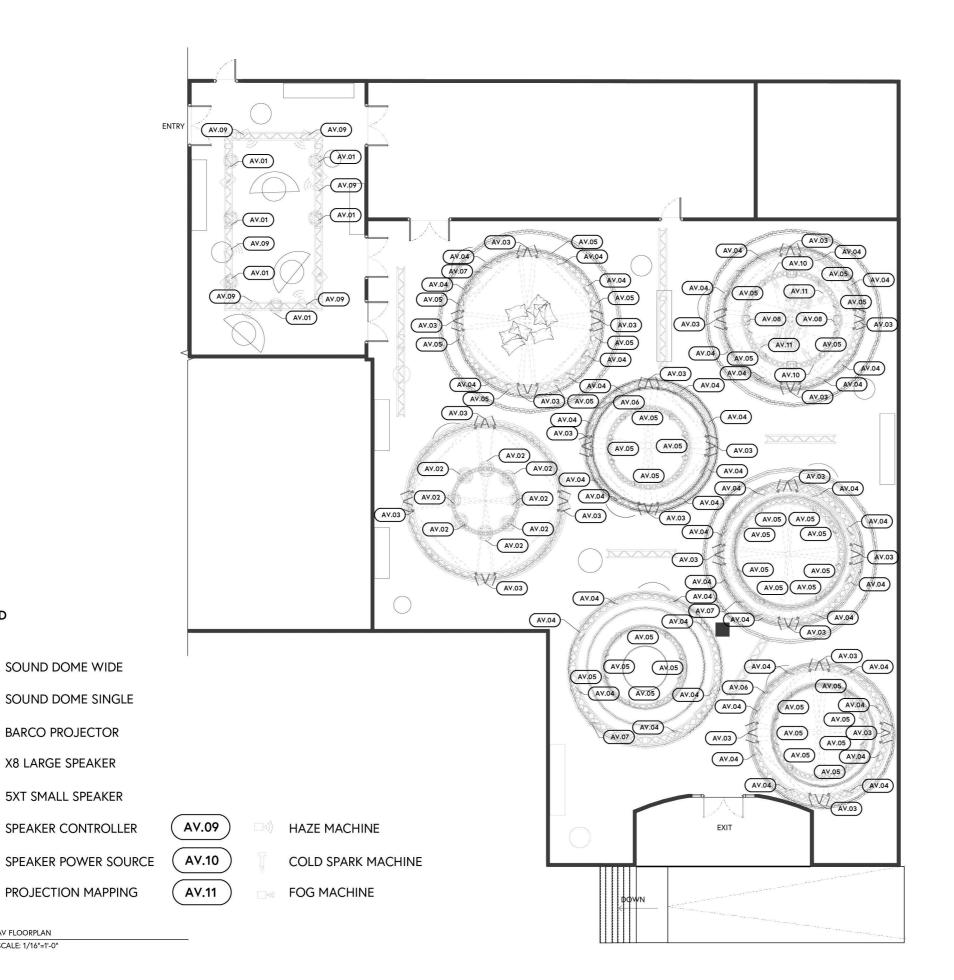
MATERIAL FLOORPLAN

DRAWN BY NAZ ERTUGRUL

EX407

SCALE 1/16"=1'-0"





AV LEGEND

AV.01

AV.02

AV.03

AV.04

AV.05

AV.06

AV.07

80.VA

AV FLOORPLAN SCALE: 1/16"=1'-0"









MAIN VENUE: Superblue Miami, USA SATELLITE #1: Artscience Museum, Singapore SATELLITE #2: Silverstone Interactive Museum, UK SATELLITE #3: Yas Marina Circuit Racing School, UAE

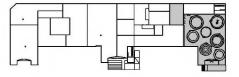
DESIGNER

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NOTES

AV PLAN

DRAWN BY NAZ ERTUGRUL

EX408.01

1/16"=1'-0" SCALE











MAIN VENUE: Superblue Miami, USA SATELLITE #1: Artscience Museum, Singapore SATELLITE #2: Silverstone Interactive Museum, UK SATELLITE #3: Yas Marina Circuit Racing School, UAE

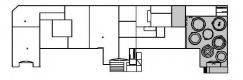
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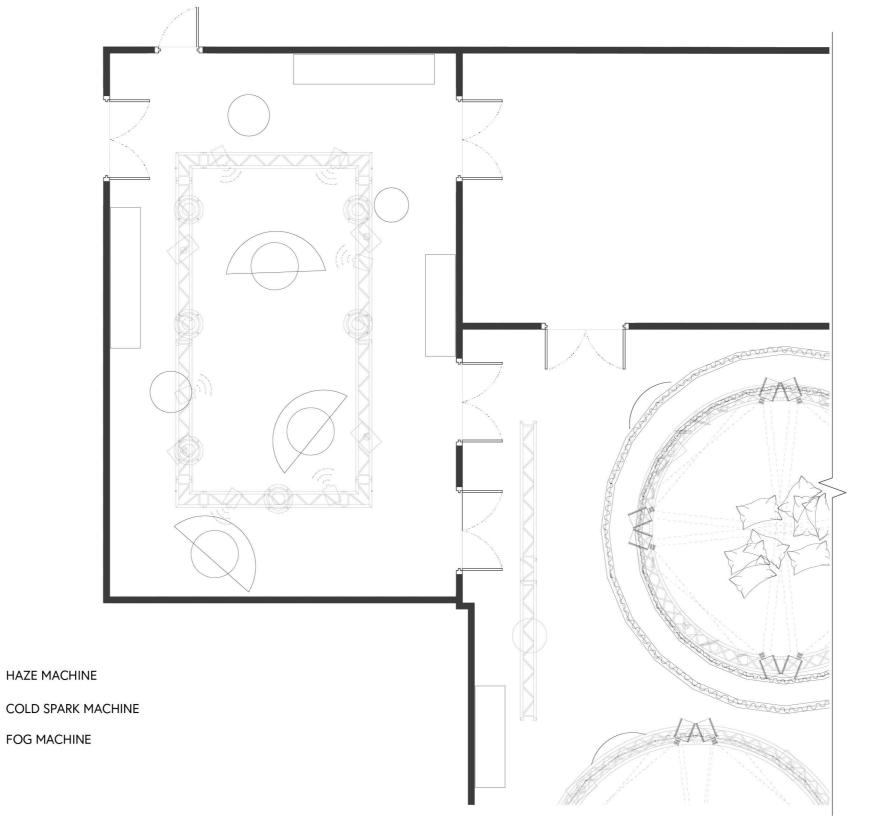
AV PLAN

DRAWN BY NAZ ERTUGRUL

EX408.02

1/8"=1'-0"





AV LEGEND

AV.01 SOUND DOME WIDE

AV.02 SOUND DOME SINGLE

AV.03 BARCO PROJECTOR

AV.04 X8 LARGE SPEAKER

AV.08

AV.05 **5XT SMALL SPEAKER**

AV.06 AV.09 SPEAKER CONTROLLER

PROJECTION MAPPING

AV.07 SPEAKER POWER SOURCE

AV.11

AV.10

FOG MACHINE

AV FLOORPLAN SCALE: 1/8"=1'-0"

CLIEN.







VENUE

MAIN VENUE: Superblue Miami, USA
SATELLITE #1: Artscience Museum, Singapore
SATELLITE #2: Silverstone Interactive
Museum, UK
SATELLITE #3: Yas Marina Circuit Racing
School, UAE

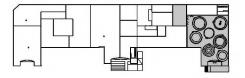
DESIGNER

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NOTES

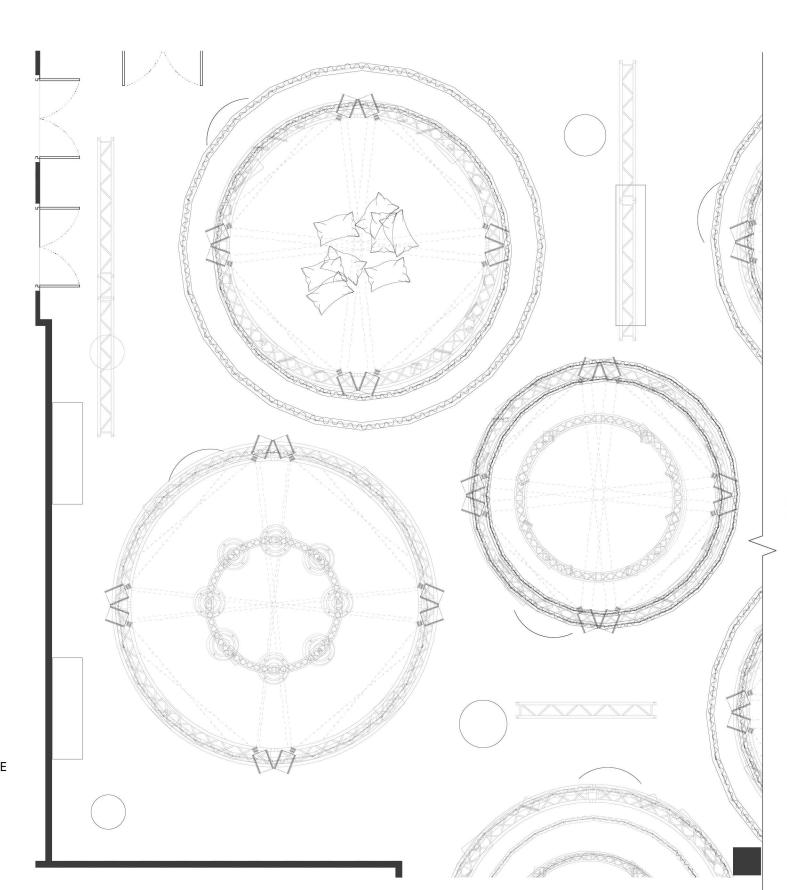
AV PLAN

DRAWN BY NAZ ERTUGRUL

EX408.03

1/9"_1' 0"





AV LEGEND

AV.01 SOUND DOME WIDE

AV.02 SOUND DOME SINGLE

AV.03 BARCO PROJECTOR

(AV.04) = X8 LARGE SPEAKER

AV.05 5XT SMALL SPEAKER

AV.06 SPEAKER CONTROLLER (AV.09) (AV.09) HAZE MACHINE

AV.07 — SPEAKER POWER SOURCE (AV.10) COLD SPARK MACHINE

AV.08 PROJECTION MAPPING AV.11 FOG MACHINE

3 AV FLOORPLAN SCALE: 1/8"=1'-0"

CLIENT







.....

MAIN VENUE: Superblue Miami, USA SATELLITE #1: Artscience Museum, Singapore SATELLITE #2: Silverstone Interactive Museum, UK SATELLITE #3: Yas Marina Circuit Racing School, UAE

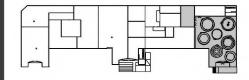
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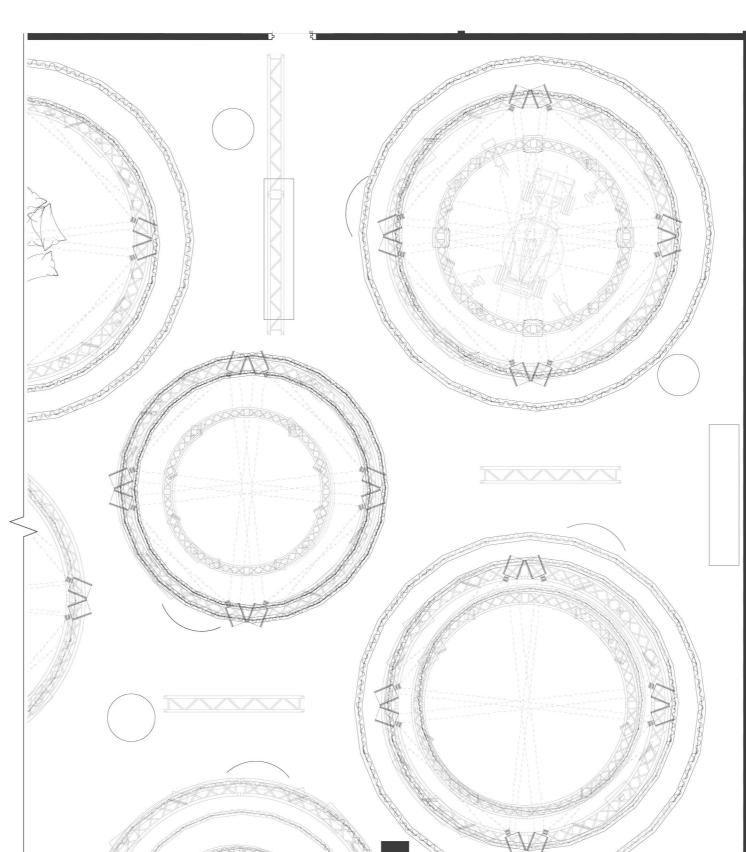
AV PLAN

DRAWN BY NAZ ERTUGRUL

EX408.04

E 1/8"=1'-0"





AV LEGEND

AV.01 SOUND DOME WIDE

AV.02 SOUND DOME SINGLE

AV.03 BARCO PROJECTOR

(AV.04) = X8 LARGE SPEAKER

AV.05 DEST SMALL SPEAKER

AV.06 SPEAKER CONTROLLER (AV.09) (AV.09) HAZE MACHINE

AV.07 SPEAKER POWER SOURCE (AV.10) COLD SPARK MACHINE

AV.08 PROJECTION MAPPING (AV.11) FOG MACHINE

4 AV FLOORPLAN
SCALE: 1/8"=1'-0"

CLIENT







MAIN VENUE: Superblue Miami, USA SATELLITE #1: Artscience Museum, Singapore SATELLITE #2: Silverstone Interactive Museum, UK SATELLITE #3: Yas Marina Circuit Racing School, UAE

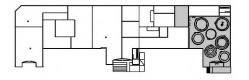
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NOTES

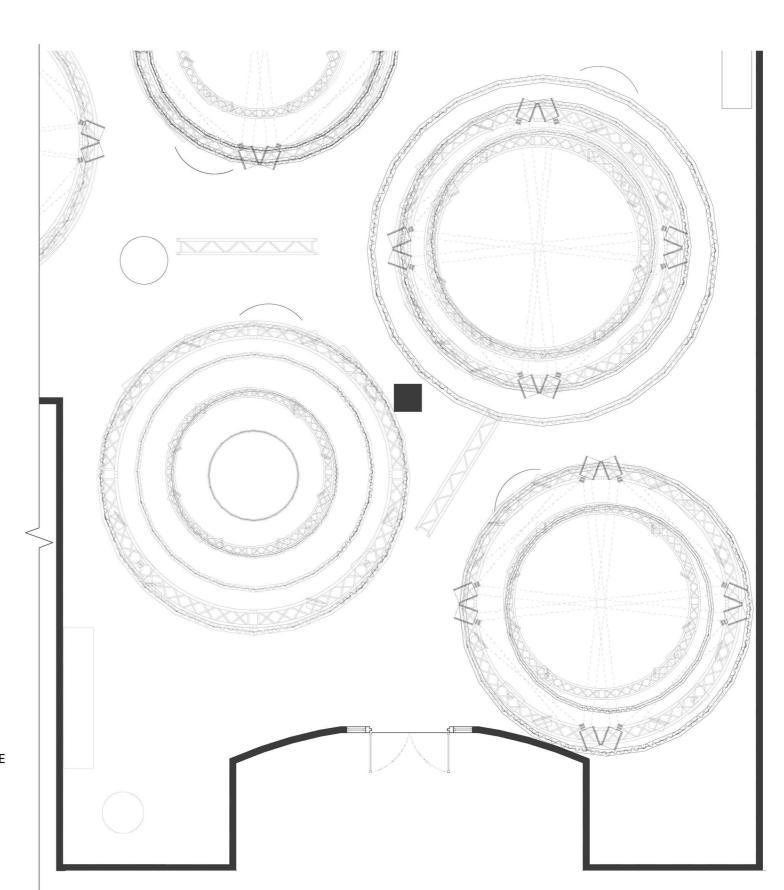
AV PLAN

DRAWN BY NAZ ERTUGRUL

EX408.05

1/8"=1'-0"





AV LEGEND

AV.01 SOUND DOME WIDE

AV.02 SOUND DOME SINGLE

AV.03 BARCO PROJECTOR

AV.04 \ \ \ \ X8 LARGE SPEAKER

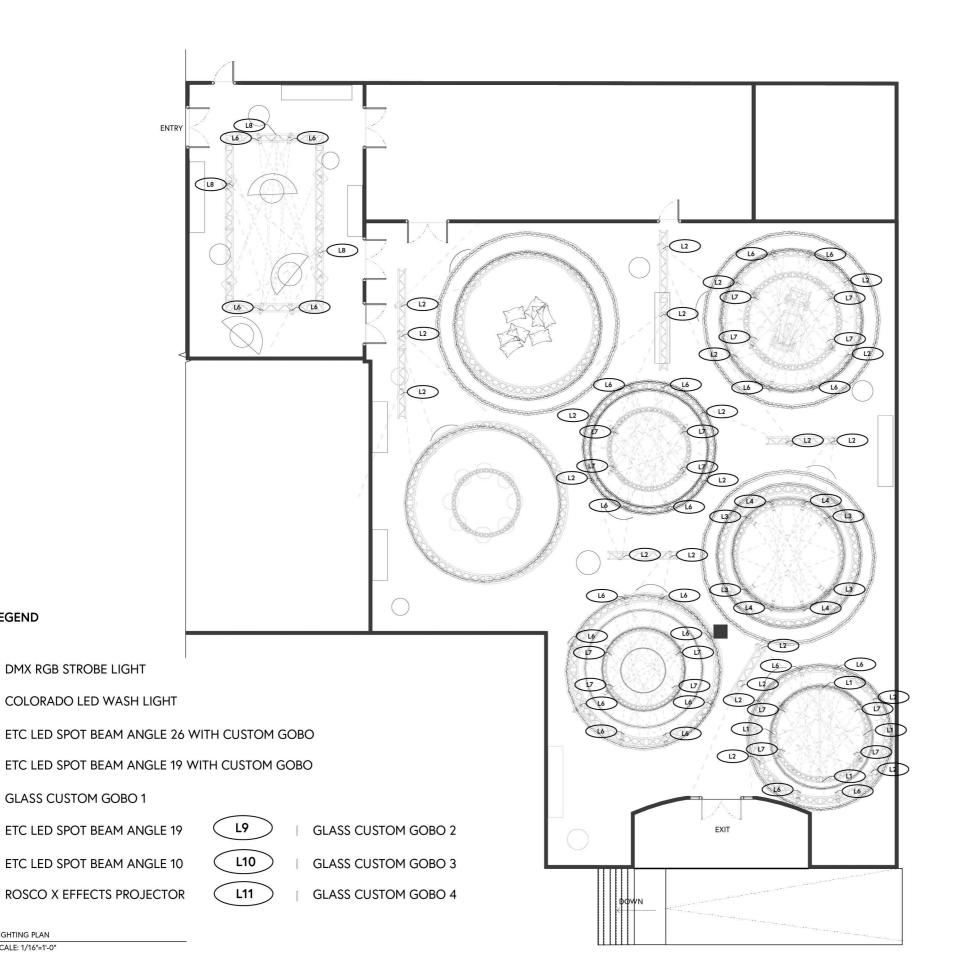
AV.05 5XT SMALL SPEAKER

AV.06 SPEAKER CONTROLLER (AV.09) (AV.09) HAZE MACHINE

AV.07 - SPEAKER POWER SOURCE (AV.10) COLD SPARK MACHINE

AV.08 PROJECTION MAPPING AV.11 FOG MACHINE

5 AV FLOORPLAN
SCALE: 1/8"=1'-0"



FIXTURE LEGEND

LIGHTING PLAN SCALE: 1/16"=1'-0"

L5

L7

L8









MAIN VENUE: Superblue Miami, USA SATELLITE #1: Artscience Museum, Singapore SATELLITE #2: Silverstone Interactive Museum, UK SATELLITE #3: Yas Marina Circuit Racing School, UAE

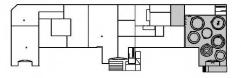
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KEY PLAN



LIGHTING PLAN

DRAWN BY NAZ ERTUGRUL

EX409.01

1/16"=1'-0" SCALE



GLASS CUSTOM GOBO 2

FIXTURE LEGEND

DMX RGB STROBE LIGHT

COLORADO LED WASH LIGHT

ETC LED SPOT BEAM ANGLE 26 WITH CUSTOM GOBO

ETC LED SPOT BEAM ANGLE 19 WITH CUSTOM GOBO

GLASS CUSTOM GOBO 1

L7

ETC LED SPOT BEAM ANGLE 19

L10 ETC LED SPOT BEAM ANGLE 10

GLASS CUSTOM GOBO 3

L8 ROSCO X EFFECTS PROJECTOR L11

L9

GLASS CUSTOM GOBO 4

LIGHTING PLAN SCALE: 1/8"=1'-0"









MAIN VENUE: Superblue Miami, USA SATELLITE #1: Artscience Museum, Singapore SATELLITE #2: Silverstone Interactive Museum, UK SATELLITE #3: Yas Marina Circuit Racing School, UAE

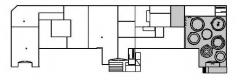
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KEY PLAN



LIGHTING PLAN

DRAWN BY NAZ ERTUGRUL

EX409.02

1/8"=1'-0"



CLIEN.







VENUE

MAIN VENUE: Superblue Miami, USA
SATELLITE #1: Artscience Museum, Singapore
SATELLITE #2: Silverstone Interactive
Museum, UK
SATELLITE #3: Yas Marina Circuit Racing
School, UAE

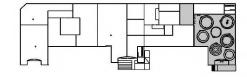
DESIGNER

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KEY PLAN



NOTE

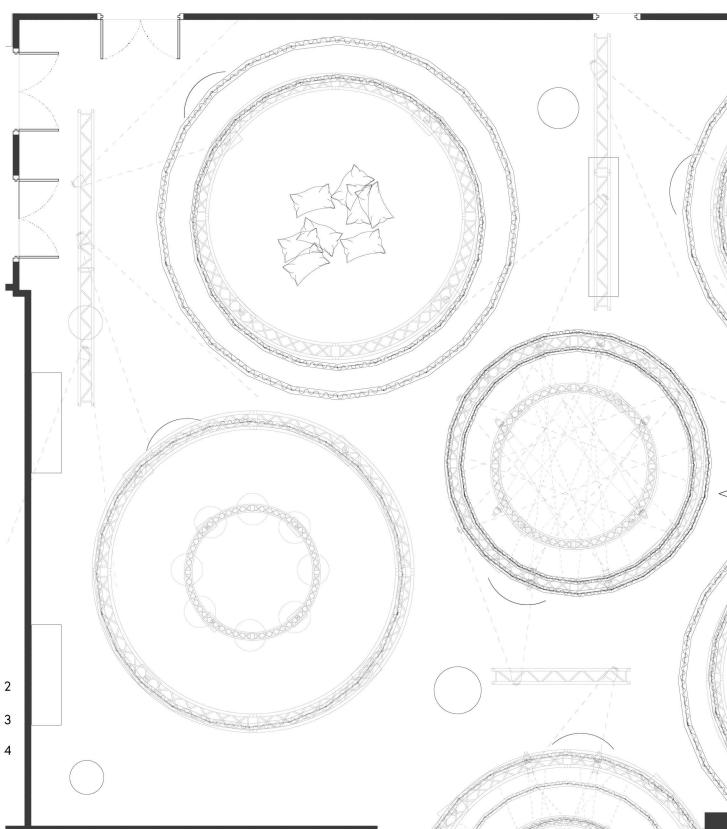
LIGHTING PLAN

DRAWN BY NAZ ERTUGRUL

EX409.03

SCALE 1/9"_1"







L1 DMX RGB STROBE LIGHT

L2 COLORADO LED WASH LIGHT

L3 ETC LED SPOT BEAM ANGLE 26 WITH CUSTOM GOBO

L4 ETC LED SPOT BEAM ANGLE 19 WITH CUSTOM GOBO

L5 GLASS CUSTOM GOBO 1

L6 ETC LED SPOT BEAM ANGLE 19

L9

GLASS CUSTOM GOBO 2

L7 ETC LED SPOT BEAM ANGLE 10



GLASS CUSTOM GOBO 3

L8 ROSCO X EFFECTS PROJECTOR



GLASS CUSTOM GOBO 4

3 SCALE: 1/8"=1'-0"







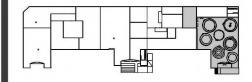


MAIN VENUE: Superblue Miami, USA SATELLITE #1: Artscience Museum, Singapore SATELLITE #2: Silverstone Interactive Museum, UK SATELLITE #3: Yas Marina Circuit Racing School, UAE

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LIGHTING PLAN

DRAWN BY NAZ ERTUGRUL

EX409.04

1/8"=1'-0"







DMX RGB STROBE LIGHT

COLORADO LED WASH LIGHT

ETC LED SPOT BEAM ANGLE 26 WITH CUSTOM GOBO

ETC LED SPOT BEAM ANGLE 19 WITH CUSTOM GOBO

L5 **GLASS CUSTOM GOBO 1**

L9 **ETC LED SPOT BEAM ANGLE 19** GLASS CUSTOM GOBO 2

L7 **ETC LED SPOT BEAM ANGLE 10**

L10 **GLASS CUSTOM GOBO 3**

L8 ROSCO X EFFECTS PROJECTOR L11 **GLASS CUSTOM GOBO 4**

LIGHTING PLAN SCALE: 1/8"=1'-0"









VENII

MAIN VENUE: Superblue Miami, USA SATELLITE #1: Artscience Museum, Singapore SATELLITE #2: Silverstone Interactive Museum, UK SATELLITE #3: Yas Marina Circuit Racing School, UAE

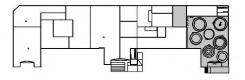
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KEY PLAN



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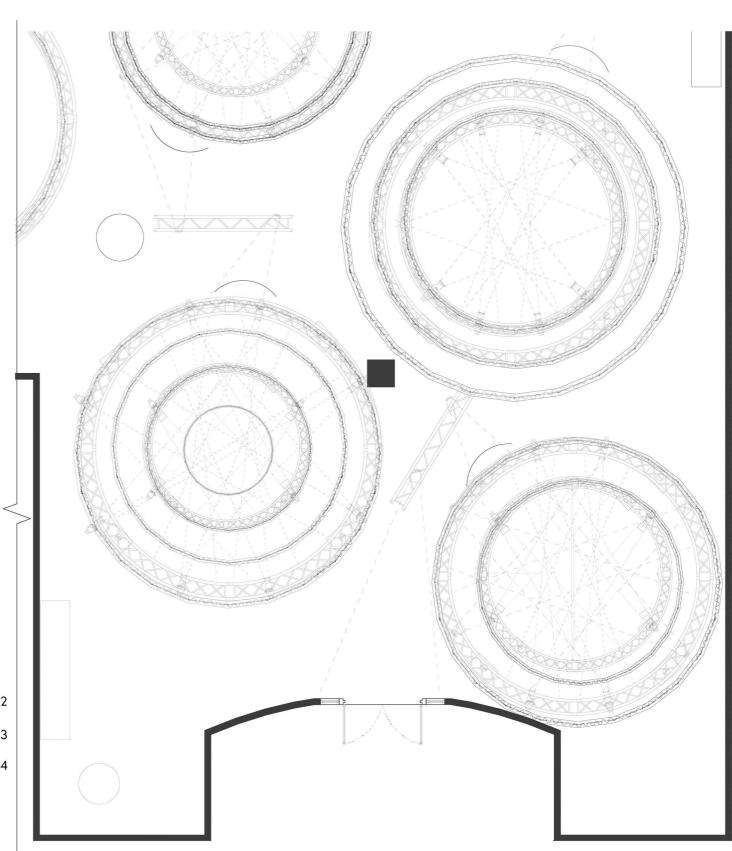
LIGHTING PLAN

DRAWN BY NAZ ERTUGRUL

EX409.05

1/8"=1'-0"





FIXTURE LEGEND

L1 DMX RGB STROBE LIGHT

COLORADO LED WASH LIGHT

ETC LED SPOT BEAM ANGLE 26 WITH CUSTOM GOBO

ETC LED SPOT BEAM ANGLE 19 WITH CUSTOM GOBO

L5 GLASS CUSTOM GOBO 1

L6 SPOT BEAM ANGLE 19 L9 GLAS

10

GLASS CUSTOM GOBO 2

L7 ETC LED SPOT BEAM ANGLE 10

L10

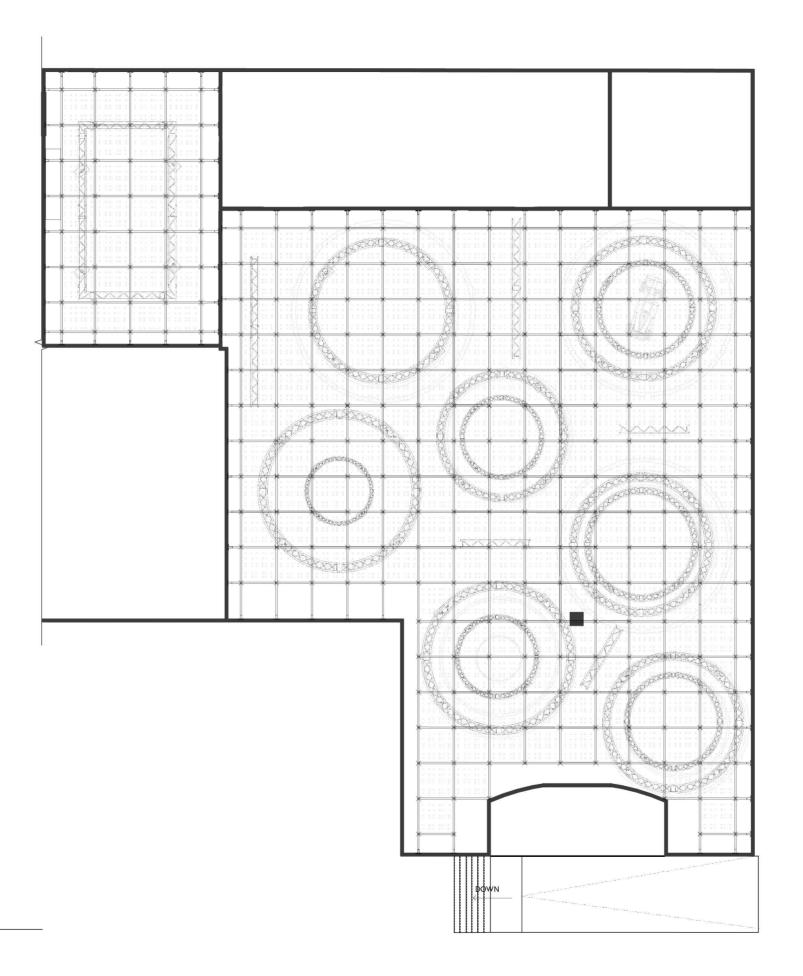
GLASS CUSTOM GOBO 3

L8 ROSCO X EFFECTS PROJECTOR

(L11)

GLASS CUSTOM GOBO 4

5 LIGHTING PLAN
SCALE: 1/8"=1'-0"



1 RCP SCALE: 1/16"=1'-0"



CLIENT







VENU

MAIN VENUE: Superblue Miami, USA SATELLITE #1: Artscience Museum, Singapore SATELLITE #2: Silverstone Interactive Museum, UK SATELLITE #3: Yas Marina Circuit Racing School, UAE

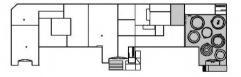
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KEY PLAN



NOTES

RCP

DRAWN BY NAZ ERTUGRUL

EX410

SCALE 1/16"=1'-0"





CHEN







VENUE

MAIN VENUE: Superblue Miami, USA SATELLITE #1: Artscience Museum, Singapore SATELLITE #2: Silverstone Interactive Museum, UK SATELLITE #3: Yas Marina Circuit Racing School, UAE

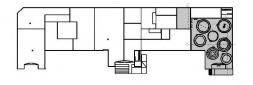
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KEY PLAN



NOTES

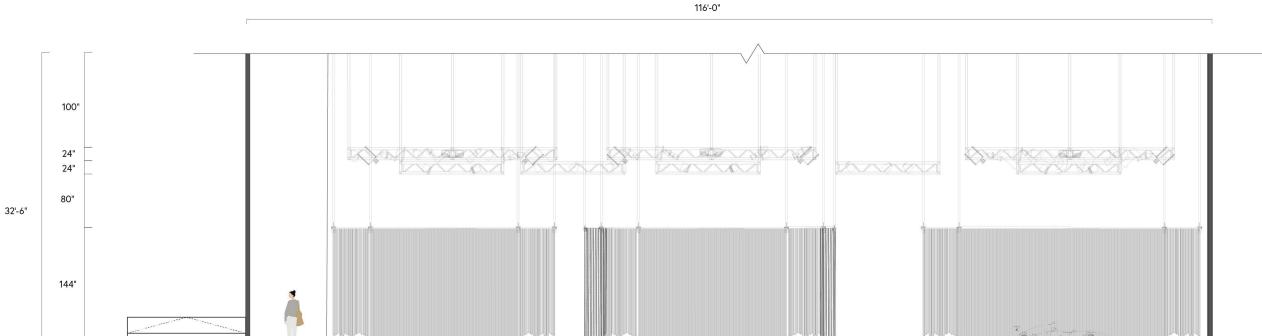
SECTION ELEVATIONS

DRAWN BY NAZ ERTUGRUL

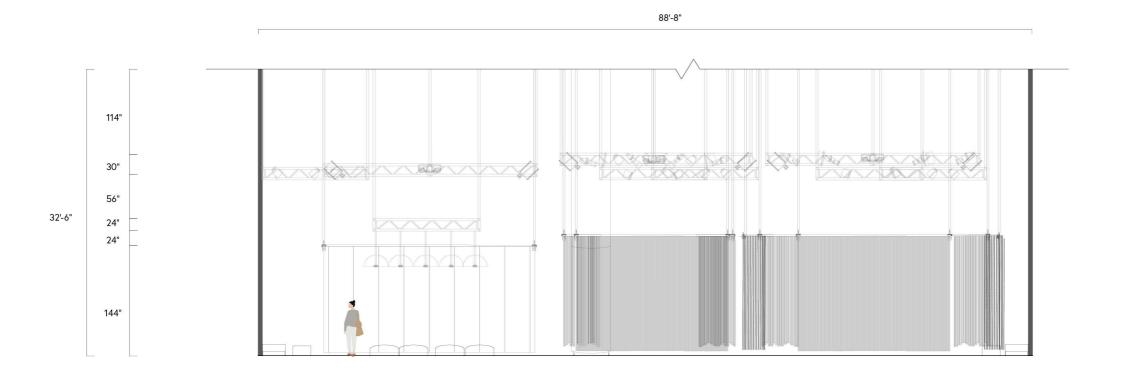
EX411

SCALE 1/8"=1'-0"





SCALE: 1/8"=1'-0"











VENUE

MAIN VENUE: Superblue Miami, USA SATELLITE #1: Artscience Museum, Singapore SATELLITE #2: Silverstone Interactive Museum, UK SATELLITE #3: Yas Marina Circuit Racing School, UAE

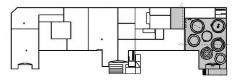
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KEY PLAN



NOTES

SECTION ELEVATIONS

DRAWN BY NAZ ERTUGRUL

EX412

SCALE 1/8"=1'-0"



CLIENT







VENUE

MAIN VENUE: Superblue Miami, USA SATELLITE #1: Artscience Museum, Singapore SATELLITE #2: Silverstone Interactive Museum, UK SATELLITE #3: Yas Marina Circuit Racing School, UAE

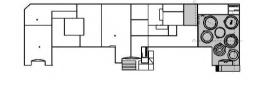
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KEY PLAN



NOTES



ENTRY NORTH WALL SECTION ELEVATION
SCALE: 1/8"=1'-0"

55'-9"

SCALE: 1/8"=1'-0"

THEME AREA 1 SECTION ELEVATION

SECTION ELEVATIONS

DRAWN BY NAZ ERTUGRUL

EX413

SCALE 1/8"=1'-0"



96"

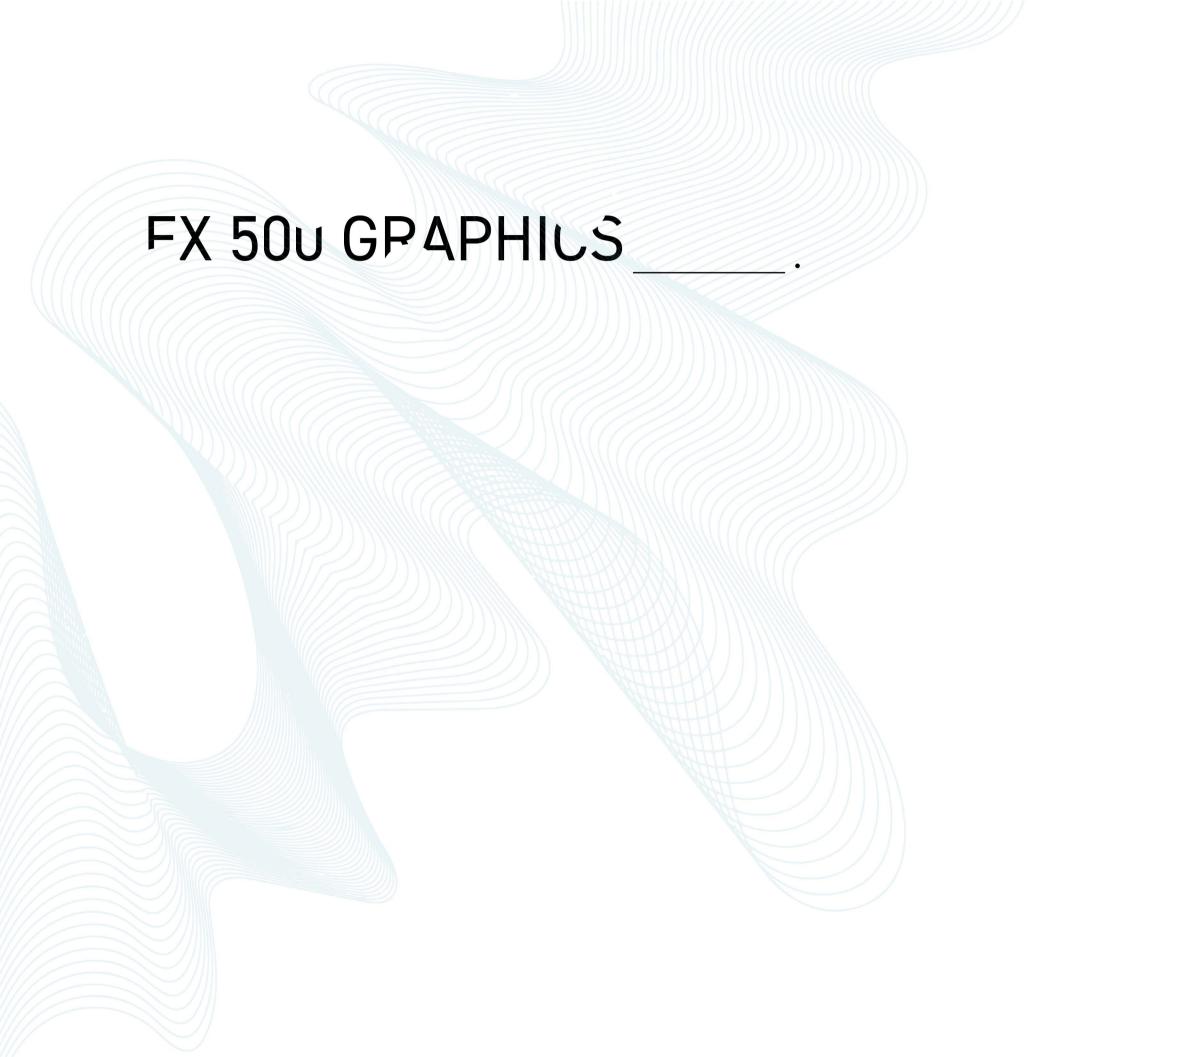
24"

48"

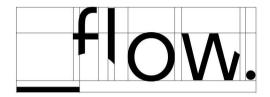
84"

96"

29'-0"



PRIMARY LOGO



1" LOGO



SECONDARY LOGO



1" LOGO



The negative space created with circular knockouts in the graphics becomes the positive space in the physical design which then creates a metaphor for the cycle that shows themetamorphosis of the headspace in time as flow state is present. The different placement of the knockouts references the loose and natural aesthetic that characterizes the richness of the flow experience.









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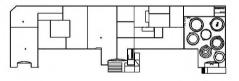
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KEY PLAN



NOTES

VISUAL IDENTITY

DRAWN BY NAZ ERTUGRUL

EX501.01



4



CLIENT







VENUE

MAIN VENUE: Superblue Miami, USA SATELLITE #1: Artscience Museum, Singapore SATELLITE #2: Silverstone Interactive Museum, UK SATELLITE #3: Yas Marina Circuit Racing School, UAE

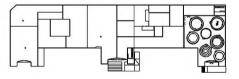
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KEY PLAN



NOTES

VISUAL IDENTITY

DRAWN BY NAZ ERTUGRUL

EX501.02

SCALE NTS













VENUI

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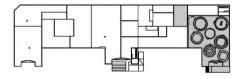
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KEY PLAN



NO

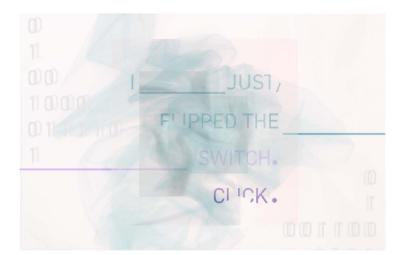
PRIMARY GRAPHIC LOOK & FEEL

DRAWN BY NAZ ERTUGRUL

EX502

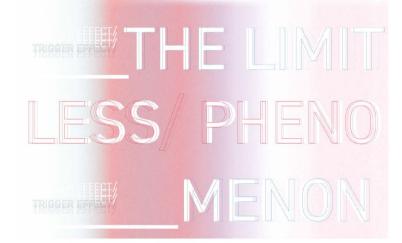
SCAL

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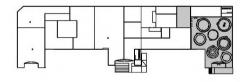
MAIN VENUE: Superblue Miami, USA SATELLITE #1: Artscience Museum, Singapore SATELLITE #2: Silverstone Interactive Museum, UK SATELLITE #3: Yas Marina Circuit Racing School, UAE

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NOTES

SECONDARY GRAPHIC LOOK & FEEL

DRAWN BY NAZ ERTUGRUL

EX503



LOGO TEXT

Soleil, Regular, 14 PT

ABCDEFGHIJKLMNOPQRSTUVWXYZ abcdefghijklmnopqrstuvwxyz 1234567890

HEADLINE TEXT

DIN 2014, Regular, 14 PT

ABCDEFGHIJKLMNOPQRSTUVWXYZ abcdefghijklmnopgrstuvwxyz 1234567890

SUBHEAD & BODY TEXT

Europa, Regular, 14 PT

ABCDEFGHIJKLMNOPQRSTUVWXYZ abcdefghijklmnopgrstuvwxyz 1234567890

A tranquil and fresh geometric sans font family for clear text and headlines. Designed by Wolfgang Homola.

DIN 2014 is a contemporary version of a well-known DIN Typeface. The regular performs well in long text settings. Designed by Vasily Biryukov.

Europa is a modern sans serif combining geometric reduction and humanistic vitality. Its name refersto the inspirational origins, two popular European typefaces: the geometrical Futura and the humanistic Gill Sans. Designed by Fabian Leuenberger.









MAIN VENUE: Superblue Miami, USA SATELLITE #1: Artscience Museum, Singapore SATELLITE #2: Silverstone Interactive Museum, UK SATELLITE #3: Yas Marina Circuit Racing School, UAE

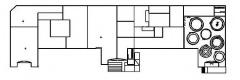
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KEY PLAN



TYPE STUDY

DRAWN BY NAZ ERTUGRUL

EX504.01

IN THE ZONE

shift your gear into motion

The typography and punctuation are used in a manner to support the effect of continuity and movement through symbols and shapes. The intended effect is also present on the page through different approaches, such as the rounded cut-out parts of the lettering, the shadowing effect, as well as the overlay of phrases in the subhead to add dimension and give an active feel.









MAIN VENUE: Superblue Miami, USA SATELLITE #1: Artscience Museum, Singapore SATELLITE #2: Silverstone Interactive Museum, UK SATELLITE #3: Yas Marina Circuit Racing School, UAE

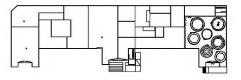
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KEY PLAN



NOTES

TYPE STUDY

DRAWN BY NAZ ERTUGRUL

EX504.02













MAIN VENUE: Superblue Miami, USA SATELLITE #1: Artscience Museum, Singapore SATELLITE #2: Silverstone Interactive Museum, UK SATELLITE #3: Yas Marina Circuit Racing School, UAE

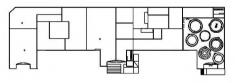
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KEY PLAN



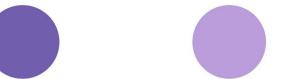
NOTES



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EX505

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The colors forming the color palette represent the nine

thorough flow experience. Therefore, the variety in the

single reality and completing the full cycle of flow as a

dimensions of Czikszentmihalyi's explanation for the

color scheme that eventually evolve into a gradient

scale it displays the nine dimensions merging into a

person is performing a task by being in the zone.



PANTONE VIOLET C

PANTONE VIOLET U





PANTONE ORANGE 021 C



PANTONE GREEN 0921 C



PANTONE 319 C



PANTONE BRIGHT GREEN C



PANTONE COOL GREY 10C

PANTONE COOL GREY 1C





PANTONE 304 C

PANTONE 263 C

PANTONE 7458 C

PANTONE 182C











VENU

MAIN VENUE: Superblue Miami, USA SATELLITE #1: Artscience Museum, Singapore SATELLITE #2: Silverstone Interactive Museum, UK SATELLITE #3: Yas Marina Circuit Racing School, UAE

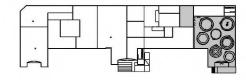
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NOTES

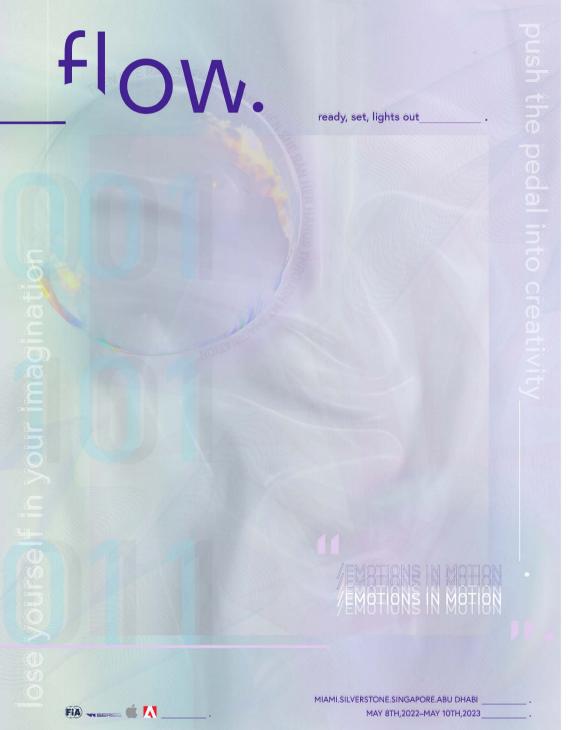
COLLATERAL

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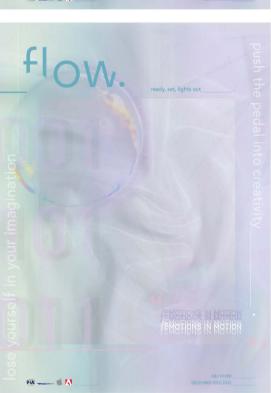
EX506

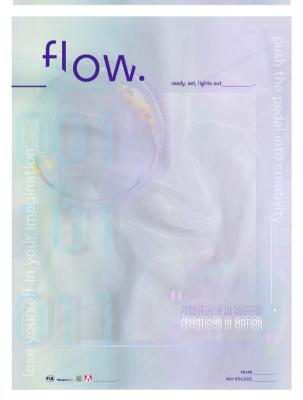
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VENII

MAIN VENUE: Superblue Miami, USA SATELLITE #1: Artscience Museum, Singapore SATELLITE #2: Silverstone Interactive Museum, UK SATELLITE #3: Yas Marina Circuit Racing School, UAE

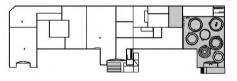
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POSTER

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EX507.01

NTS













VENU

MAIN VENUE: Superblue Miami, USA SATELLITE #1: Artscience Museum, Singapore SATELLITE #2: Silverstone Interactive Museum, UK SATELLITE #3: Yas Marina Circuit Racing School, UAE

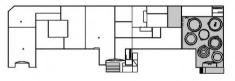
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KEY PLAN



NOTE

POSTER

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EX507.02

NTS

SCALE

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VENU

MAIN VENUE: Superblue Miami, USA SATELLITE #1: Artscience Museum, Singapore SATELLITE #2: Silverstone Interactive Museum, UK SATELLITE #3: Yas Marina Circuit Racing School, UAE

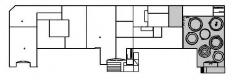
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NOTES

POSTER

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EX507.03

NTS













VENU

MAIN VENUE: Superblue Miami, USA SATELLITE #1: Artscience Museum, Singapore SATELLITE #2: Silverstone Interactive Museum, UK SATELLITE #3: Yas Marina Circuit Racing School, UAE

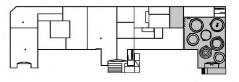
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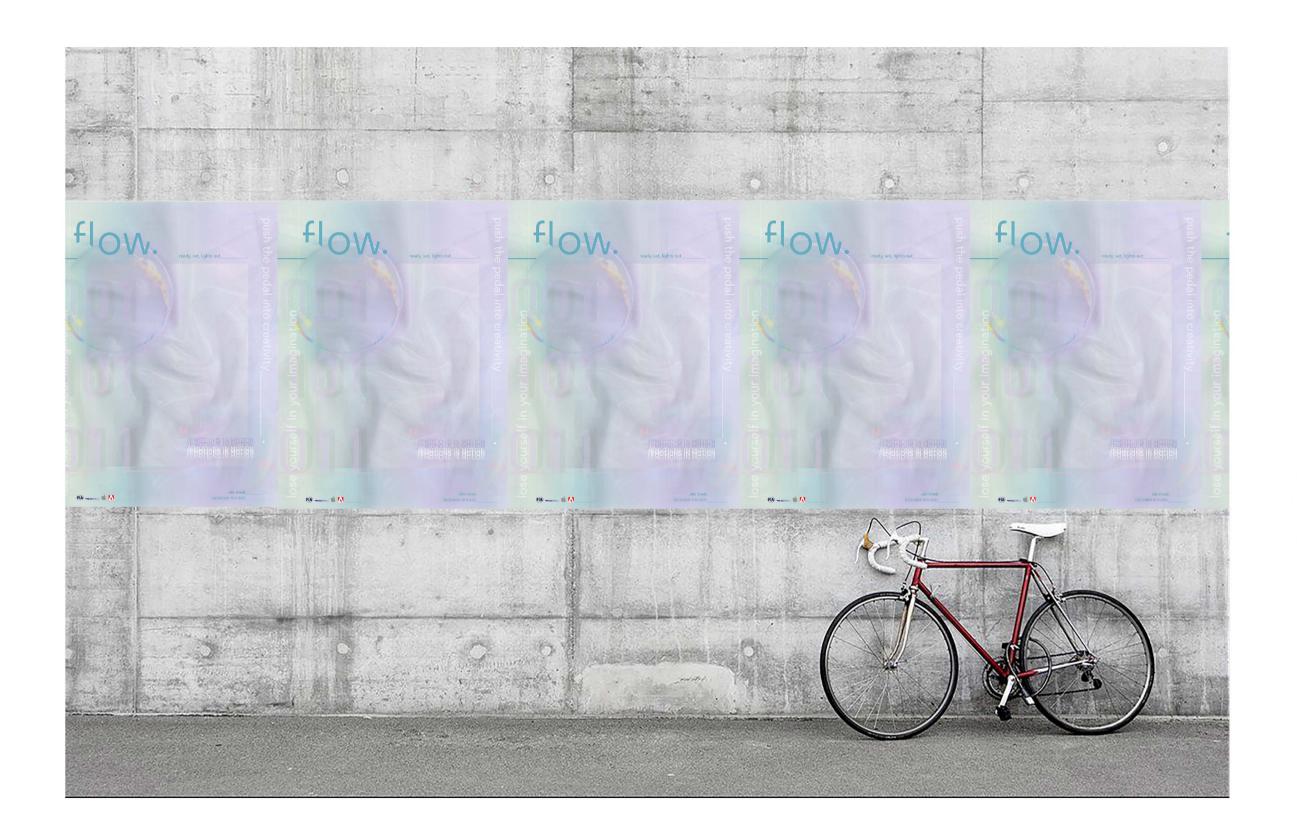
POSTER

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EX507.04

NTS













VENUE

MAIN VENUE: Superblue Miami, USA SATELLITE #1: Artscience Museum, Singapore SATELLITE #2: Silverstone Interactive Museum, UK SATELLITE #3: Yas Marina Circuit Racing School, UAE

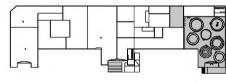
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NOTE

POSTER

NTS

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EX507.05

SCALE

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VENUE

MAIN VENUE: Superblue Miami, USA SATELLITE #1: Artscience Museum, Singapore SATELLITE #2: Silverstone Interactive Museum, UK SATELLITE #3: Yas Marina Circuit Racing School, UAE

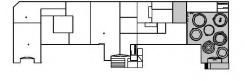
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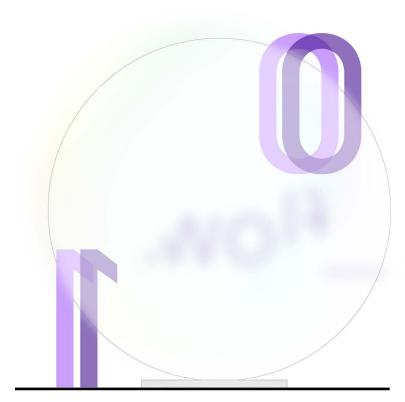
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KEY PLAN



NOTES



01.A.05.GR01-03 FRONT ELEVATION

SCALE: 1/2"=1'-0"

24"

___ 5"

12"

9"

18"

42"

96"

2 01.A.05.GR01-03 SIDE ELEVATION SCALE: 1/2"=1'-0"

01A.05.GR01 GRAPHIC TYPE A

01A.05.GR03 GRAPHIC TYPE A

72"

01A.05.GR02 GRAPHIC TYPE A

> 3 01.A.05.GR01-03 BACK ELEVATION SCALE: 1/2"=1'-0"

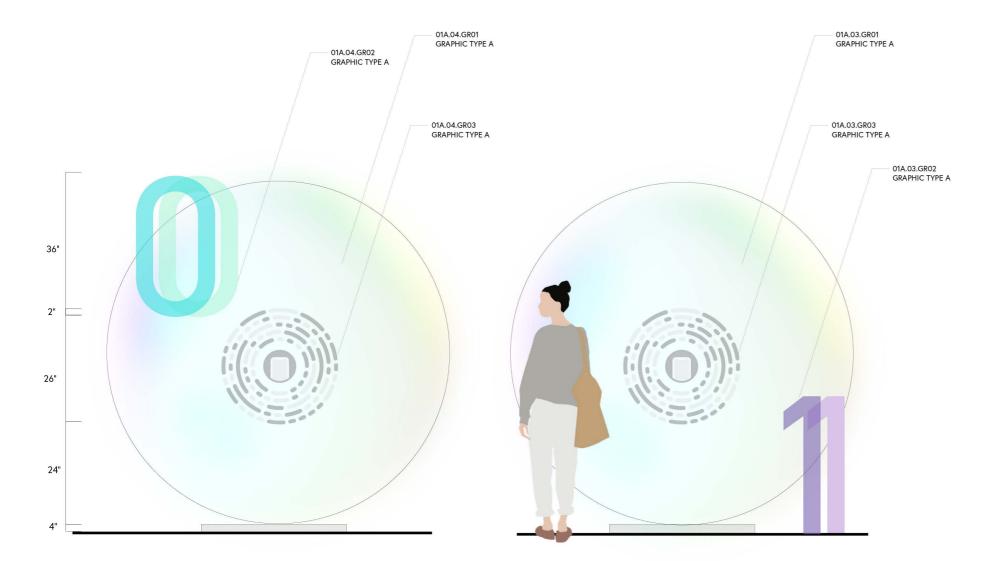
GRAPHIC TYPE A DRAWINGS

DRAWN BY NAZ ERTUGRUL

EX508.01

SCALE 1/2"=1'-0"

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O1A.03.GR01-03 SIDE ELEVATION SCALE: 1/2"=1'-0"



CLIENT







VENUE

MAIN VENUE: Superblue Miami, USA SATELLITE #1: Artscience Museum, Singapore SATELLITE #2: Silverstone Interactive Museum, UK SATELLITE #3: Yas Marina Circuit Racing School, UAE

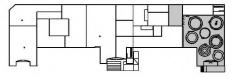
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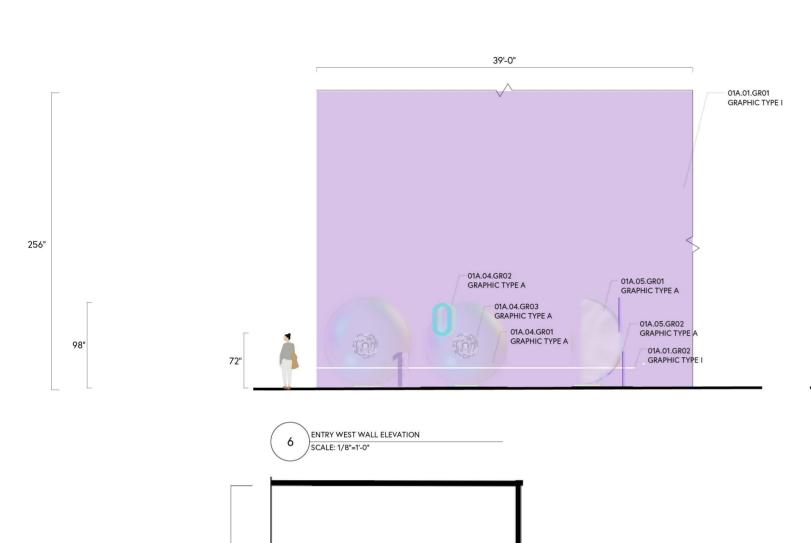
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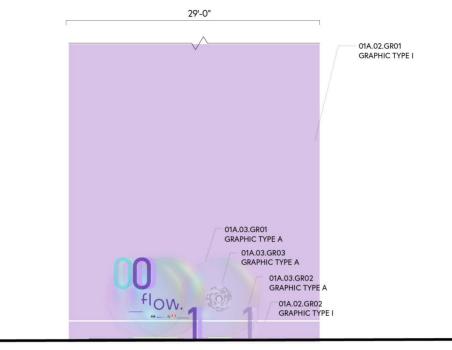
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EX508.02

SCALE 1/2"=1'-0"







7 ENTRY SOUTH WALL ELEVATION
SCALE: 1/8"=1"-0"



CLIENT







VENUE

MAIN VENUE: Superblue Miami, USA SATELLITE #1: Artscience Museum, Singapore SATELLITE #2: Silverstone Interactive Museum, UK SATELLITE #3: Yas Marina Circuit Racing School, UAE

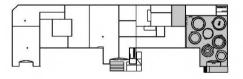
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KEY PLAN



NOTES

GRAPHIC TYPE A DRAWINGS

DRAWN BY NAZ ERTUGRUL

EX508.03

SCALE 1/8"=1'-0"

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16'-9"

39'-0"





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VENUE

MAIN VENUE: Superblue Miami, USA SATELLITE #1: Artscience Museum, Singapore SATELLITE #2: Silverstone Interactive Museum, UK SATELLITE #3: Yas Marina Circuit Racing School, UAE

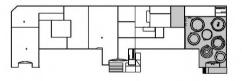
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KEY PLAN



NOTES

02A.01.GR01-02 SIDE ELEVATION

SCALE: 1/2"=1'-0"

GRAPHIC TYPE B DRAWINGS

DRAWN BY NAZ ERTUGRUL

EX509

SCALE 1/2"=1'-0"



flow.







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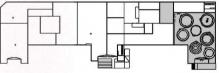
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KEY PLAN



NOTES

THE LIMITLESS PHENOMENON push the pedal into creativity Unambiguous feedback. Direct and immediate feedback is continously present, adjusting our reactions to meet the current demands. When we are in flow, we know how well are doing, all the time.

THE IHIRD EYE RULE

F YOU EVEN HERE?

awaken your deep emotions

Clear goals. In many everyday situations, there are contradictory demands which occupy our attention. In a flow experience, we have a clear purpose and a strong grasp of the next steps.

100

03A.02.GR01 GRAPHIC TYPE D

03A.01.GR01 GRAPHIC TYPE B

03A.01.GR02 GRAPHIC TYPE B

03A.01.GR01-02 & 03A.02.GR01-02 FRONT ELEVATION SCALE: 1/2"=1'-0"

'N THE ZONE

shift your gear into motion

Action-awareness merging. We are often aware of and thinking about the current. But in a flow experience, we are completely absorbed in the task at hand.

60"

84"

04A.01.GR01-02 & 04A.02.GR01-02 FRONT ELEVATION

05A.01.GR01-02 & 05A.02.GR01-02 FRONT ELEVATION SCALE: 1/2"=1'-0"

GRAPHIC TYPE B EXAMPLES

DRAWN BY NAZ ERTUGRUL

EX510.01

1/2"=1'-0" SCALE



ORE VOI UME

Concentration on the task. High levels of focus

narrows our attention and excluding any distractions. In flow state, we are completely absorbed in the

find your inner gravity_

06A.01.GR01 GRAPHIC TYPE B

06A.01.GR02 GRAPHIC TYPE B

06A.02.GR01 GRAPHIC TYPE D









MAIN VENUE: Superblue Miami, USA SATELLITE #1: Artscience Museum, Singapore SATELLITE #2: Silverstone Interactive Museum, UK SATELLITE #3: Yas Marina Circuit Racing School, UAE

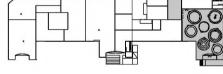
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KEY PLAN



NOTES

FLOW .4ATRIX ready, set, lights out_ A distorted sense of time, either slows down or flies by. Flow is an intrinsic rewarding activity; the activity becomes autotelic, and done for its

FRONT

FINDING NEVERLAND

Sense of control. A lack of awareness of bodily needs

as self-conciousness disappears. In flow state, we are too involved in the activity and are able to do

speed into your dreams

anything freely.

07A.01.GR01-02 FRONT ELEVATION SCALE: 1/2"=1'-0"

\08A.01.GR01-02 & 08A.02.GR01-02 FRONT ELEVATION SCALE: 1/2"=1'-0"

GRAPHIC TYPE B EXAMPLES

DRAWN BY NAZ ERTUGRUL

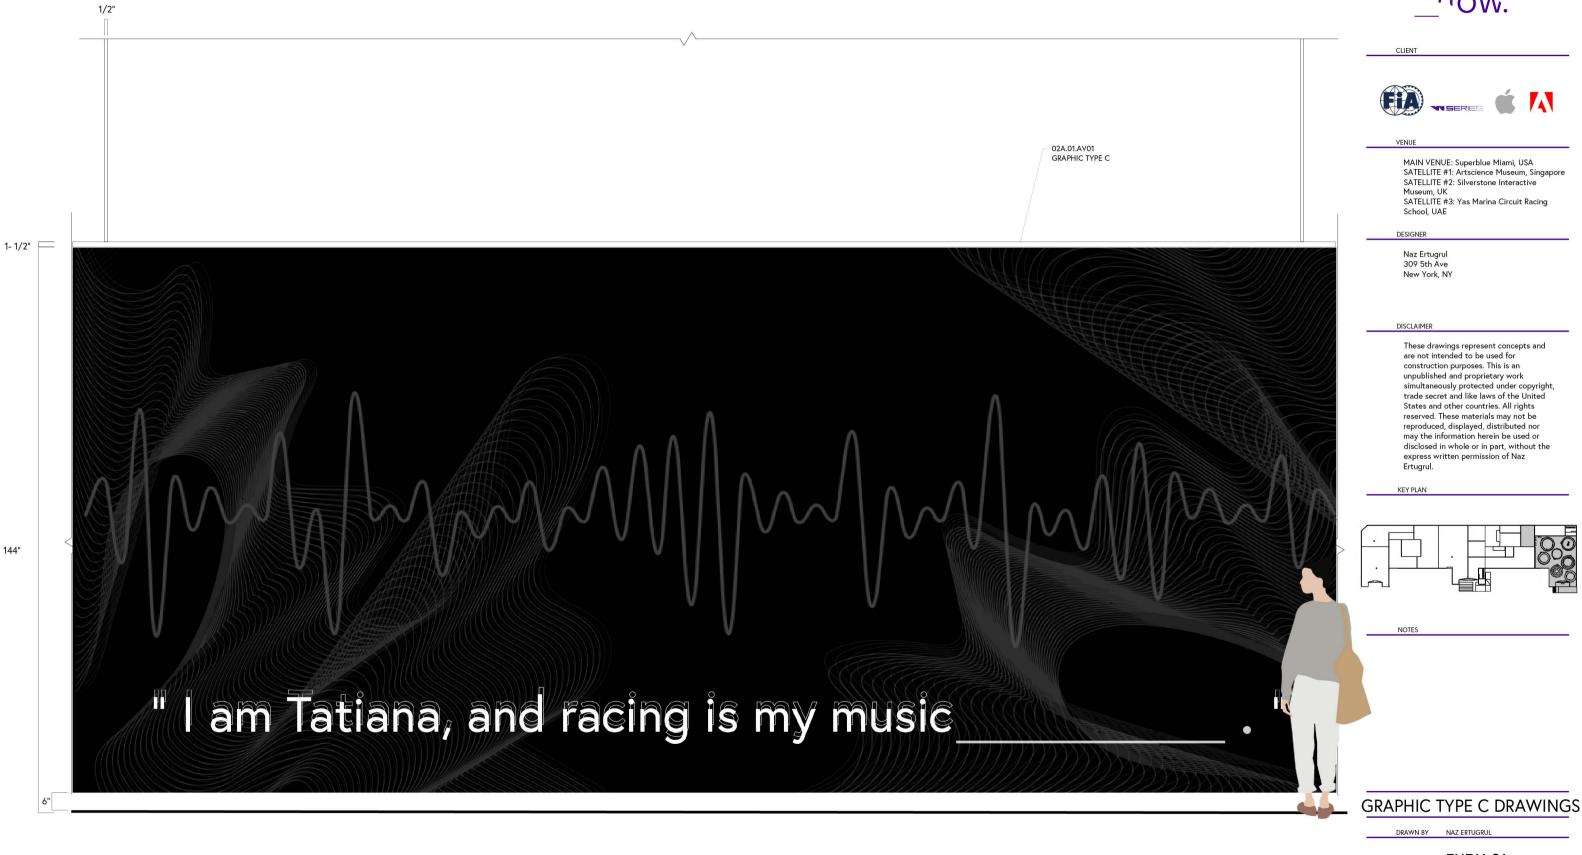
EX510.02

1/2"=1'-0" SCALE

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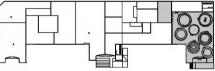


60"



02A.01.AV01 ELEVATION SCALE: 1/2"-1'-0"

flow.



EX511.01

SCALE



1- 1/2" |

144"





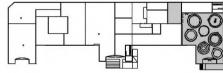


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GRAPHIC TYPE C DRAWINGS

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EX511.02

1/2"=1'=0" SCALE



02A.01.AV01 GRAPHIC TYPE C



02A.01.AV01 ELEVATION SCALE: 1/2"-1'-0"









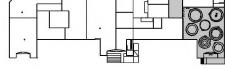
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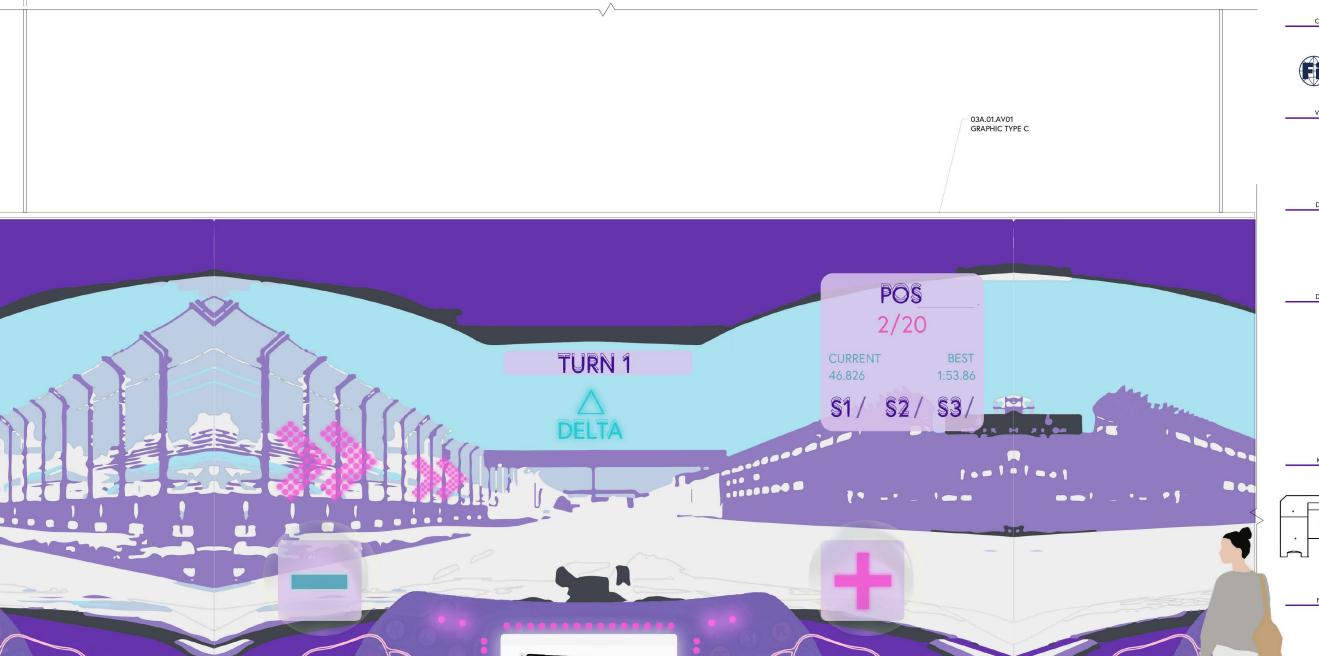


GRAPHIC TYPE C EXAMPLES

DRAWN BY NAZ ERTUGRUL

EX512.01

SCALE 1/2"=1'=0" \bigcirc N



1/2"

1- 1/2" =

144"









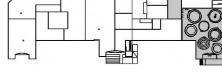
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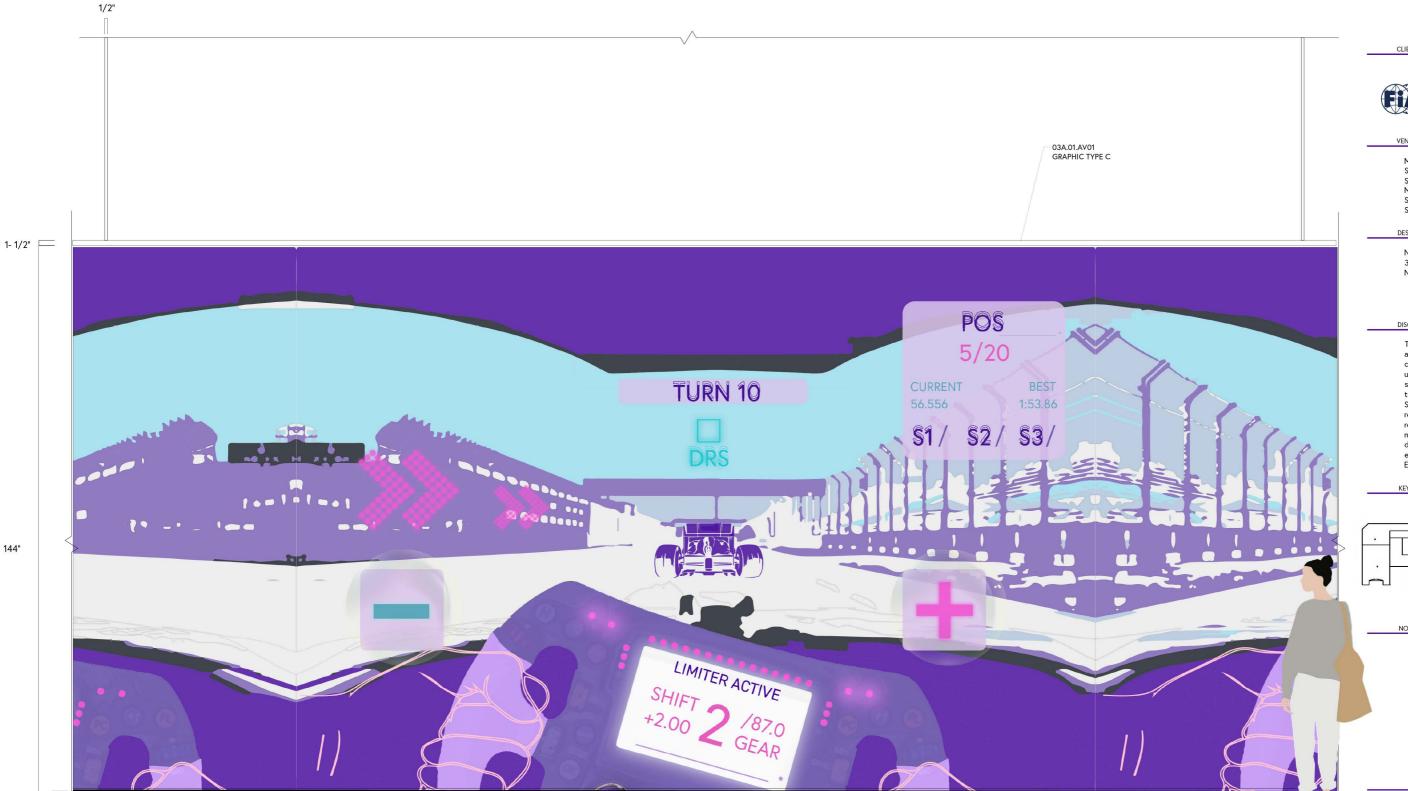
NOTES

GRAPHIC TYPE C EXAMPLES

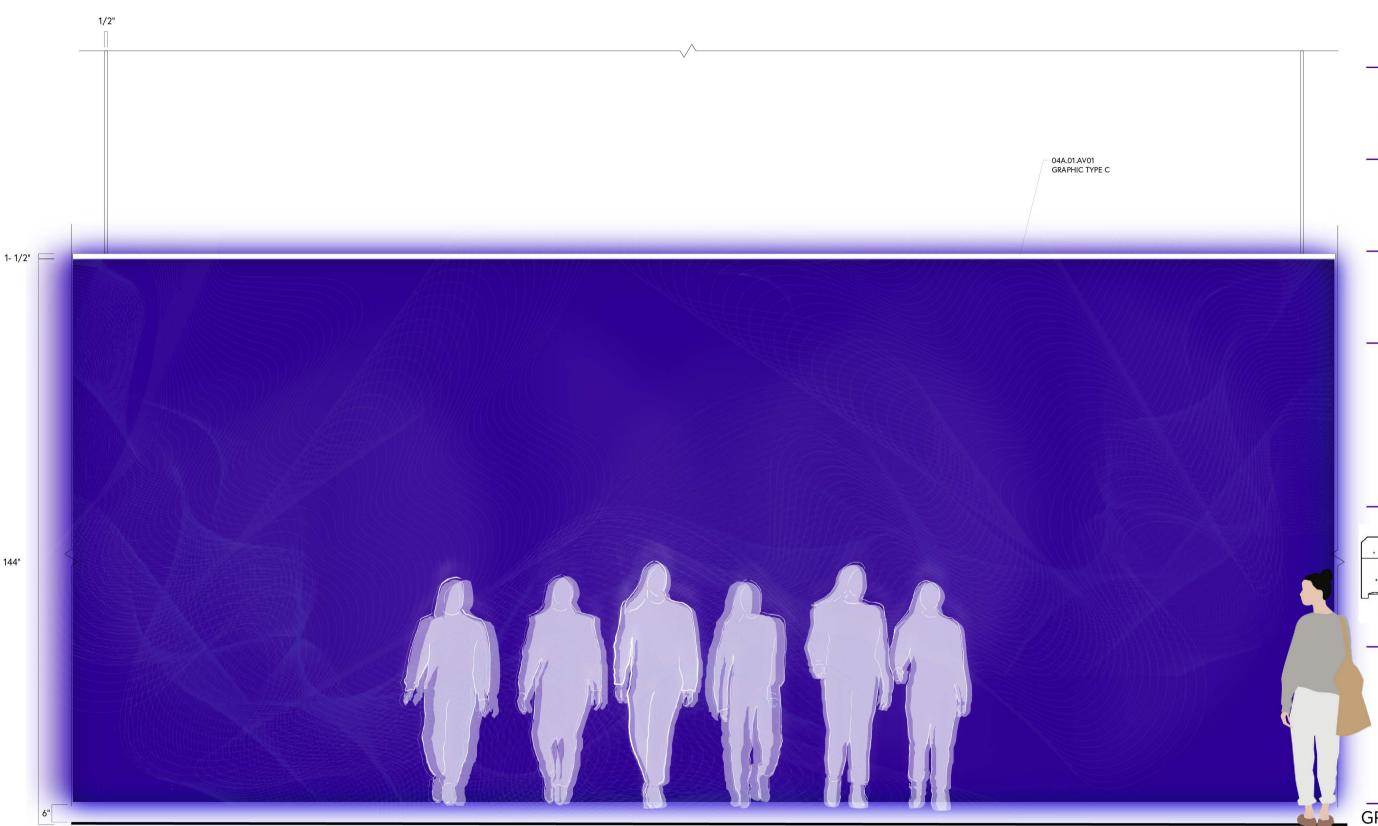
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EX512.02

SCALE 1/2"=1'=0" \bigcirc N



144"





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VENUE

MAIN VENUE: Superblue Miami, USA SATELLITE #1: Artscience Museum, Singapore SATELLITE #2: Silverstone Interactive Museum, UK SATELLITE #3: Yas Marina Circuit Racing School, UAE

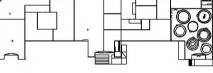
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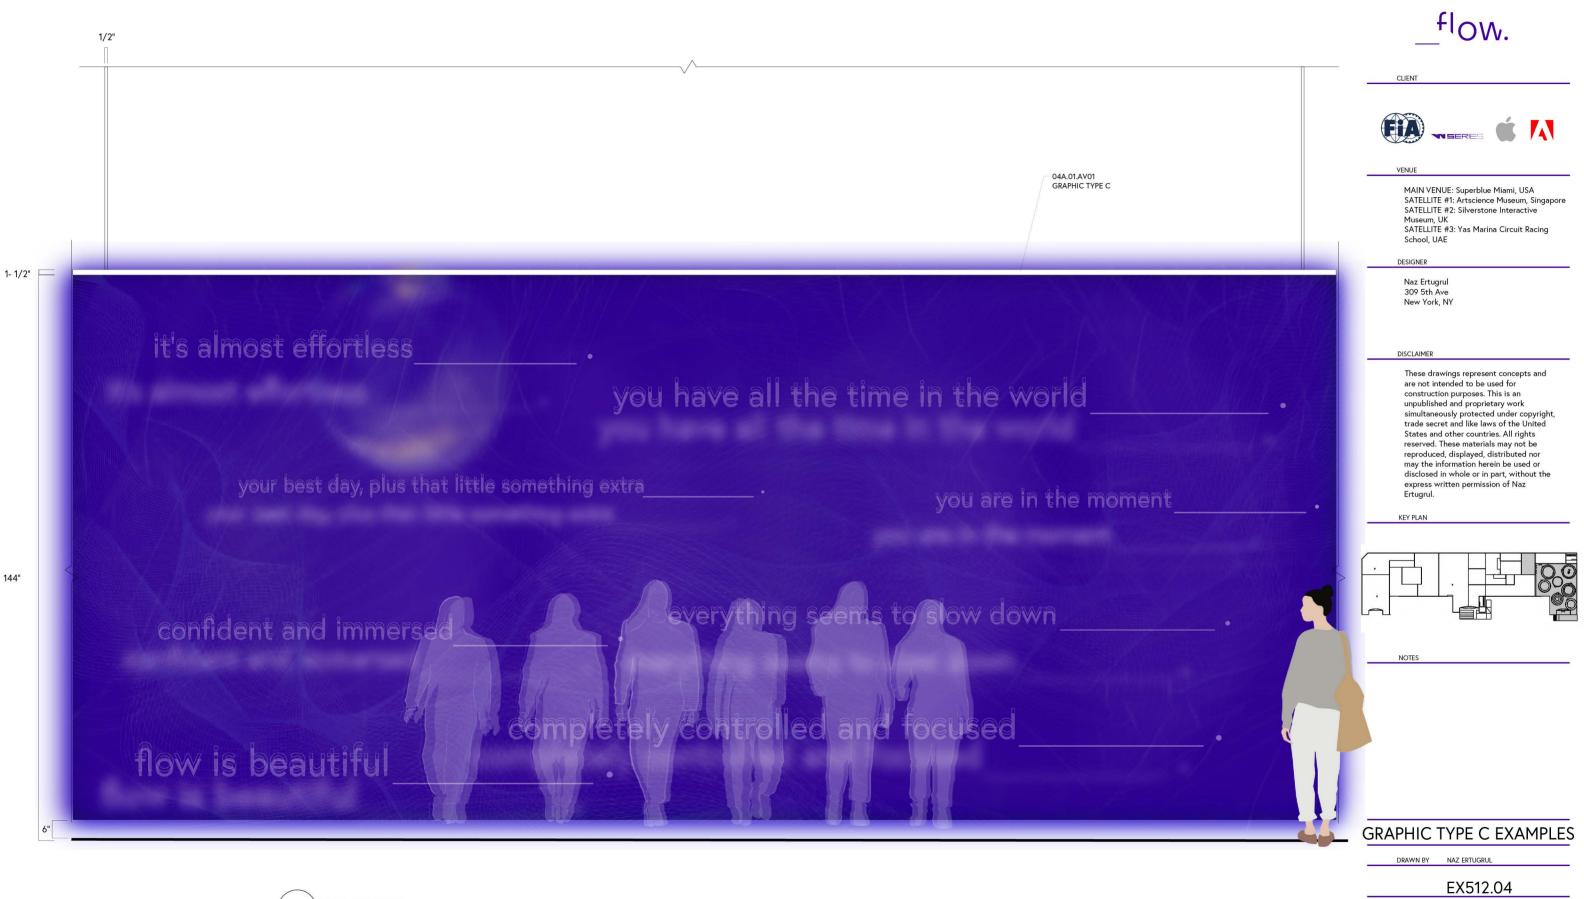
GRAPHIC TYPE C EXAMPLES

DRAWN BY NAZ ERTUGRUL

EX512.03

SCALE 1/2"=1'=0"

⊕N



04A.01.AV01 ELEVATION SCALE: 1/2"-1'-0"

 \bigcirc N

1/2" 05A.01.AV01 GRAPHIC TYPE C 1- 1/2" = 144" DHL Julius Bär 224"

_flow.







MAIN VENUE: Superblue Miami, USA SATELLITE #1: Artscience Museum, Singapore SATELLITE #2: Silverstone Interactive Museum, UK SATELLITE #3: Yas Marina Circuit Racing School, UAE

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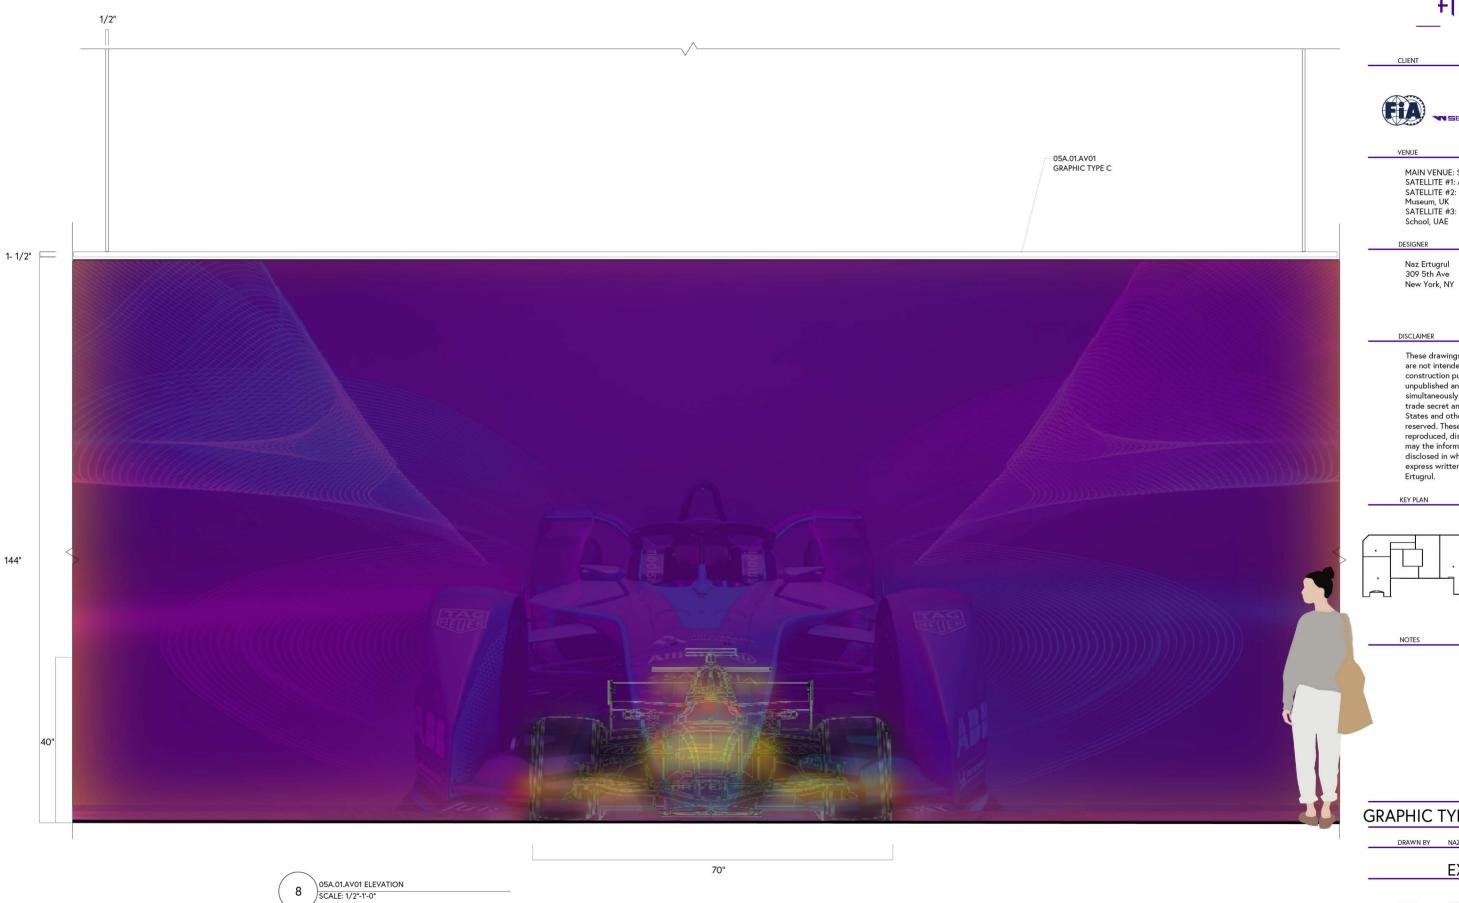
GRAPHIC TYPE C EXAMPLES

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EX512.05

1/2"=1'=0" SCALE

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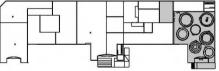








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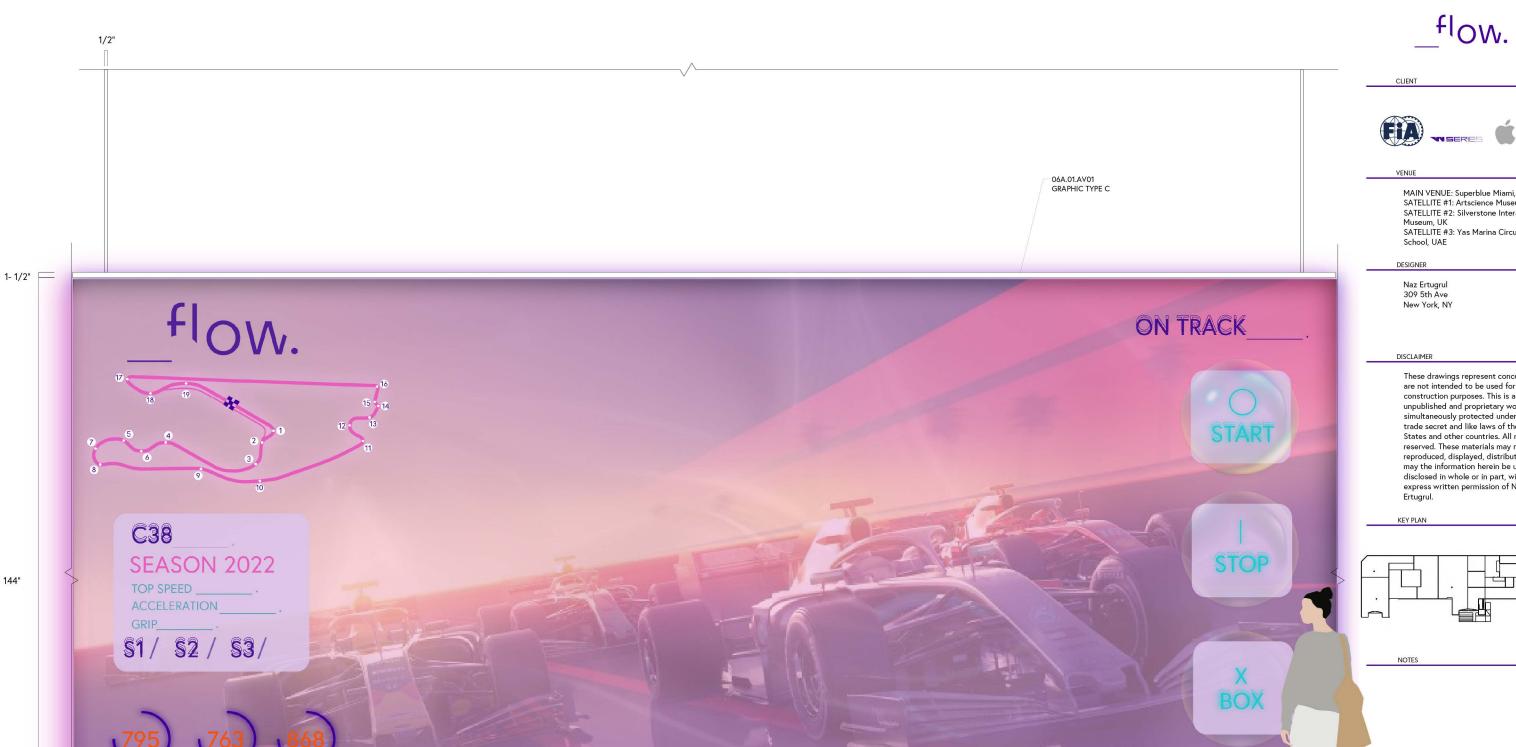
GRAPHIC TYPE C EXAMPLES

DRAWN BY NAZ ERTUGRUL

EX512.06

1/2"=1'=0" SCALE

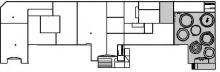
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GRAPHIC TYPE C EXAMPLES

DRAWN BY NAZ ERTUGRUL

EX512.07

SCALE 1/2"=1'=0"



144"

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VEN

MAIN VENUE: Superblue Miami, USA SATELLITE #1: Artscience Museum, Singapore SATELLITE #2: Silverstone Interactive Museum, UK SATELLITE #3: Yas Marina Circuit Racing School, UAE

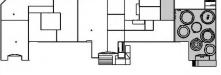
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NOTE

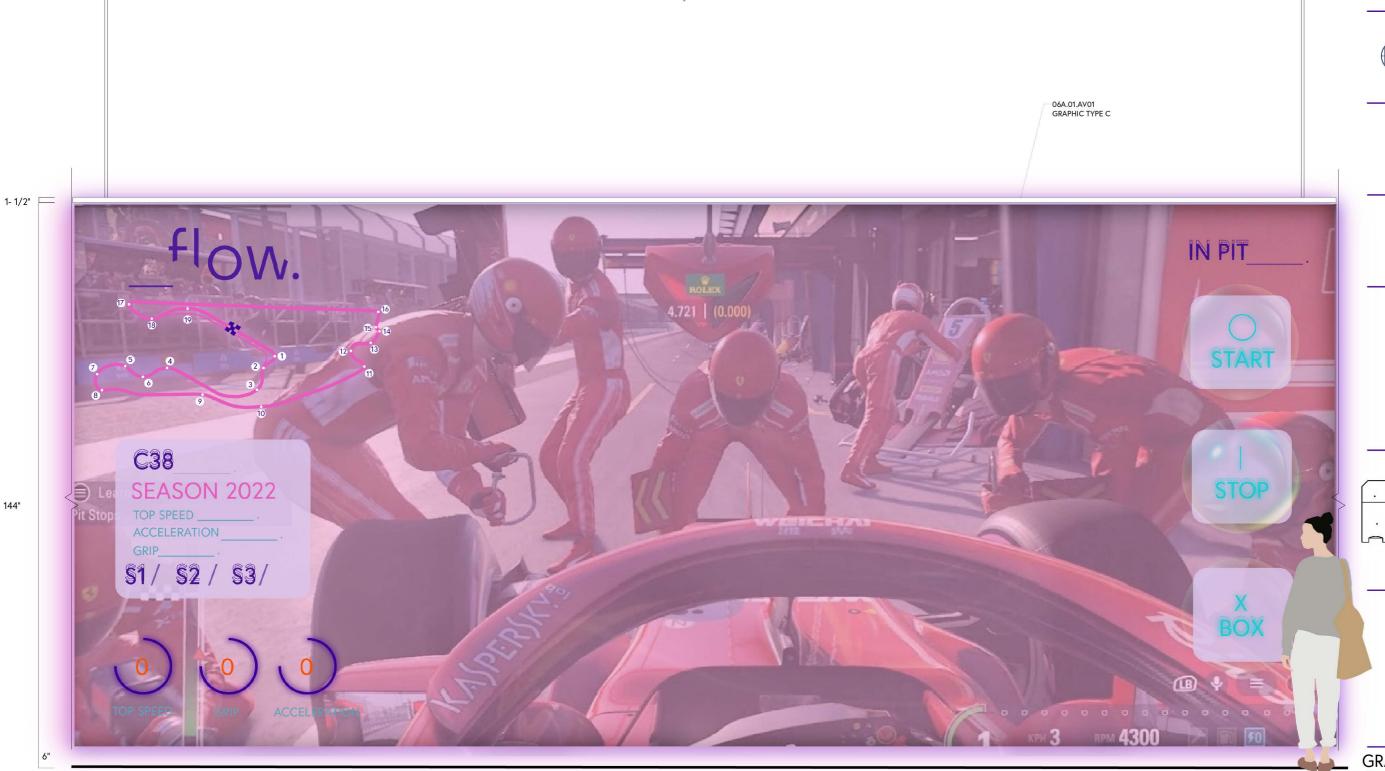
GRAPHIC TYPE C EXAMPLES

DRAWN BY NAZ ERTUGRUL

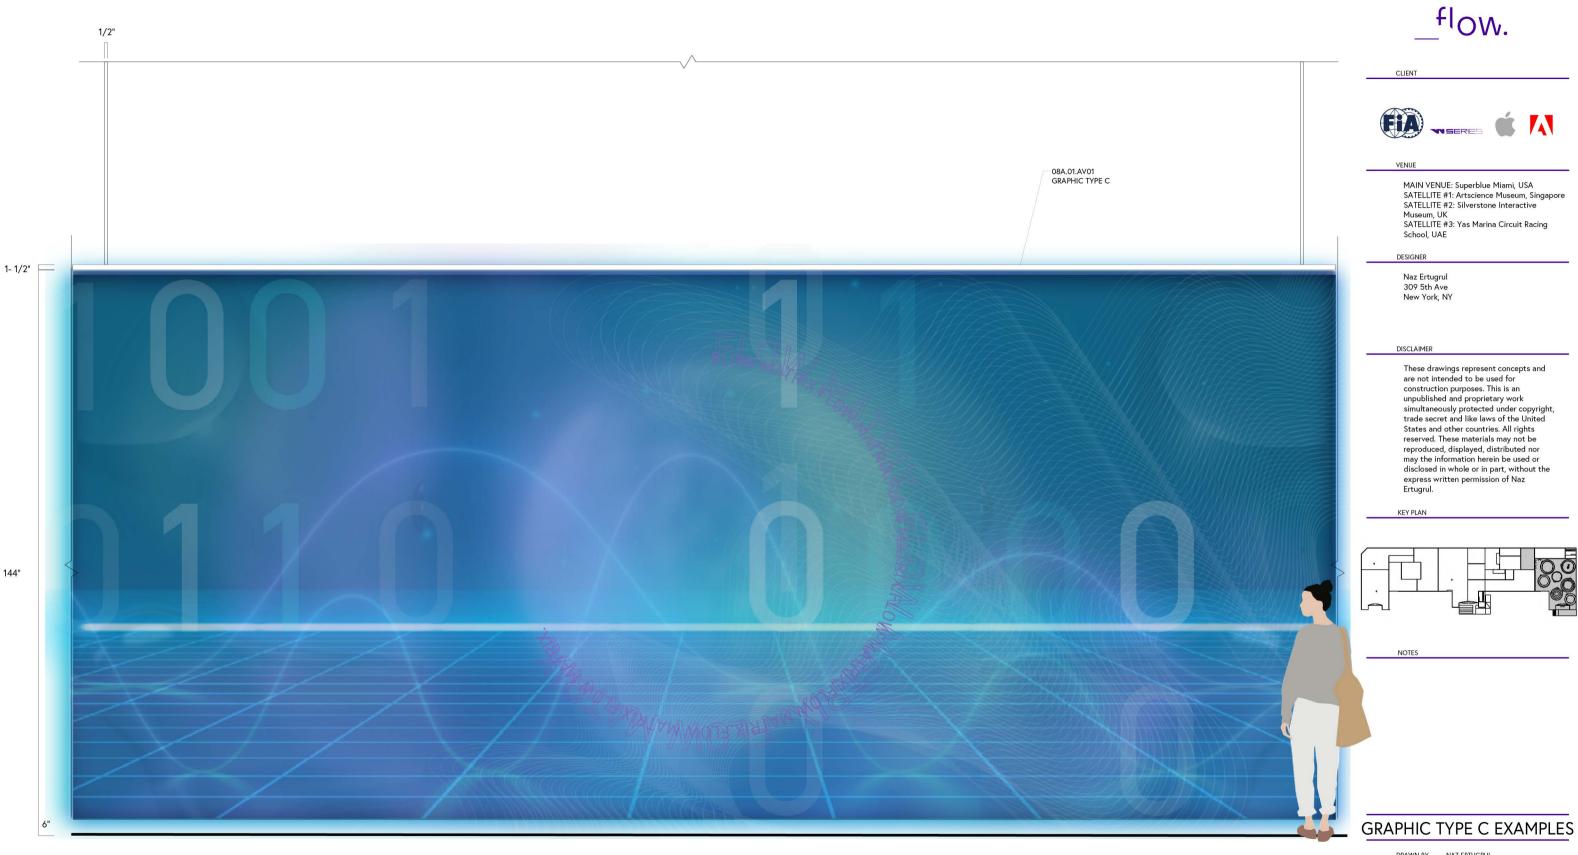
EX512.08

SCALE 1/2"=1'=0"





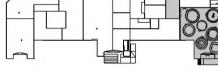
1/2"





MAIN VENUE: Superblue Miami, USA SATELLITE #1: Artscience Museum, Singapore SATELLITE #2: Silverstone Interactive

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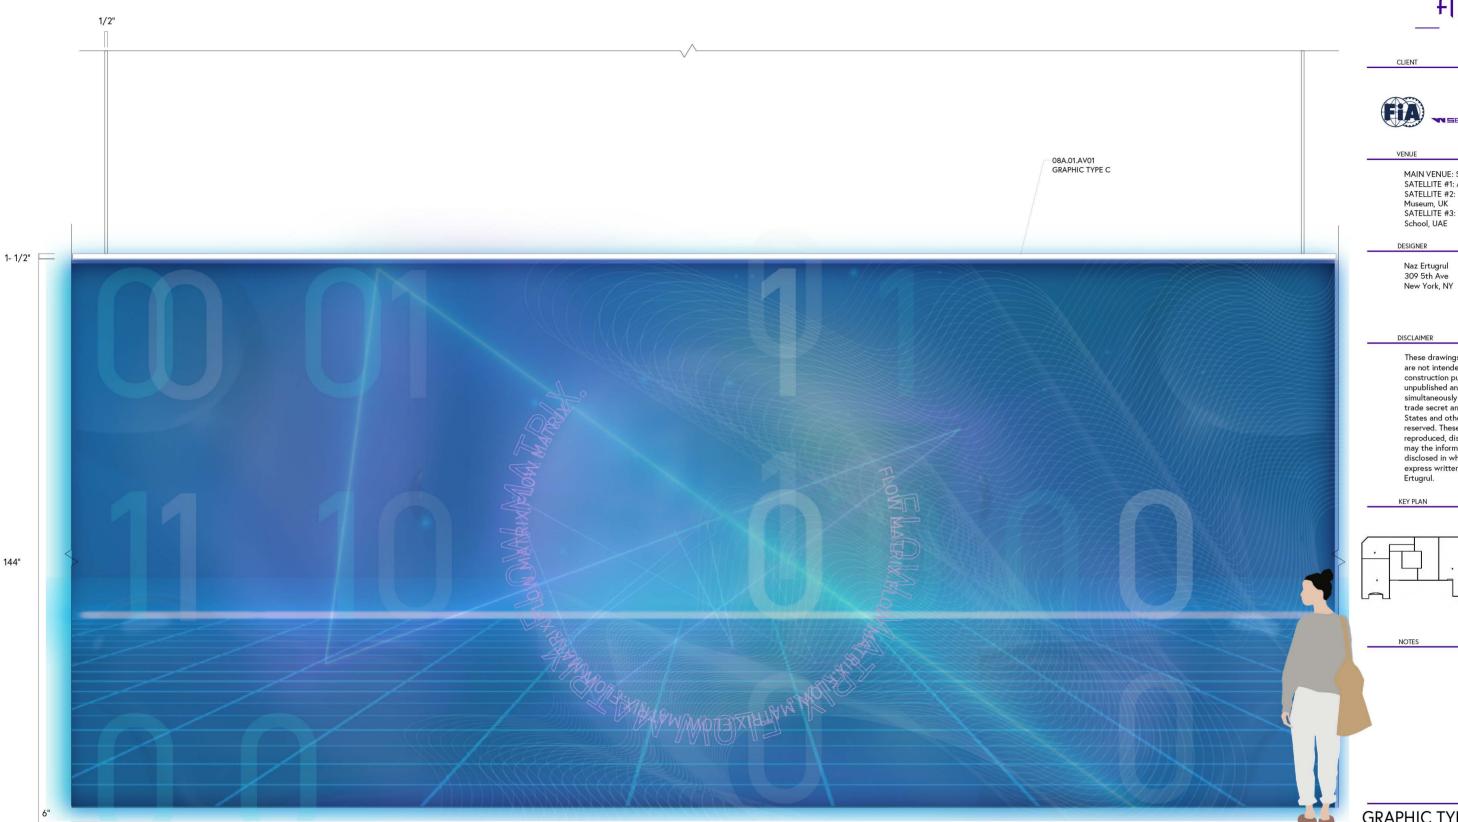
DRAWN BY NAZ ERTUGRUL

EX512.09

SCALE 1/2"=1'=0"



144"

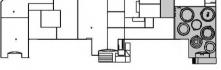








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GRAPHIC TYPE C EXAMPLES

DRAWN BY NAZ ERTUGRUL

EX512.10

SCALE 1/2"=1'=0" \bigcirc N

144"

1/8"

O7A.04.GR01
GRAPHIC TYPE D

O7A.04.GR02
GRAPHIC TYPE D

1 O7A.04.GR01-02 FRONT ELEVATION

3"

SPANISH GP, BARCELONA, 1975

07A.04.GR01-02 SIDE ELEVATION

SCALE: 1:1



CLIEN







VENITE

MAIN VENUE: Superblue Miami, USA SATELLITE #1: Artscience Museum, Singapore SATELLITE #2: Silverstone Interactive Museum, UK SATELLITE #3: Yas Marina Circuit Racing School, UAE

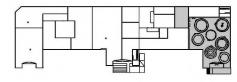
DESIGNER

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KEY PLAN



NOTES

GRAPHIC TYPE D DRAWINGS

DRAWN BY NAZ ERTUGRUL

EX513.01

SCALE



_flow.

CLIENT







VENIU

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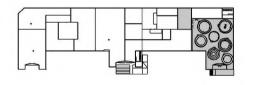
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GRAPHIC TYPE D DRAWINGS

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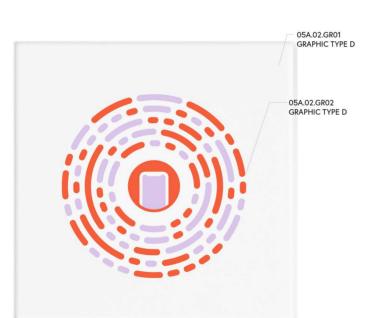
EX513.02

ŮИ

SCALE

1:1

3"



1/8"

1/4"

1/2" DIA

1 05A.02.GR01-02 FRONT ELEVATION SCALE: 1:1

3"

05A.02.GR01-02 SIDE ELEVATION

SCALE: 1:1



SUSIE WOLFF____.

GERMAN GP, HOCKENHEIM, 2014

JAMIE CHADWICK_____.

US GP, AUSTIN, 2021

flow.

CHENT







VENUE

MAIN VENUE: Superblue Miami, USA SATELLITE #1: Artscience Museum, Singapore SATELLITE #2: Silverstone Interactive Museum, UK SATELLITE #3: Yas Marina Circuit Racing School, UAE

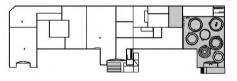
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KEY PLAN



NOTES

GRAPHIC TYPE D EXAMPLES

DRAWN BY NAZ ERTUGRUL

EX514.01

SCALE





CLIEN







VENUE

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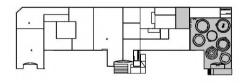
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NOTES

GRAPHIC TYPE D EXAMPLES

DRAWN BY NAZ ERTUGRUL

EX514.02

SCALE NTS







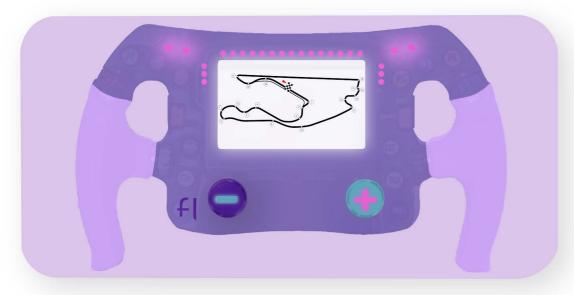






STEP 1

Visitors will see the layout of the track of the city they are visiting, and the start, the turning points also the finish line.



STEP 3

Lights beams on the steering wheel will appear and disappear as the visitors are completing the cues. The visitors will see the gear shifts on their screens.



1)03A.01.MD01 SCALE: NTS

STEP 2 _____

The app will display a N gear (neutral) at the start and through auditory cues, the audience will press the buttons to the increase and decrease gear as they are moving along.



STEP 4

To accompany the auditory cues the screen will indicate the turning points on the screen and send out a buzzing vibration when in need to make a turn.





CLIENT







VENUE

MAIN VENUE: Superblue Miami, USA SATELLITE #1: Artscience Museum, Singapore SATELLITE #2: Silverstone Interactive Museum, UK SATELLITE #3: Yas Marina Circuit Racing School, UAE

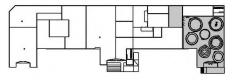
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NOTES

GRAPHIC TYPE E EXAMPLES

DRAWN BY NAZ ERTUGRUL

EX515.01

SCALE NTS

03A.01.MD01

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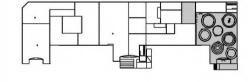
MAIN VENUE: Superblue Miami, USA SATELLITE #1: Artscience Museum, Singapore SATELLITE #2: Silverstone Interactive

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Museum, UK SATELLITE #3: Yas Marina Circuit Racing School, UAE

GRAPHIC TYPE E EXAMPLES

DRAWN BY NAZ ERTUGRUL

EX515.02

 \bigcirc N

04A.01.MD01

GRAPHIC TYPE E

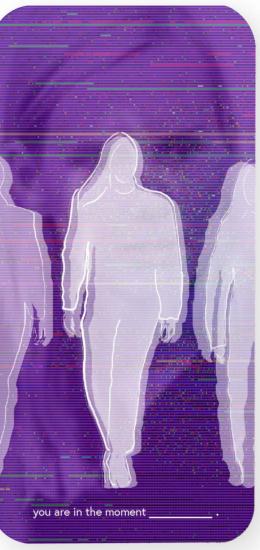
SCALE

ACTIVITY

Silhouettes of characters belonging to the exhibit "The Hidden Figures" appear on the screens. Visitors will utilize the app and their phone flashlight as a mirror glass to look inside the silhouette's figure/soul to learn excerpts about the characters' experiences of flow.



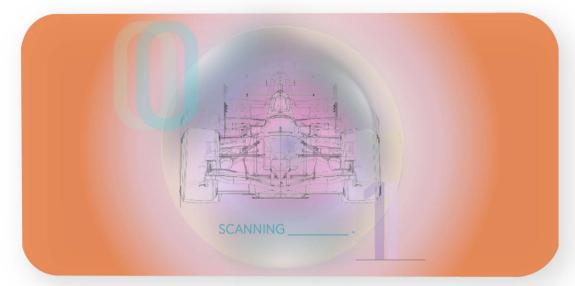






STEP 1

Visitors will place their phones horizontally to scan the 3D printed F1 car in the Limitless Phenomenon Exhibit. The appearance of the car will be changing through projections.



STEP 3

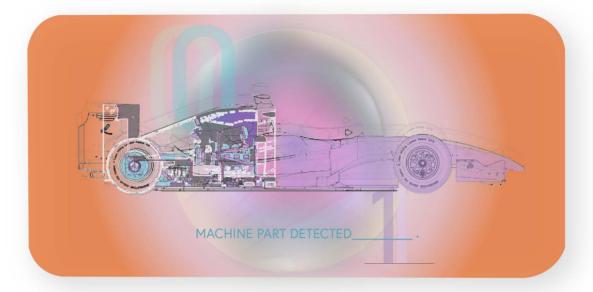
The name and the features of the machine part will appear with on the visitors' screens. They will be able to see the changes that has happened with its mechanics, technology and design.



3)05A.01.MD01 SCALE: NTS

STEP 2 _____

The app will display an x-ray of the cars and will enable the visitors to select a machine part to unpack.



STEP 4

Visitors will be able to extract each part of a single unit with an infinite zoom feature and learn about the memories of the cars that the exhibit characters drove.





CLIEN







VENU

MAIN VENUE: Superblue Miami, USA SATELLITE #1: Artscience Museum, Singapor SATELLITE #2: Silverstone Interactive Museum, UK SATELLITE #3: Yas Marina Circuit Racing School, UAE

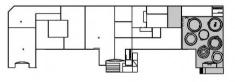
DESIGN

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KEY PLAN



NO

GRAPHIC TYPE E EXAMPLES

DRAWN BY NAZ ERTUGRUL

EX515.03

CCALE NITS



05A.01.MD01 GRAPHIC TYPE F STEP 1

Visitors will see the layout of the track of the city they are visiting, the start, the turning points and the finish line. They will recieve a number from 1-4 indicating the 4 wheels.



STEP 3

They will receive notifications on the acceleration, tyre grip and top speed as they follow the track and discover more about its engineering and design.



4)06A.01.MD01 SCALE: NTS STEP 2

The app will show arrows as directions to follow to for each wheel to make the turns into the chicanes on the virtual track. There will be a start, a stop and a box option.



STEP 4

There will be check-points to box throughout the track, and to participate in a virtual pit to replace parts from their smartphone screens as a team to continue on their lap.



flow.

CLIEN'







VENU

MAIN VENUE: Superblue Miami, USA SATELLITE #1: Artscience Museum, Singapor SATELLITE #2: Silverstone Interactive Museum, UK SATELLITE #3: Yas Marina Circuit Racing School, UAE

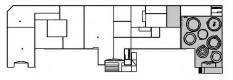
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KEY PLAI



NOTE

GRAPHIC TYPE E EXAMPLES

DRAWN BY NAZ ERTUGRUL

EX515.04

SCALE

DИ

06A.01.MD01







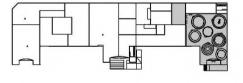
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GRAPHIC TYPE E EXAMPLES

DRAWN BY NAZ ERTUGRUL

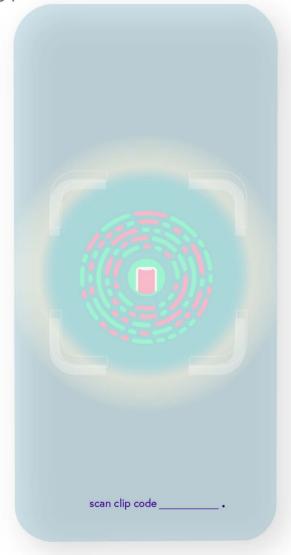
EX515.05

 \bigcirc N

ACTIVITY

Visitors will scan the app clip code to enter an empowering message regarding their journey in this experience, their current feelings, emotions, inspirations and aspirations. The message will be saved and broadcasted on the screens of all F1 tracks around the world when the races are taking place.









08A.01.MD01

08A.01.MD01

GRAPHIC TYPE E

CLIENT







VENUE

MAIN VENUE: Superblue Miami, USA SATELLITE #1: Artscience Museum, Singapore SATELLITE #2: Silverstone Interactive Museum, UK SATELLITE #3: Yas Marina Circuit Racing School, UAE

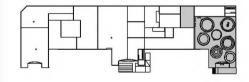
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KEY PLAN



NOT

GRAPHIC TYPE E EXAMPLES

DRAWN BY NAZ ERTUGRUL

EX515.06

SCALE NTS

⊕N

ACTIVITY____

Indicating the end of each activity, the flow app will display an infographic about the flow level the visitors are experiencing as a result of participating in an immersive activity. Visitors will see the change in the flow state as they continue in their journey with the logo filling up as bar chart to show the increasing impact.









03A.01.MD01 SCALE: NTS 7 04A.01.MD01 SCALE: NTS 8 06A.01.MD01 SCALE: NTS 9 08A.01.MD01 SCALE: NTS







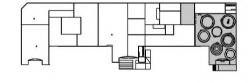
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GRAPHIC TYPE E EXAMPLES

DRAWN BY NAZ ERTUGRUL

EX515.07

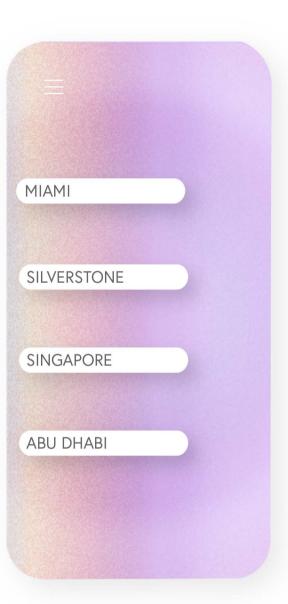
 \bigcirc N

ACTIVITY

As a collateral, the visitors will be able to preview the exhibition layouts prior to coming in to the exhibition spaces. Each layout of the exhibit will have a unique sequential order and a different flow. The layouts will be designed to mimic the tire marks on the race tracks and will have numerical wayfinding cues leading to each exhibit.









09A.01.MD01

09A.01.MD01

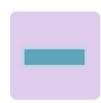
GRAPHIC TYPE E

POS5/20

CURRENT 56.556

BEST 1:53.86

§1/ §2/ §3,





TURN 1









scan clip code



you are now experiencing flow_____

SYMBOL GUIDE

In The Zone app will have it's unique app clip code for visitors to scan and turn their phones into steering wheels.

The app will display a position chart of each visitor participating in the practice lap annotating their best lap time as well as the current time as they are completing each sector of the track.

The sectors will be annotated with an "S" and will have its own lap time segment.

The "-" and "+" will both appear in the projection screen and the app screen to enable increase and decrease in gear.

The slim banner with turn numbers will indicate the location position of the visitor participating in the lap. It will be used as a directive for the visitors to act accordingly to make turns and to shift gears.

The triangle, "Delta" and the square, "DRS" command will be used to hold the phone straight and increase gear to the fullest.

The arrows will help guide the visitors to turn their phones to the right or left as they are completing their lap.

At the end of the activity, the flow bar chart will appear to indicate the average approximate flow level the visitors will be experiencing determined by the challenge/skill balance of the activity.



CLIENT







VENUE

MAIN VENUE: Superblue Miami, USA SATELLITE #1: Artscience Museum, Singapore SATELLITE #2: Silverstone Interactive Museum, UK SATELLITE #3: Yas Marina Circuit Racing School, UAE

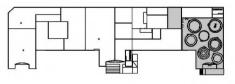
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KEY PLAN



NOTE

GRAPHIC TYPE H EXAMPLES

DRAWN BY NAZ ERTUGRUL

EX516.01

SCALE





turn on your flashlight _

hold your phone still

you are in the moment _

discover unique stories_



scan clip code



you are now experiencing flow

SYMBOL GUIDE

The Third Eye Rule will have it's unique app clip code for visitors to scan and turn their phones into a magnifying glass.

The app will display commands to slowly transition the app to become a peep hole for immersive content.

At the end of the activity, the flow bar chart will appear to indicate the average approximate flow level the visitors will be experiencing determined by the challenge/skill balance of the activity.









MAIN VENUE: Superblue Miami, USA SATELLITE #1: Artscience Museum, Singapore SATELLITE #2: Silverstone Interactive Museum, UK SATELLITE #3: Yas Marina Circuit Racing School, UAE

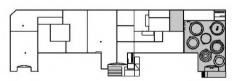
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NOTES

GRAPHIC TYPE H EXAMPLES

DRAWN BY NAZ ERTUGRUL

EX516.02

SCALE

 \bigcirc N

CO8______. POWER UNIT



200% ZOOM

SCANNING ____

MACHINE PART DETECTED .



scan clip code_____



you are now experiencing flow_____

3)05A.01.MD02 SCALE: NTS

SYMBOL GUIDE

The Limitless Phenomenon app will have it's unique app clip code for visitors to scan and turn their phones into an x-ray machine.

The app will display each mechanical component and their descriptions in an information box.

The slim banner will display the zoom percentage while examining the units and gear details.

There will be verbal status guides to indicate the process of scanning and detecting the machine part to be examined.

At the end of the activity, the flow bar chart will appear to indicate the average approximate flow level the visitors will be experiencing determined by the challenge/skill balance of the activity.



CLIENT







VENUE

MAIN VENUE: Superblue Miami, USA SATELLITE #1: Artscience Museum, Singapore SATELLITE #2: Silverstone Interactive Museum, UK SATELLITE #3: Yas Marina Circuit Racing School, UAE

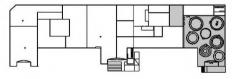
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NOTES

GRAPHIC TYPE H EXAMPLES

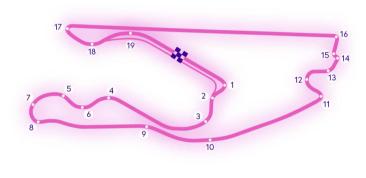
DRAWN BY NAZ ERTUGRUL

EX516.03

SCALE

① N









VALUE CONTROL_









Core Volume app will have it's unique app clip code for visitors to scan and turn their phones into an AR race car wheel.

The app will display a status chart of each visitor participating in the lap annotating their top speed, acceleration and grip as they are completing each sector of the track.

The sectors will be annotated with an "S" and will have its own status segment.

The key track map will appear in the projection screen and the app screen to show participant location in the track.

The current numerical data of top speed, grip and acceleration will be visible at the bottom of the screen and updated in real time.

The arrows will help guide the visitors to turn their phones to the right or left as they are completing their lap.

The screen will indicate a written active status depending the participant is in the pit or on the track.

The circle, "Start", the bar "Stop", the letter x, "Box" will indicate the commands that the visitors will be able to utilize to perform a pit stop.

At the end of the activity, the flow bar chart will appear to indicate the average approximate flow level the visitors will be experiencing determined by the challenge/skill balance of the activity.



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VENUE

MAIN VENUE: Superblue Miami, USA SATELLITE #1: Artscience Museum, Singapor SATELLITE #2: Silverstone Interactive Museum, UK SATELLITE #3: Yas Marina Circuit Racing School, UAE

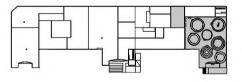
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KEY PLAN



NOTES

GRAPHIC TYPE H EXAMPLES

DRAWN BY NAZ ERTUGRUL

EX516.04

SCALE NTS



ON TRACK____



STOF

BOX









scan clip code _____



you are now experiencing flow_____.

enter your message_



you are now experiencing flow_

SYMBOL GUIDE

Flow Matrix will have it's unique app clip code for visitors to scan and turn their phones into an algorithmic data server.

The app will display commands to slowly transition the app to become a matrix for immersive content.

At the end of the activity, the flow bar chart will appear to indicate the average approximate flow level the visitors will be experiencing determined by the challenge/skill balance of the activity.









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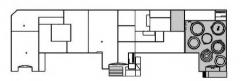
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NOTES

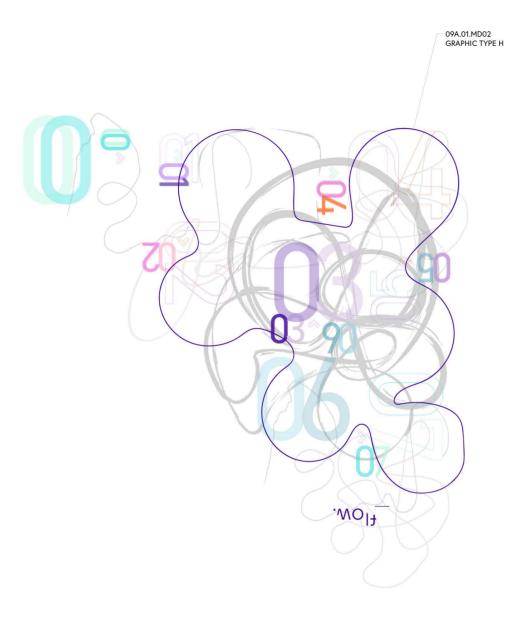
GRAPHIC TYPE H EXAMPLES

DRAWN BY NAZ ERTUGRUL

EX516.05

SCALE





SYMBOL GUIDE

Flow in Superblue Miami will have its unique sequential order of activities and a specialized floor graphic wayfinding system in tangent to an app.

The numbers will indicate the activity order to follow to complete the journey.

To accompany the visual aesthetic of the environment tire mark prints will be used to give a race track feel to the exhibition layout.

flow.







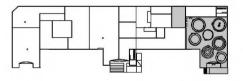
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KEY PLAN



GRAPHIC TYPE H EXAMPLES

DRAWN BY NAZ ERTUGRUL

EX516.06

 \bigcirc N

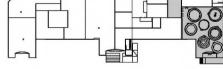








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GRAPHIC TYPE F DRAWINGS

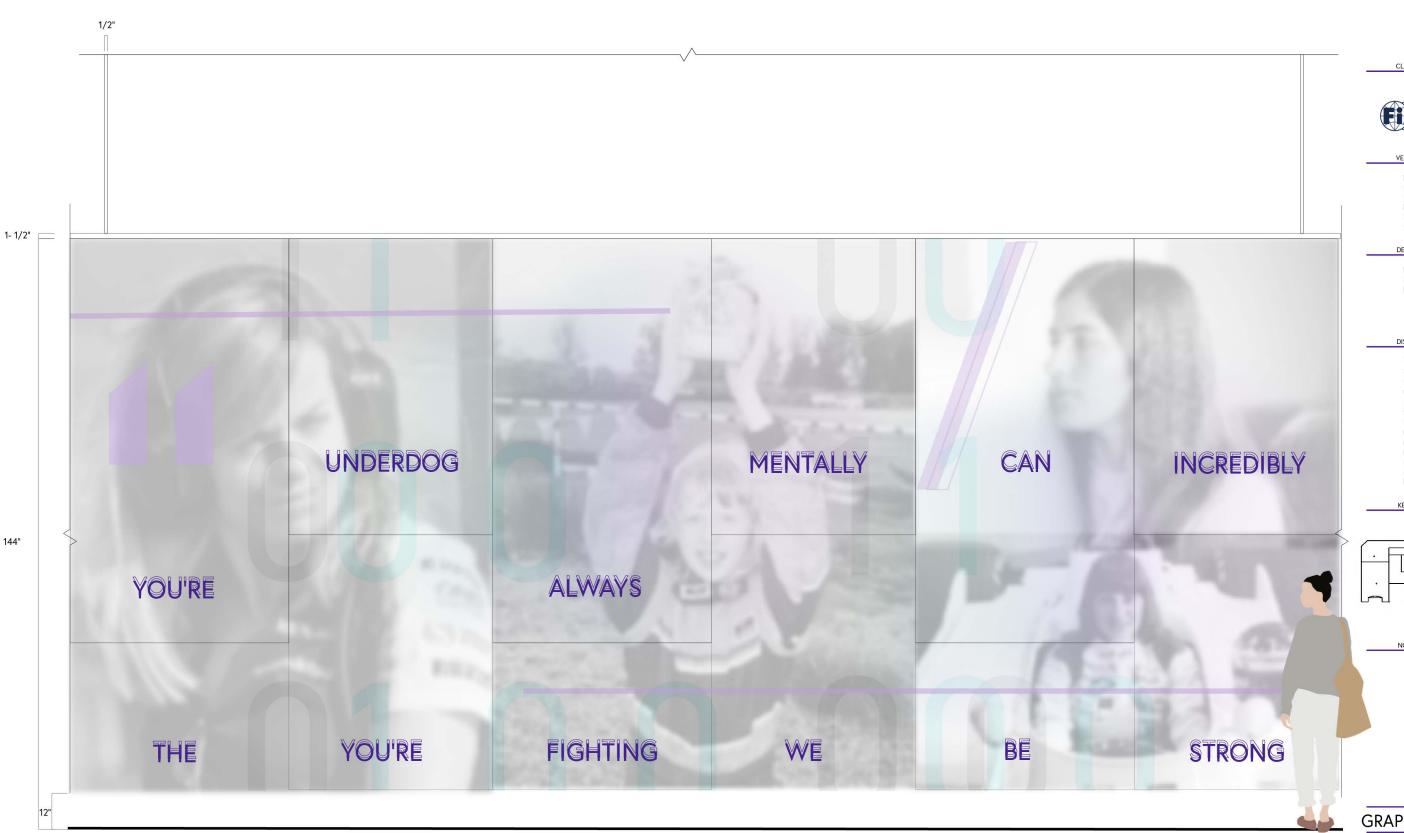
DRAWN BY NAZ ERTUGRUL

EX517.01

1/2"=1'-0" SCALE

 \bigcirc N

07A.03.GR01-02 & 07A.01.AV01 ELEVATION











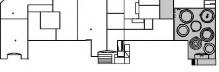
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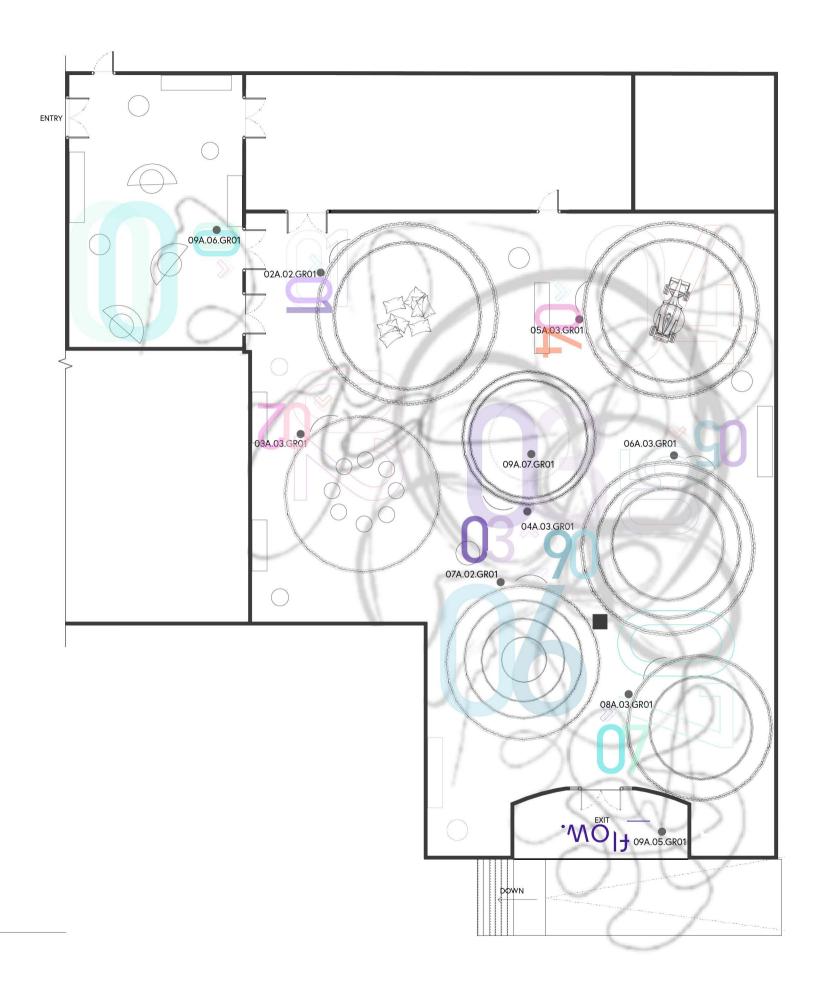
GRAPHIC TYPE F DRAWINGS

DRAWN BY NAZ ERTUGRUL

EX517.02

1/2"=1'-0" SCALE

DИ



GRAPHIC TYPE G FLOORPLAN SCALE: 1/16"=1'-0"



CLIEN







VENUE

MAIN VENUE: Superblue Miami, USA SATELLITE #1: Artscience Museum, Singapore SATELLITE #2: Silverstone Interactive Museum, UK SATELLITE #3: Yas Marina Circuit Racing School, UAE

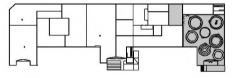
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NOTES

GRAPHIC TYPE G DRAWINGS

DRAWN BY NAZ ERTUGRUL

EX518.01

SCALE 1/16"=1'-0"





CLIENT







VENUE

MAIN VENUE: Superblue Miami, USA SATELLITE #1: Artscience Museum, Singapore SATELLITE #2: Silverstone Interactive Museum, UK SATELLITE #3: Yas Marina Circuit Racing School, UAE

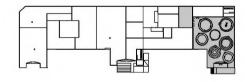
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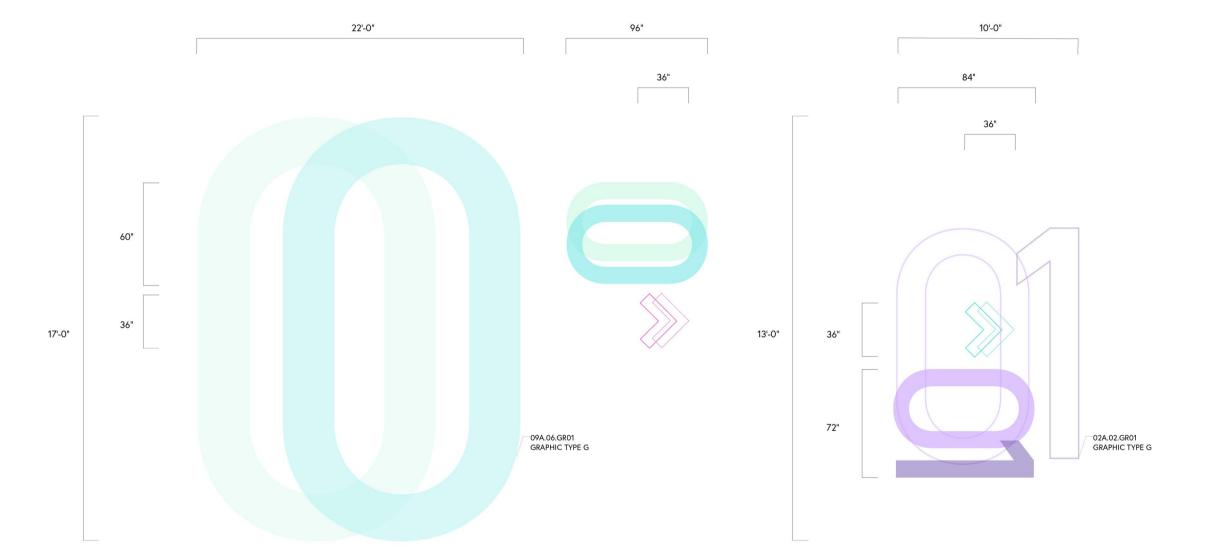
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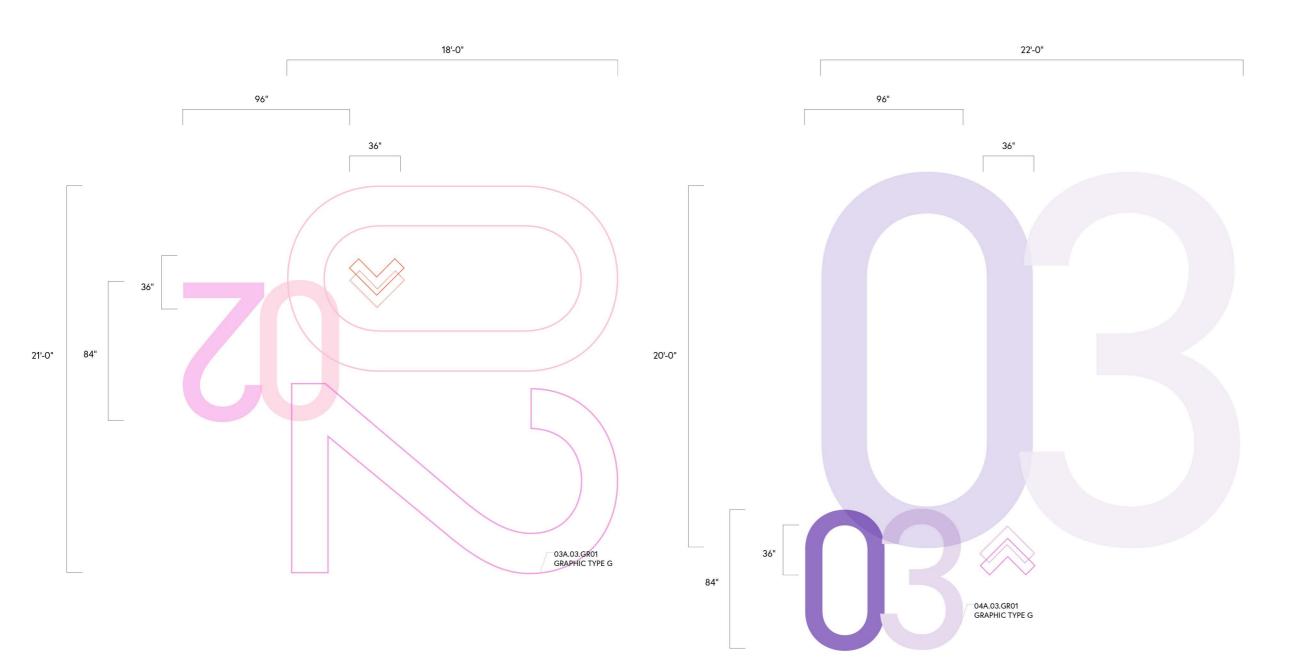
DRAWN BY NAZ ERTUGRUL

EX518.02

SCALE 3/16"=1'-0"









CLIEN







VENUE

MAIN VENUE: Superblue Miami, USA SATELLITE #1: Artscience Museum, Singapore SATELLITE #2: Silverstone Interactive Museum, UK SATELLITE #3: Yas Marina Circuit Racing School, UAE

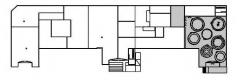
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NOTES

GRAPHIC TYPE G DRAWINGS

DRAWN BY NAZ ERTUGRUL

EX518.03

SCALE 3/16"=1'-0"

ŮИ

4 03A.03.GR01 PLAN VIEW SCALE: 3/16"=1'-0" 5)04A.03.GR01 PLAN VIEW SCALE: 3/16"=1'-0"







VENITE

MAIN VENUE: Superblue Miami, USA SATELLITE #1: Artscience Museum, Singapore SATELLITE #2: Silverstone Interactive Museum, UK SATELLITE #3: Yas Marina Circuit Racing School, UAE

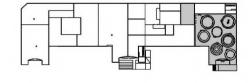
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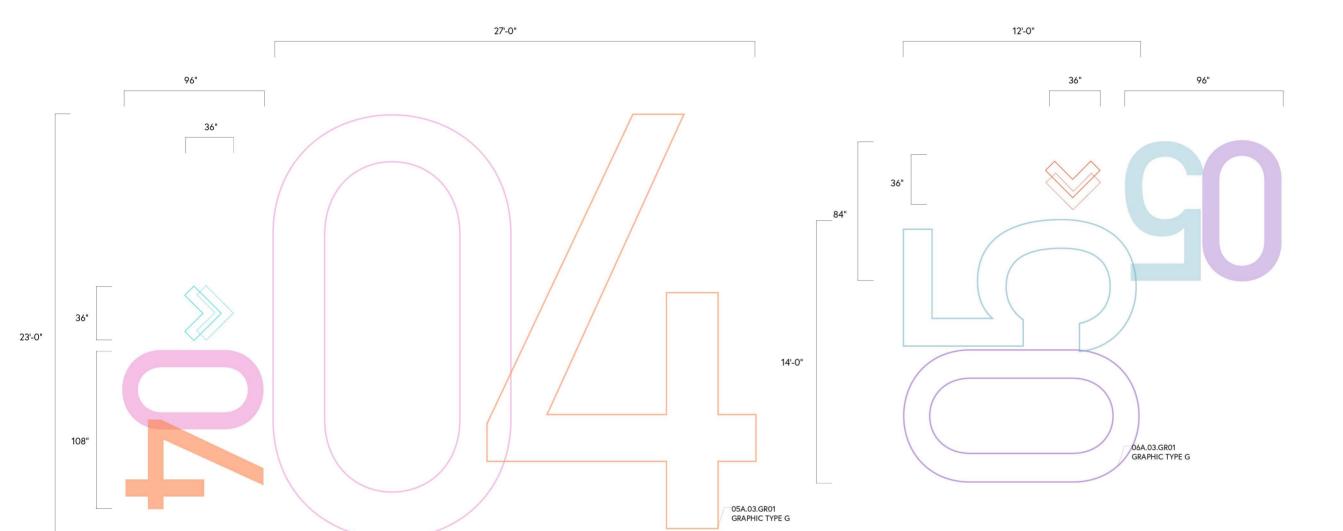
GRAPHIC TYPE G DRAWINGS

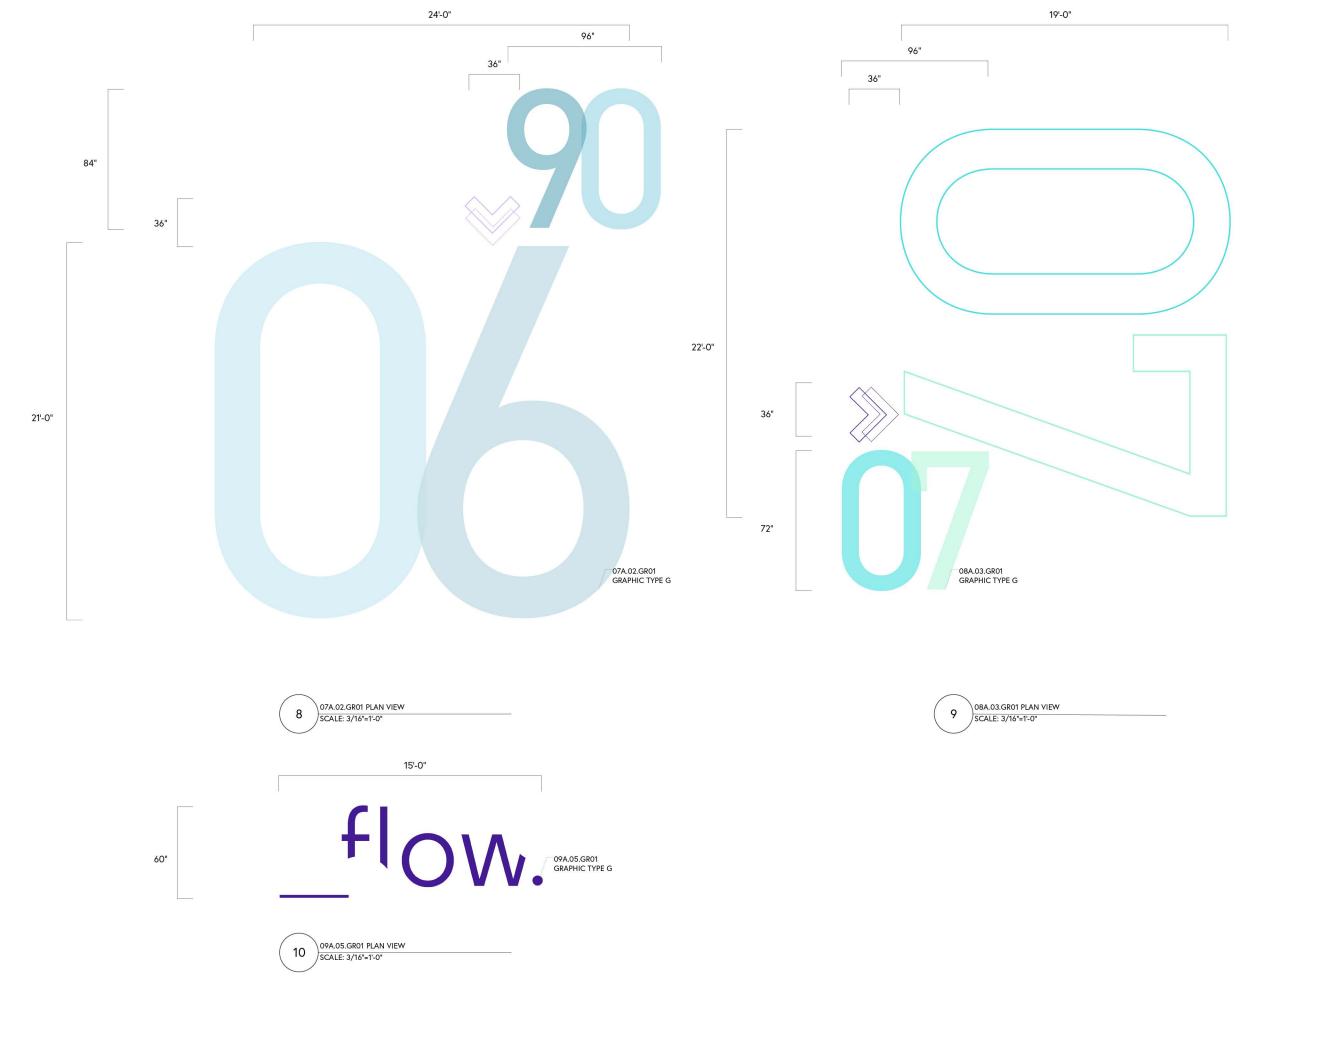
DRAWN BY NAZ ERTUGRUL

EX518.04

SCALE 3/16"=1'-0"

⊕N







CHEN







VENUE

MAIN VENUE: Superblue Miami, USA SATELLITE #1: Artscience Museum, Singapore SATELLITE #2: Silverstone Interactive Museum, UK SATELLITE #3: Yas Marina Circuit Racing School, UAE

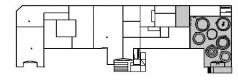
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NOTES

GRAPHIC TYPE G DRAWINGS

DRAWN BY NAZ ERTUGRUL

EX518.05

SCALE 3/16"=1'-0"





125'-0"



CLIEN







VENUE

MAIN VENUE: Superblue Miami, USA SATELLITE #1: Artscience Museum, Singapore SATELLITE #2: Silverstone Interactive Museum, UK SATELLITE #3: Yas Marina Circuit Racing School, UAE

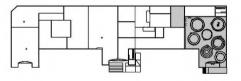
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KEY PLAN



NOTES

GRAPHIC TYPE G DRAWINGS

DRAWN BY NAZ ERTUGRUL

EX518.06

SCALE 1/16"=1'-0"

⊕N







VENU

MAIN VENUE: Superblue Miami, USA SATELLITE #1: Artscience Museum, Singapore SATELLITE #2: Silverstone Interactive Museum, UK SATELLITE #3: Yas Marina Circuit Racing School, UAE

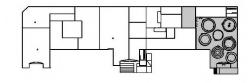
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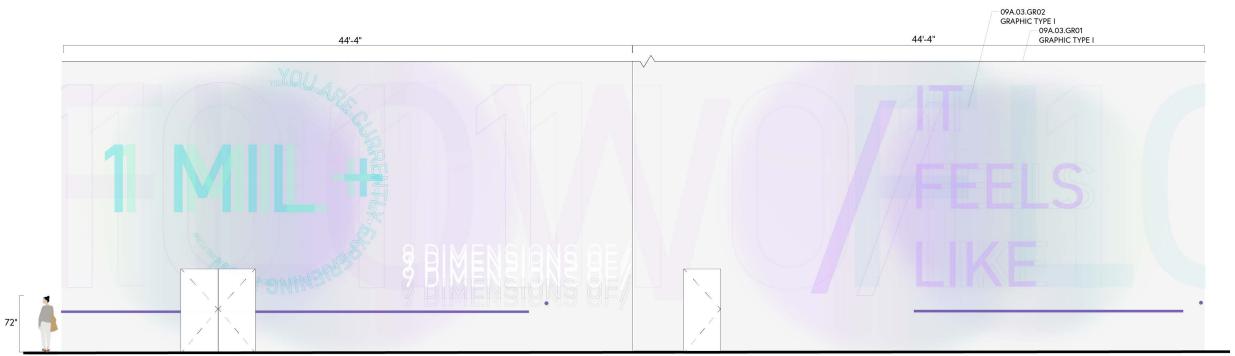


DRAWN BY NAZ ERTUGRUL

EX519.01

SCALE 1/8"=1'-0"





09A.03.GR01-02 NORTH WALL ELEVATION

SCALE: 1/8"=1'-0"

256"







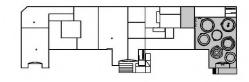
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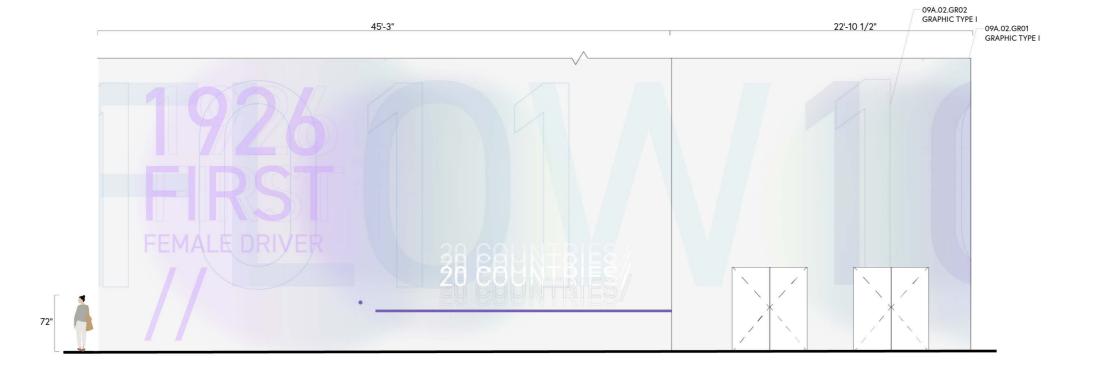
NOTES

GRAPHIC TYPE I DRAWINGS

DRAWN BY NAZ ERTUGRUL

EX519.02

SCALE 1/8"=1'-0" \bigcirc N



256"







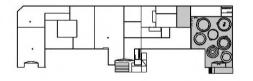
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NOTES

GRAPHIC TYPE I DRAWINGS

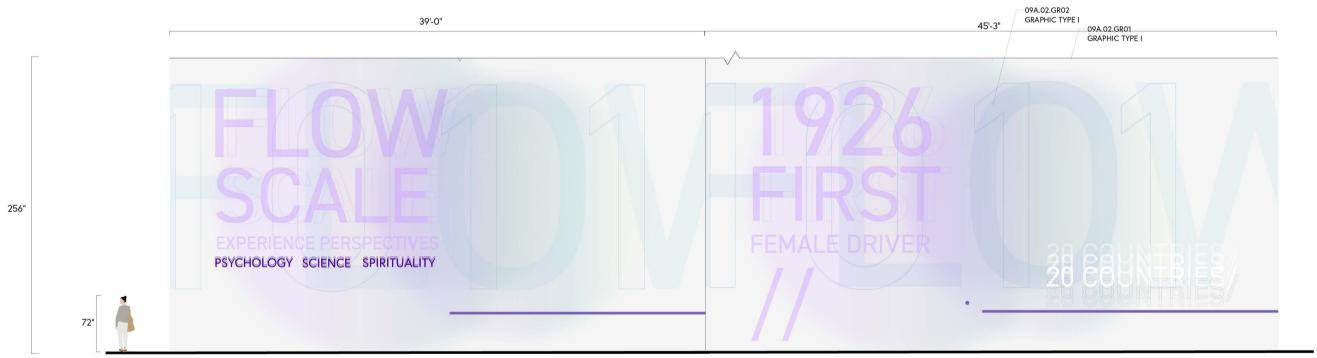
DRAWN BY NAZ ERTUGRUL

EX519.03

SCALE

1/8"=1'-0"

 \bigcirc N









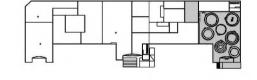
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NOTES

116'-0" 09A.04.GR01 GRAPHIC TYPE I

O9A.04.GR02 GRAPHIC TYPE I

256"

72"

GRAPHIC TYPE I DRAWINGS

DRAWN BY NAZ ERTUGRUL

EX519.04

1/8"=1'-0" SCALE

 \bigcirc N







VENU

MAIN VENUE: Superblue Miami, USA SATELLITE #1: Artscience Museum, Singapore SATELLITE #2: Silverstone Interactive Museum, UK SATELLITE #3: Yas Marina Circuit Racing School, UAE

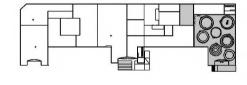
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NOTES





As a post-visit experience, visitors will receive a special code to access their unique chronicled journey of the activities that they have participated in the exhibition space through the Flow App and they will be able share it after on all social media platforms as they wish.

PRE & POST EXPERIENCE

DRAWN BY NAZ ERTUGRUL

EX520.01

SCALE N













Flow, the experience will have its own website and app clip for pre-visit information and post-visit follow-up activities.

The tickets for Flow, the experience will be accessible through all exhibition venue websites as well as F1 and Wseries ticket sale platforms.

Each race ticket holder will be granted premium access to all experiences around the globe, getting a chance to meet the female idols of the experience.



CLIEN







VENU

MAIN VENUE: Superblue Miami, USA SATELLITE #1: Artscience Museum, Singapore SATELLITE #2: Silverstone Interactive Museum, UK SATELLITE #3: Yas Marina Circuit Racing School, UAE

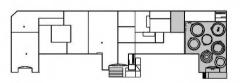
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KEY PLAN



NOTES

PRE & POST EXPERIENCE

DRAWN BY NAZ ERTUGRUL

EX520.02

SCALE











CLII







VENU

MAIN VENUE: Superblue Miami, USA SATELLITE #1: Artscience Museum, Singapore SATELLITE #2: Silverstone Interactive Museum, UK SATELLITE #3: Yas Marina Circuit Racing School, UAE

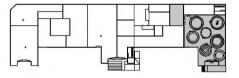
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NOTE

PROTOTYPE TESTING

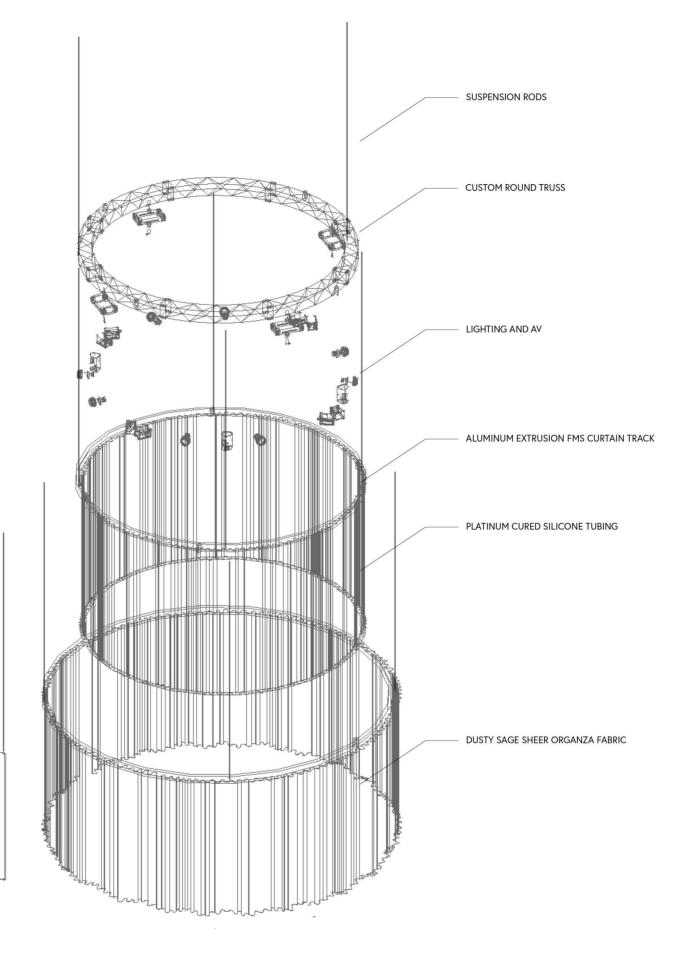
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EX521

SCALE

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FX 60u DFTAIL URAWINGS_____.











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DETAIL DRAWINGS

DRAWN BY NAZ ERTUGRUL

EX601

1/8"=1'-0" SCALE

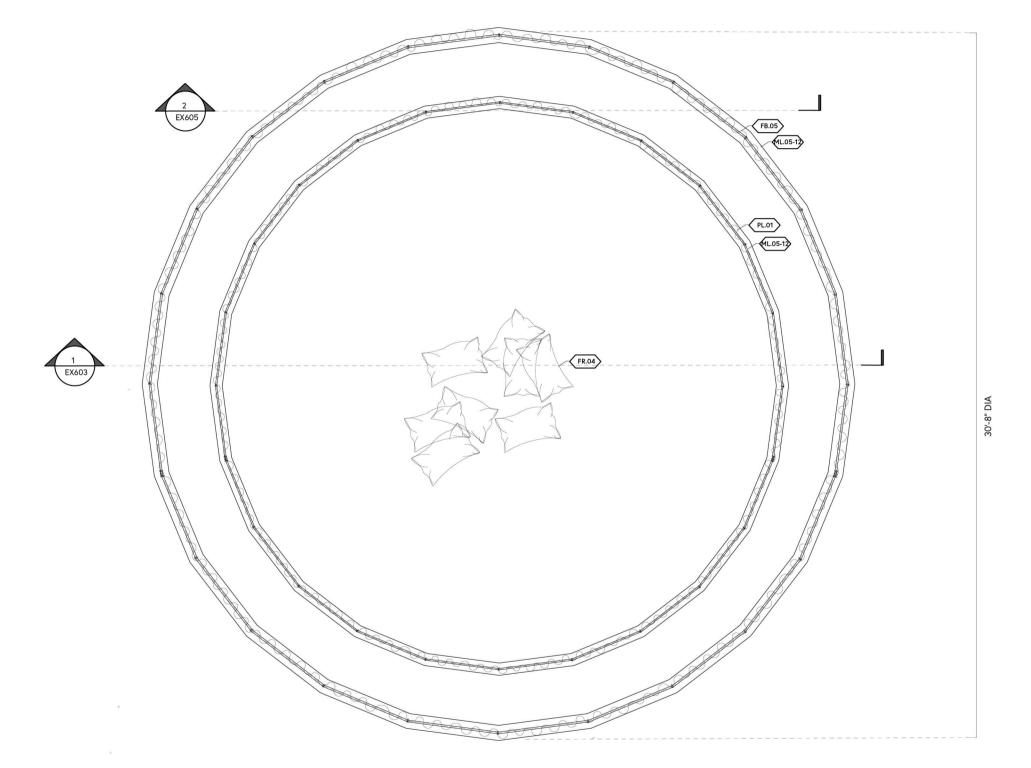


THEME AREA 1 ROUND CAROUSEL EXPLODED AXO

STEEL CABLE STRING

VOLANDO VOILE FABRIC

SCALE: 1/8"=1'-0"





CLIE







VEN

MAIN VENUE: Superblue Miami, USA SATELLITE #1: Artscience Museum, Singapore SATELLITE #2: Silverstone Interactive Museum, UK SATELLITE #3: Yas Marina Circuit Racing School, UAE

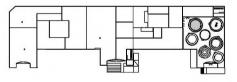
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KEY PLAN



NOTE

DETAIL DRAWINGS

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EX602

SCALE 1/4"=1'-0"



1 THEME AREA 1 PARTIAL FLOORPLAN SCALE: 1/4"=1'-0"







VENUE

MAIN VENUE: Superblue Miami, USA SATELLITE #1: Artscience Museum, Singapore SATELLITE #2: Silverstone Interactive Museum, UK SATELLITE #3: Yas Marina Circuit Racing School, UAE

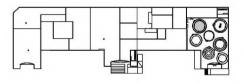
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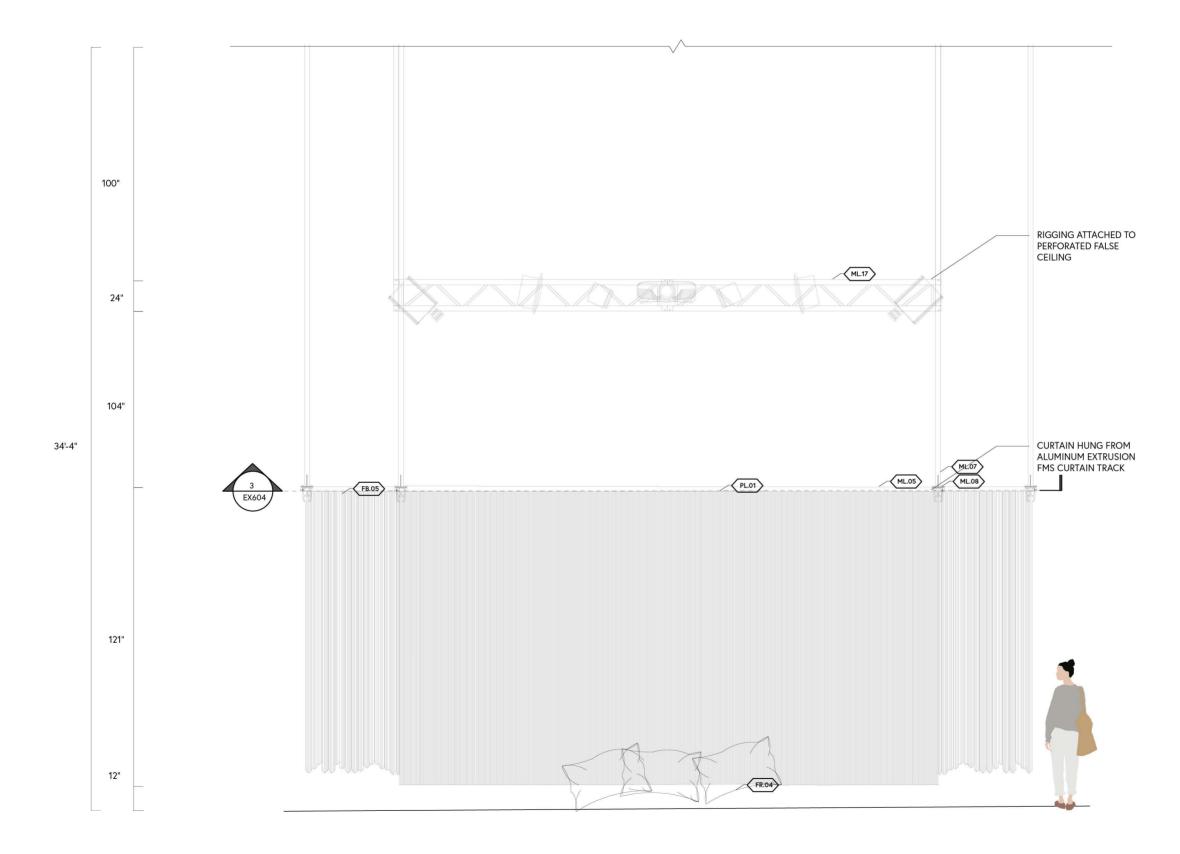
DETAIL DRAWINGS

DRAWN BY NAZ ERTUGRUL

EX603

SCALE 1/4"=1'-0"







CHEN







VENUE

MAIN VENUE: Superblue Miami, USA SATELLITE #1: Artscience Museum, Singapore SATELLITE #2: Silverstone Interactive Museum, UK SATELLITE #3: Yas Marina Circuit Racing School, UAE

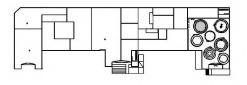
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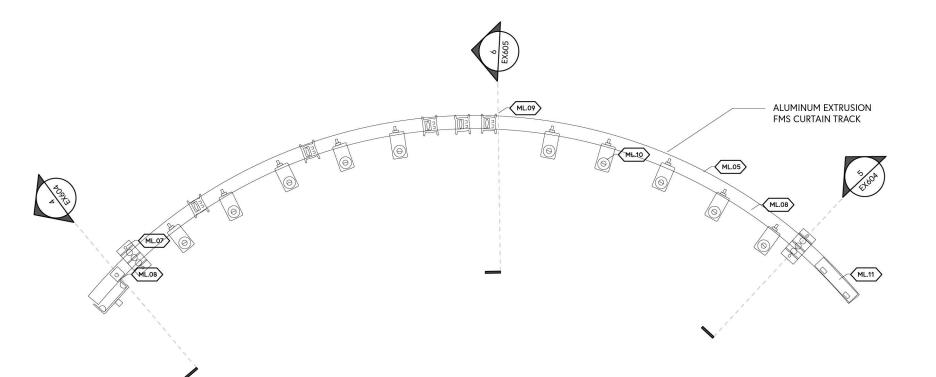
DETAIL DRAWINGS

DRAWN BY NAZ ERTUGRUL

EX604

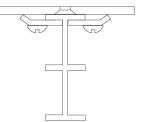
SCALE MULTIPLE







4 MTS CEILING BRACKET
SCALE: 3"=1'-0"



5 MTS SUSPENSION ROD AND CLAMP SCALE: 3"=1'-0"



CLIENT







VENIII

MAIN VENUE: Superblue Miami, USA SATELLITE #1: Artscience Museum, Singapore SATELLITE #2: Silverstone Interactive Museum, UK SATELLITE #3: Yas Marina Circuit Racing School, UAE

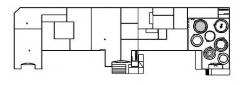
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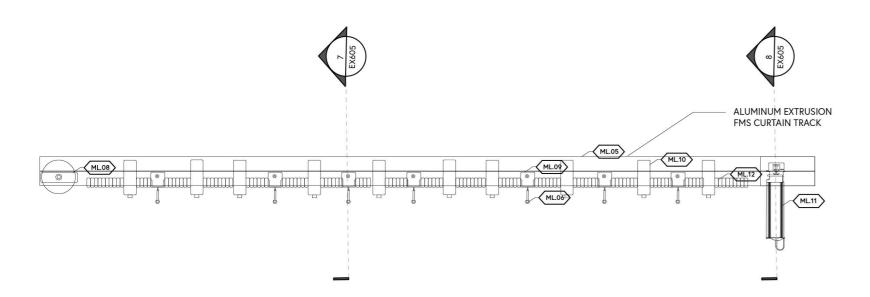


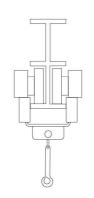
DRAWN BY NAZ ERTUGRUL

EX605

SCALE MULTIPLE



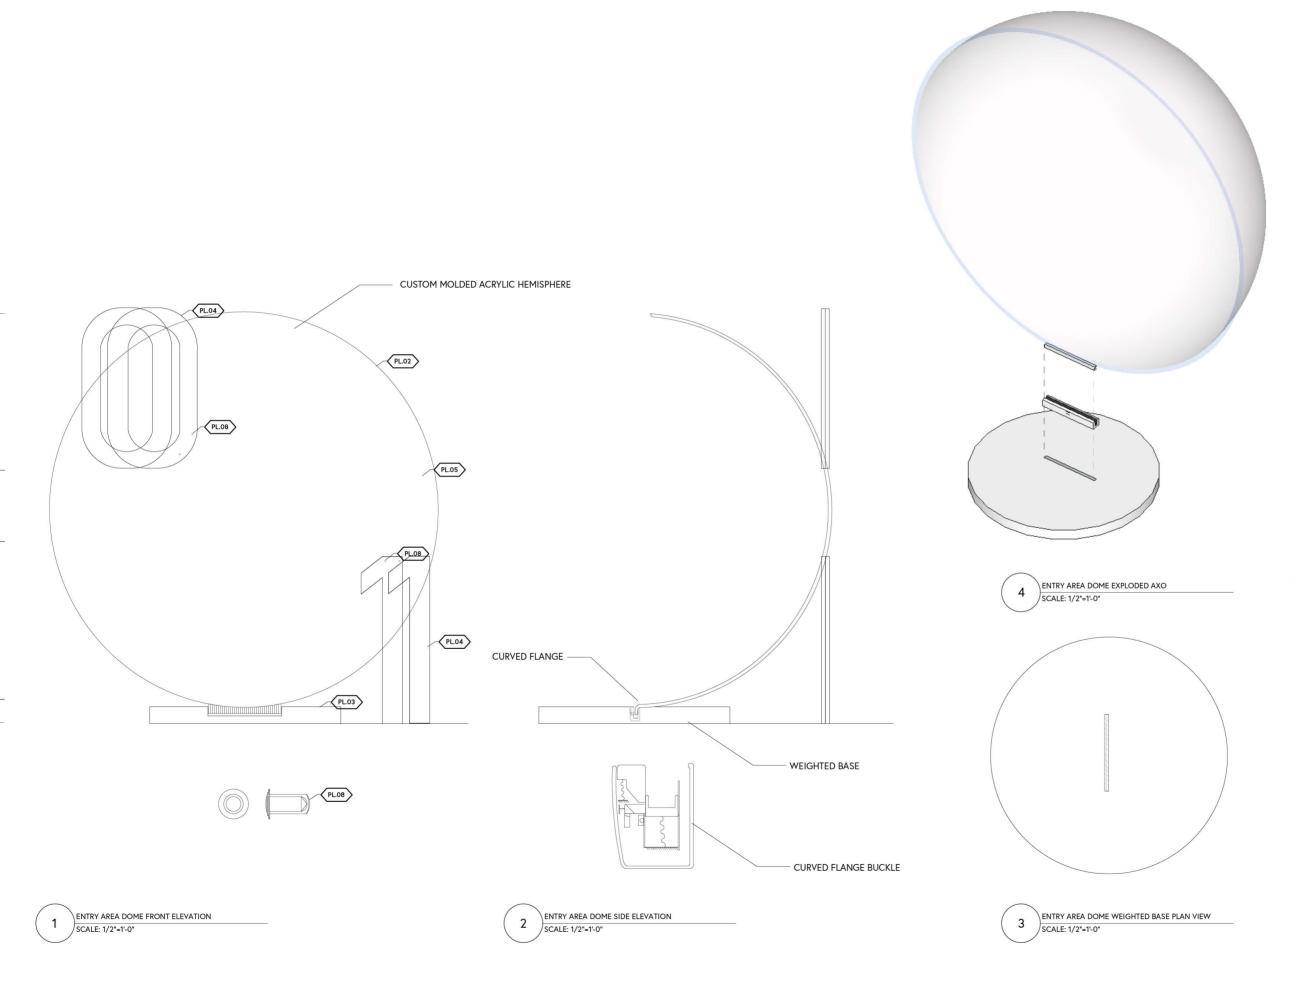




MTS TRACK BRIDGE & MTS METAL HOOK SCALE: 3"=1'-0"



8 FOREST SHUTTLE M MOTOR
SCALE: 3"=1'-0"



36"

18"

42"



CLIE







VENUE

MAIN VENUE: Superblue Miami, USA SATELLITE #1: Artscience Museum, Singapore SATELLITE #2: Silverstone Interactive Museum, UK SATELLITE #3: Yas Marina Circuit Racing School, UAE

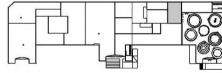
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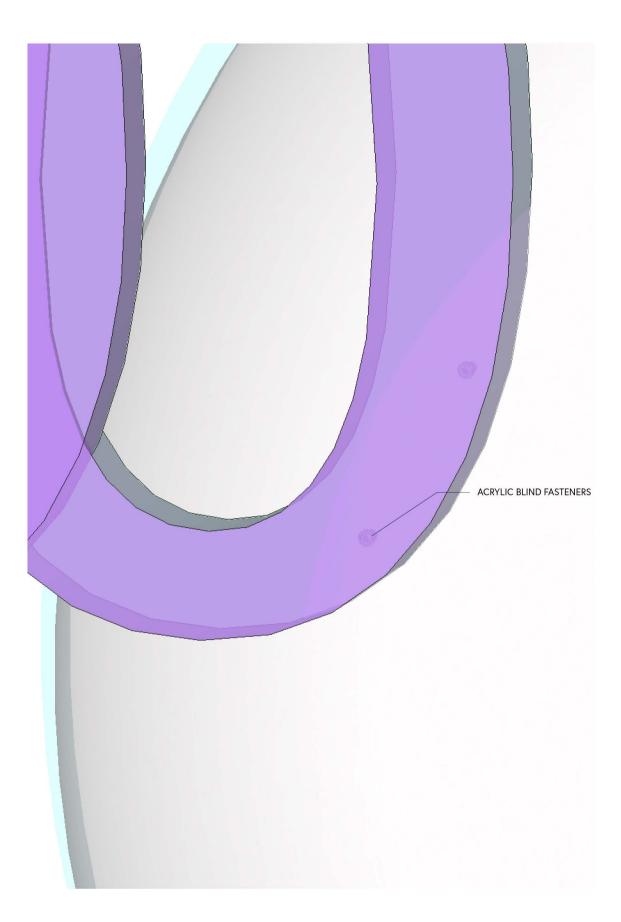
DETAIL DRAWINGS

DRAWN BY NAZ ERTUGRUL

EX606

SCALE 1/2"=1'-0"







CLIE







VENUE

MAIN VENUE: Superblue Miami, USA SATELLITE #1: Artscience Museum, Singapore SATELLITE #2: Silverstone Interactive Museum, UK SATELLITE #3: Yas Marina Circuit Racing School, UAE

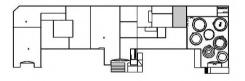
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KEY PLAN



NOTES

DETAIL DRAWINGS

DRAWN BY NAZ ERTUGRUL

EX607

SCALE MULTIPLE



LASER CUT ACRYLIC SATINICE SHEET

