



::THESIS STATEMENT

Mindfulness meditation practice heightens awareness in the present moment, deep sustained engagement, and focus, which are qualities that go ignored in today's multitasking, fast-moving world. Human perception in response to specific forms of lighting in the designed environment influences automatic physiological reactions affecting audiences' mental and physical states. Lighting effects can be employed as a gestalt in driving the design of an environment that activates mindfulness, creating enhanced well-being, and value in visitor experience in the form of positive inward and outward reflection.

Eve Frudakis

Exhibition and Experi

Exhibition and Experience Design

EXHIBITION DOCUMENTATION

Fashion Institute of Technology School of Graduate Studies 272 West 27th St. New York, NY 10011



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Key Plan:

Title:

Scale:

Drawn by: Eve Frudakis

Date: 11.03.2021

Drawing NO.

EX

::CONCEPTUAL APPROACH

An immersive journey of the innate..

experience the large and small worlds that coexist within and around you from one point. These worlds can be seen on a **planetary and atomic scale through the powers of 10.**

This experience follows the six essential elements needed to create life. These ingredients are Carbon, Hydrogen, Oxygen, Phosphorus, Sulfur.

Everything in the universe is made of atoms, every star, every tree, and every animal. Essentially we are made of elements that have come from a gigantic supernova billions of years ago— **technically our bodies contain ancient stars.**

In collaboration with the Museum of Natural History, this exhibition aims to attract and reach a younger audience by bringing "The powers of 10" conceptual framework into an experiential exhibition walk-through created for a modern audience. Primarily designed and developed for generation Z ages 18-25, anyone traveling through Times Square can escape the hectic crowds through interstitial passageways.

Once visitors see all four spaces (worlds) and mark them off on an app linked to the exhibition, they qualify to receive a free pass to AMNH.

Eve Frudakis Exhibition and Experience Design	Fashion Institute of Technology School of Graduate Studies	Project:	Client:	DISCLAIMER This is an unpublished and proprietary work simultaneously protected under copyright, trade secret, and like laws of the United States and other	Key Plan:	Title:		EX
EXHIBITION DOCUMENTATION	272 West 27th St.	CATALYST Made of Stars	AMERICAN MUSEUM 5 NATURAL HISTORY	countries. All rights reserved. These materials may not be reproduced, displayed, distributed, nor may be the information therein be used or disclosed in whole or in part, without the express written permission of Eve Frudakis.			Drawn by: Eve Frudakis Date: 11.03.2021	Drawing NO.

::CLIENT DESCRIPTION

The client for this exhibition is the American Museum Of Natural history, established in 1869.

Their mission is to "discover, interpret, and disseminate—through scientific research and education—knowledge about human cultures, the natural world, and the universe." They aim to inspire future generations.

As noted in their annual report, the museum "promotes a broader understanding of the natural world of generations to come!" Within the Hayden planetarium in the museum in the Rose Center for Earth and Space lyes a permanent exhibition dedicated to the powers of 10.



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Key

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		Date: 11 02 2021	Drawing

::SUBJECT: POWERS OF 10

"Powers of 10" is essential because not only does it recognize what we have and the things

we all know and love, but it also celebrates the unknown. It shows our human connection with nature and the mystery of the cosmos. That is—no matter how big or small the world, there is a unifying factor. Whether you are looking through a microscope or a telescope, these worlds are not as far apart as they seem.

Life is created through six essential elements: carbon, hydrogen, nitrogen, oxygen, phosphorus, and sulfur. Everyone and every living thing on our planet are united because they contain the same ingredients as the stars.

This understanding of the natural world is essential for society because it **enhances well-being** and enables people to form deeper connections and compassion for the environment that surrounds them. Having a solid well-adapted sense of our health and overall happiness is essential for growth, energy, and achievement, much like how CHNOPS elements are necessary for life and energizing the planetary and atomic worlds surrounding us.

This exhibition aims to encourage and inspire positive moments of mindfulness, inward and outward reflection for the visitor in a world where so much is happening literally in Time Square and metaphorically amidst a pandemic and politically charged world.

In 1968 "The powers of 10" film was released by Ray and Charles Eames.

Since the debut of the short film, it has been recognized as an American cultural icon and an essential tool for teaching and understanding the importance of scale. "The Powers of 10" is a magnificent wonder which combines a gamut of sciences into one beautiful visual film/book illustrating the macrocosm and microcosm of the universe as we know it.







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::AUDIENCE DESCRIPTION

Primary: 18-25

Secondary: Nearby office workers

Tertiary: Tourists & first-time city-goers in the area

Being that the AMNH takes pride in promoting understanding of the natural world for future generations this exhibition aims to target young adults in hopes that they find more of an interest in museums.

Generation Z's cohort was born between 1996 and the early-mid 2000s.

The exhibition focuses on all audience type but primarily streakers and strollers commuting through the space.

More about Gen Z

- · First digital Natives.
- · Referred to by some as the "loneliest generation," It is said they face many mental health challenges due to not only the turbulent state of the world but many hours online can lead to fostered feelings of isolation and depression. More time spent on smartphones less time cultivating meaningful relationships.
- · Politically progressive. As political activism among Gen Z has increased, many Gen Z-ers have internalized the unrest surrounding issues like gun control, police brutality, and climate change leading to increased levels of stress.
- Face an uncertain Future.
- · Members of Gen Z are more concerned about the cost of education

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::VENUE DESCRIPTION

The interstitial spaces are calm amongst the chaos of Times Square.

Through site visits and observation, there are few people pass through.

People who utilize the spaces tend to be more familiar with the area and know where they are. People appear to be on their way to work or escaping the hectic crowds. Most people use the spaces to pass through quickly and efficiently, business varies depending on the day. Some people use the areas for quiet morning commutes, and others find refuge in public seating in Nederlander alley at lunchtime.

Each interstitial space will have a different sponsor corresponding to the measurement/power the environment is based on.

All sponsors are preexisting sponsors of AMNH.

"What we can see." is Located at Shubert Alley btw 44th & 45th st. New York NY 10036

Sponsored by: Google inc.

Mission is to organize the world's information and make it universally accessible and useful.

"What is a fractal?" Is located at the Minskoof Theatre, 200W 45th st. New York, NY 10036

Sponsored by: Pfizer.

Mission is to Innovate every day to make the world a healthier place. **Paired with Sony Corporation of America.**

Missions: to fill the world with emotion, through the power of creativity and technology, and to nurture innovation to enrich and improve people's lives.

"Atomic mayhem." is located at The Marriott Marquis Parking Lot 1535 Broadway Sponsored by: **IBM Corporation.**

Mission is to lead in the creation, development, and manufacture of the industry's most advanced information technologies, including computer systems, software, networking systems, storage devices, and microelectronics.

"Cosmic Scale" Located in James M. Nederlander Alley 46th st. Side of Marriott Marquis btw Broadway & 8th Ave. 100

Sponsored by **Sony Corporation of America.**

Mission: is to fill the world with emotion, through the power of creativity and technology, and to nurture innovation to enrich and improve people's lives.

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Title:

Scale:


Drawn by: Eve Frudakis

Date: 11.03.2021

Drawing NO.

EX

::SITE MAP

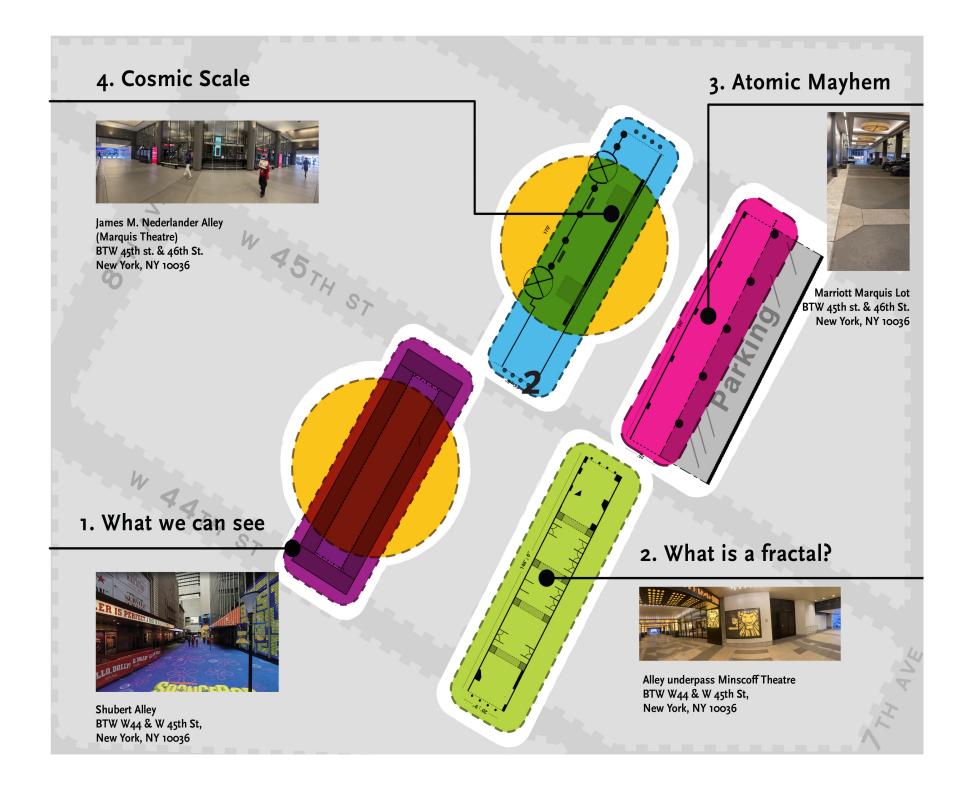

Eve	Frud	lakis
- 1 .1		

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Title:

Scale:

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Drawing NO.

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EXHIBIT GOALS

Project Goals:

- Reach and engage new audiences, primarily generation Z (young adults).
- Encourage connections, **well being**, and exploration in visitors to gain a deeper understanding of the natural world around them / us.
- · Spark imagination and curiosity through discovery.

Experience Goals:

- This Exhibition will have moments of stillness
 for viewers to have inward reflection as well as moments of
 constant movement.
- The audience will gain a **deeper understanding of scale** and recognize the vastness of our universe as well as issues we are faced at hand.
- The audience will experience meaning making.

Educational Goals:

- Visitors will learn about how we are all connected.
- Visitors will learn about the **size and scale** of things within our universe and the world.
- Visitors will learn about **powers of 10** are used as a unit to measure the super big and the super small.
- Visitors will learn about what the human eye is capable of seeing.



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::CONCEPT DIAGRAM



Producers (plants & algae) use energy from the sunlight to make food energy by combining carbon and water to create organic matter, this process begins the flow of energy through almost all food webs. Visitors will see beauty in what can be seen around them at arms reach. They will begin zooming out the visitor begins to observe satellite views.

Just like our visitor came to be at the perfect place at the perfect time, so did our Earth.

For a planet with life to form, it needs to have perfect molecular structures just the right distance from its sun. It can't be too hot or too cold. Having a water supply helps the ingredients and elements bump into each other to form compounds.

Gravity needs to be just right and, finally, a dash of lightning to catalyze a reaction necessary to form amino acids, the building blocks of life.

Content

Living ecosystems | How carbon is effecting our planet |
Showing the amount of meters AMNH spans | Davincis Human anatamy
One Planet One Future
-How we use color to measure and find stars in space.
-Controling stallite views through time (Nasa footagae)

4 quadrants: Carbon Sea Ice | Sea Level | Carbon | Global Temp.

2. What is a fractal? N H O S

From our brain to our lungs, we are fractal.

The visitor takes a look within themselves. The human body is composed of many types of fractals woven together.

Content:

10-2 Human eye | 10-3 the human brain | 10-4 singled celled algerain drop | 10-6 Blood Cells, Common Cold, Covid Vrius | 10-7 Wavelegnth visible light | 10-8 Self duplicating DNA

CNOPS

elen

3. Atomic Mayhem

When heat is added to atoms, they vibrate faster Blue=Cold Red = Hot.

Phosphorus is a vital element in metabolism to store huge amounts of energy in chemical bonds.

When the bond is broken, energy is released.

When this happens in muscle cells, for example—you move your arm or leg. Phosphorus is a catalyst.

Content

- "Energy" How humans have manipulated atoms, Atomic fusion and fission.

- 10-12 / 10-13 FOMO there are no known objects at this scale

4. Cosmic Scale

Energy powers all living things

Nearly everything eats sun - or eats something else that ate the sun.

CNHO

Dur planet's star is the major source of energy for all living things and ecosystems on our planet.

Client:

AMERICAN MUSEUM
5 NATURAL HISTORY

our bodies contain ancient stars. We are all made up of the same stuff.

The space is a sea of stars that takes you on a macrocosmic journey to the universe. Where space expands into an endless array of beauty and stillness. Everything in the universe is made of atoms, every star, every tree, every animal.

Content:

un Installation | Scales of Planets? | Trifid Nebula (Star Nursery) | Diagrams (percentage of elements). Color and gesof sta

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Key Plan:

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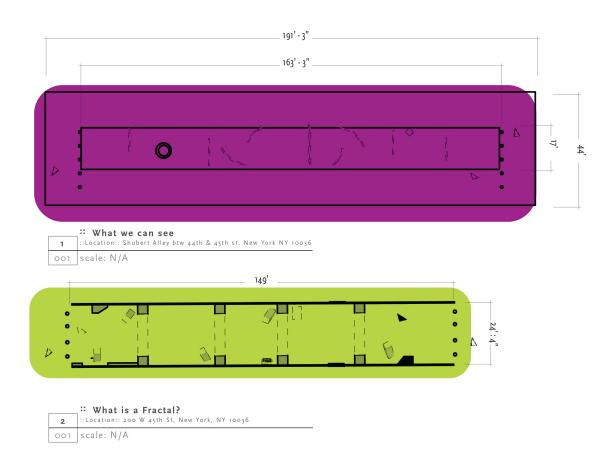
Drawn by: Eve Frudakis


Date: 11.03.2021


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::FLOOR PLAN





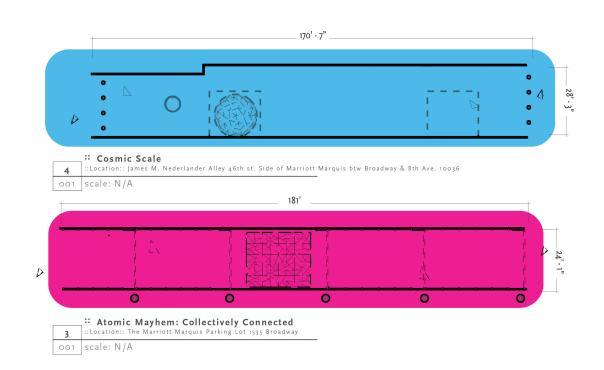

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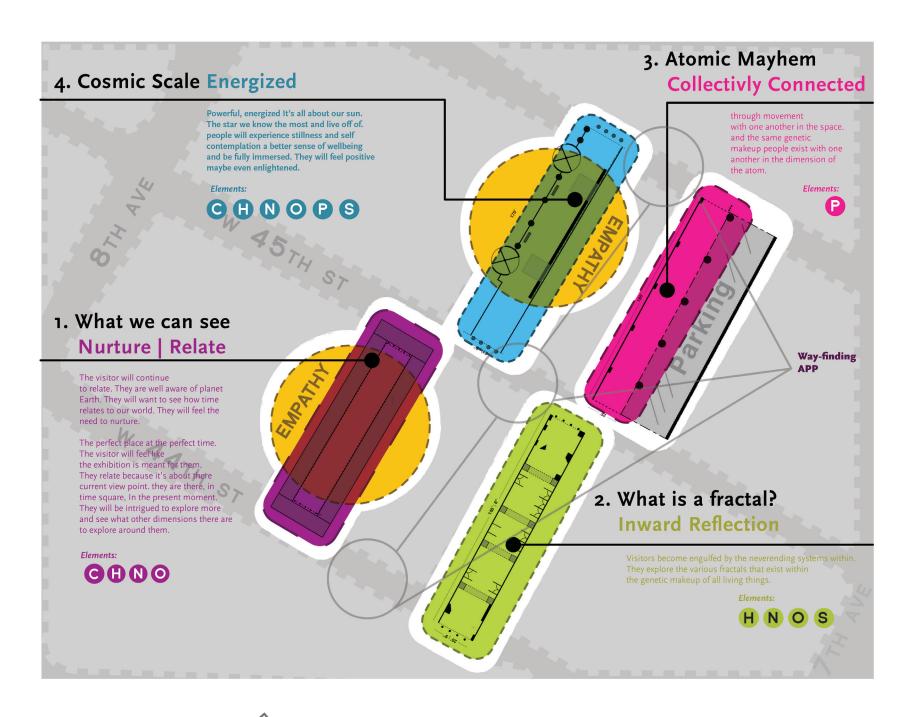
Key Plan:	Title:	Scale:
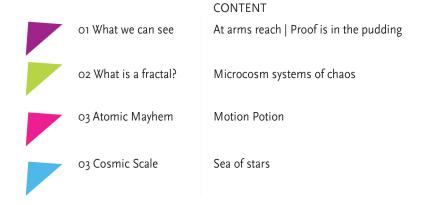
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Date: 11.03.2021

Drawing NO.

::EMOTIONAL JOURNEY MAP



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Key Plan:

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Scale:

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Date: 11.03.2021

Drawing NO.

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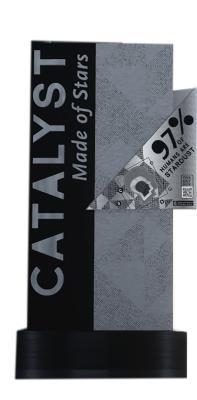
::INTRODUCTION







Proof of concept















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Key Plan:

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Title:

Scale:

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Date: 11.03.2021

Drawing NO.

EX

:: AREA O1 RENDER







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Key Plan:



Title:

What we can see

Scale: N/A

Drawn by: Eve Frudakis


112 Drawing Date: 11.03.2021 NO.


EX

:: AREA O2 RENDER





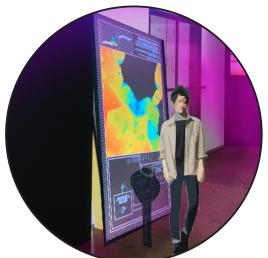

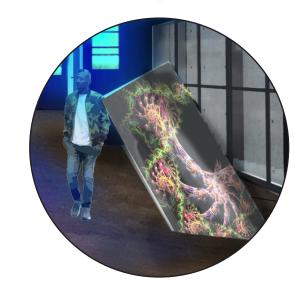

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Key Plan:

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Title: What is a fractal?

Scale:

Drawn by: Eve Frudakis Date: 11.03.2021

113 Drawing NO.

EX

:: AREA O3 RENDER





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Key Plan:

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Title: Atomic Mayhem

Scale: N/A

Drawn by: Eve Frudakis Date: 11.03.2021

Drawing

EX

:: AREA O4 RENDER







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Key Plan:



Title: Cosmic View

Scale:



Drawn by: Eve Frudakis Date: 11.03.2021

Drawing NO.

EX

:: SCHEDULES AND LISTS

∷ Graphic Location Plan

∷ Area	GR. Type	Description
What We Can See		
00A.01.GR01	Α	Infinity mirror triangular column
00A.01.GR02	В	Aluminum triangular mount w/ type
00A.02.GR01	Α	Infinity mirror triangular column
00A.02.GR02	В	Aluminum triangular mount w/ type
01A.03.GR01	С	Area intro triangular column covered w/ dichroic film placed extruded type and vinyl adhered graphic
01A.03.GR02	D	Clear acrylic panels w/ printed information
01A.04.GR01	С	Area intro triangular column covered w/ dichroic film placed extruded type and vinyl adhered graphic
01A.04.GR02	D	Clear acrylic panels w/ printed information
01A.03.GR01	F	"Look, see and here" activity box
01A.04.GR01	H	Display "Climate time machine: Sea level" sensor screen
01A.05.GR01	Н	Display "Climate time machine: Sea Ice" sensor screen
01A.06.GR01	Н	Display "Climate time machine: Global Temperature" sensor screen
01A.07.GR01	H	Display "Climate time machine: Carbon Dioxide" sensor screen
01A.01.GR01	E	Floor paint- Earth satalite view
01A.01.GR01	F	Diecut vinyl on ply- Satellite
01A.01.GR01	F	Truss covered dichroic film powers of 10 measurement frames
What is a Fractal?		
00A.01.GR01	Α	Infinity mirror triangular column
00A.01.GR02	В	Aluminum triangular mount w/ type
00A.02.GR01	Α	Infinity mirror triangular column
00A.02.GR02	В	Aluminum triangular mount w/ type
02A.03.GR01	C	Area intro triangular column covered w/ dichroic film placed extruded type and vinyl adhered graphic
02A.03.GR02	D	Clear acrylic panels w/ printed information
02A.04.GR01	С	Area intro triangular column covered w/ dichroic film placed extruded type and vinyl adhered graphic
02A.04.GR02	D	Clear acrylic panels w/ printed information
02A.05.GR01	Н	"Fractal Labs" activity
02A.06.GR01	Н	"within our blood stream" activity
02A.07.GR01	1	Powers of 10 measurement
02A.08.AV01	G	Media Cube 1
02A.09.AV02	G	Media Cube 2
02A.10.AV03	G	Media Cube 3
02A.11.AV04	G	Media Cube 4

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EXHIBITION DOCUMENTATION	272 West 27th St. New York, NY 10011	Made of Stars	5 NATURAL HISTORY	be reproduced, displayed, distributed, nor may be the information therein be used or disclosed in whole or in part, without the express written permission of Eve Frudakis.			Drawn by: Eve Frudakis Date: 11.03.2021	Drawing NO.

∷ Area	GR. Type	Description
Atomic Mayhem		
00A.01.GR01	Α	Infinity mirror triangular column
00A.01.GR02	В	Aluminum triangular mount w/ type
00A.02.GR01	Α	Infinity mirror triangular column
00A.02.GR02	В	Aluminum triangular mount w/ type
03A.03.GR01	С	Area intro triangular column covered w/ dichroic film placed extruded type and vinyl adhered graphic
03A.03.GR02	D	Clear acrylic panels w/ printed information
03A.04.GR01	С	Area intro triangular column covered w/ dichroic film placed extruded type and vinyl adhered graphic
03A.04.GR02	D	Clear acrylic panels w/ printed information
03A.04.GR01	D	Label of the nucleus
03A.04.AV01	G	Interactive wall screen 1
03A.04.AV02	G	Interactive wall screen 2
03A.04.AV03	G	Pressure sensitive flooring
03A.05.AV04	G	Projection mapping on nucleus
03A.05.GR01	F	Origami center nucleus
03A.01.GR05	G	Powers of 10 measurement frames (Lighting)
Cosmic Scale		
00A.01.GR01	Α	Infinity mirror triangular column
00A.01.GR02	В	Aluminum triangular mount w/ type
00A.02.GR01	Α	Infinity mirror triangular column
00A.02.GR02	В	Aluminum triangular mount w/ type
04A.03.GR01	С	Area intro triangular column covered w/ dichroic film placed extruded type and vinyl adhered graphic
04A.03.GR02	D	Clear acrylic panels w/ printed information
04A.04.GR01	С	Area intro triangular column covered w/ dichroic film placed extruded type and vinyl adhered graphic
04A.04.GR02	D	Clear acrylic panels w/ printed information
04A.05.GR01	F	Trifid nebula railing
04A.06.AV01	G	The sun
04A.06.AV02	G	Stars everywhere lighting
04A.03.GR02	F	Space mural painted on wall A (to be reflected w/ mirror on opposite side)

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	272 West 27th St. New York, NY 10011	Made of Stars	៉ី NATURAL HISTORY	be reproduced, displayed, distributed, nor may be the information therein be used or disclosed in whole or in part, without the express written permission of Eve Frudakis.			Drawn by: Eve Frudakis Date: 11.03.2021	Drawing NO.

:: Specification List

∷ Туре	Description
А	Fabricated Infinity mirror triangular column: (x2) 3/4" 2way mirror + (x1) 3/4" mirror w/ backer + 3/4" thick dimensional acrylic type painted black
В	1/4" think aluminum triangle mounted to triangular exhibition column column with 1/32" debossed type
С	Direct print on dichroic film, film applied to triangular exhibition column, with 1/2" thick dimensional acrylic type painted black, mounted with blind fasteners to triangular exhibition column
D	1/2" clear acrylic direct print panels mounted with blind fasteners to triangular exhibition column
Е	Exterior grade floor graphic mounted to pavement
F	Direct print to fabric, hanging via cables
G	Clear acrylic displays (wrapped in dichroic film with screen 55" XE4F-M Series High Brightness Outdoor Displays casing with Adafruit motion control sensor
Н	Stackable interactive wall screens to create wall interactive 15'x8' Planar TVF0.9 stackable by Planar with Adafruit motion control sensor
I	Pressure sensitive flooring mat, fabricator to advise

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Key Plan:	Title:
	Graphic Loc

cation Plan

Scale:		EX 202
Drawn by: Eve Frudakis		

Date: 11.03.2021

Drawing NO.

∷ Finish Schedule

MATERIAL	SYMBOL	EXHIBIT AREA	DESCRIPTION	SUPPLIER MANUFACTURER FABRICATOR	FINISH/PATTERN/COLOR
Acrylic	F1	Introduction	Infinity mirror	Canal Plastics	2 Way Mirror
	F2	Introduction	Infinity mirror	Canal Plastics	Mirrored Plexi on Backer
	F3	What We Can See	Displays in "A Changing Planet" Center Display	Canal Plastics	Clear Plexi
Aluminum	F4	What We Can See	aluminum truss wrapped in dichoric film	Cross Fire Staging Rentals	aluminum truss wrapped in dichoric film
	F17	Atomic Mayhem	aluminum frame for ceiling		Framing
	F5	Introduction	aluminum triangles		
Costum inflatable	F6	Cosmic Scale	Inflatable sphere with transparent hexagonal shape outline for "THE SUN" light ficture	Planet Inflatables fabricator to advice	inside shapes must be opaque. inflatable will be painted to look like the Sun
Wood	F7	What We Can See	used to frame activty "How We See."	La Noble	1/8" Balsa Wood painted scenic painted activity
	F8	What is A fractal?	used to frame activty "withn the bloodstream."	La Noble	1/8" Balsa Wood painted scenic painted activity
				- Ca	
Flooring	F10	Atomic Mayhem	Preassure sensitive mat		track foot prints when people step fabricator to advice
Laminates	F11	Atomic Mayhem	area sign	DICHROLAM	Iridized film
	F12	Cosmic Scale	area sign	DICHROLAM	Iridized hammered film
	F13	What Is A Fractal?	area sign	DICHROLAM	Iridized Glass monchromatic blues film
	F14	What We Can See	area sign	DICHROLAM	Multicolored Dichoric Glass Film
	F15	What We Can See	"A Changing Planet"	DICHROLAM	Multicolored Dichoric Glass Film
	F16	What We Can See	Patterned Frames	DICHROLAM	Multicolored Dichoric Glass Film
	F18	Cosmic Scale	temporary vinyl flooring	Digital Design	Costum "Cosmos" Graphics to be adhered to subfloor
			Costum printed graphics on flag banners hanging		
Fabric Paper	F19	Cosmic Scale	down inbetween comuns	Digital Design	Costum "Cosmos" graphics
	F20	Atomic Mayhem	Representon of the "nucleus"	Procédés Chénel	Drop Cieling w/ Origami Center & walls

Eve	Frud	lakis

Exhibition and Experience Design

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Key Plan:

Title: Specification List

Scale:

Drawn by: Eve Frudakis

Date: 11.03.2021

Drawing NO.

EX 203

SYMBOL	EXHIBIT AREA	DESCRIPTION	SPECIFICATION	PRODUCER		NOTES
A/V1	What We Can See	Audio "how we see" activity	Directed Audio Speaker (x2)	Panphonics		Placed in carparmet in center of box
A/V2	What We Can See	"A changing planet" sensor screen	55" XE4F-M Series High Brightness Outdoor Displays (x4)	Sony		Works withLeap Motion Controller with SDK made by Adafruit
A/V3	What We Can See		Motion Controller with SDK	Adafruit	-	x4
A/V4	What is a Fractal?	Media Cubes (5)		Fabricated byTeam Lab		
A/V5	What is a Fractal?	"Within the blood stream"	Directed Audio Speaker	Panphonics		
A/V6	What is a Fractal?	"Within the blood stream"	Freestanding Display 33"	SONY		
A/V7	What is a Fractal?	"Fractal Labs"		ArtTech House		reuse
A/V8	Atomic Mayhem	Stackable interactive wall screens to create wall	ZRD-2 Stackable tile wall by SONY	SONY		
A/V9	What We Can See	Video 1 Screen 1	Nasa Climate time machine: Sea Ice over time	Nasa Video data analysis (visitors control time w/ sensor)		
A/V10	What We Can See	Video 2 Screen 2	Nasa Climate time machine: Sea level over time	Nasa Video data analysis (visitors control time w/ sensor)		
A/V11	What We Can See	Video 3 Screen 3	Nasa Climate time machine: Carbon dioxide over time	Nasa Video data analysis (visitors control time w/ sensor)		
A/V12	What We Can See	Video 4 Screen 4	Nasa Climate time machine: Global temperature over time	Nasa Video data analysis (visitors control time w/ sensor)		

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EXHIBITION DOCUMENTATION	- 272 West 27th St. New York, NY 10011	CATALYST Made of Stars	ö NATURAL HISTORY	countries. All rights reserved. These materials may not be reproduced, displayed, distributed, nor may be the information therein be used or disclosed in whole or in part, without the express written permission of Eve Frudakis.			Drawn by: Eve Frudakis Date: 11.03.2021	Drawing NO.

:: Lighting Schedule

SYMBOL	EXHIBIT AREA	DESCRIPTION	SPECIFICATION	PRODUCER	NOTES	РНОТО	
L1	What We Can See	Up Lighting (x18)	Sun3 Round LED Recessed Uplight/steplight 47 degree angle3" round	Lightology			
L8	What We Can See	Truss lighting	VOLT® RGBW Max All- Star™ Integrated LED Spotlight (Aluminum Black)	VOLT			
L2	Atomic Mayhem	Rod LED's create (x4) frames	350cm attached with winch system made by producer in pink	Kinetic Lights	Inclued winches	i.	and stream From the stream And the stream A
L3	Cosmic Scale	Super bright daylight inside inflatable to look like the sun. Effect: daylight comes out on striking angles through hexagonal cracks		COLOR SOURCE PAR	to be mounted on circular track within the atmosphere		
L4	What is a Fractal?	Gel Film placed over preexisting light fixtures within the frames of te minskoff theatre	Rosco Gel Sheets pink to blue ombre	Rosco			
L5	What is a Fractal?	"within in the bloodstream" activity. Red slowly pulsing light timed with audio	Gantom DMX V2 DMX Controlled Spotlight	Gantom		30	
L6	Cosmic Scale	Second Ceiling Opening.	X-Effect LED projector	Rosco	(X4) Mounted in opening to face all directions NOTE* Use attached gobos #1: Star Cluster (77514) direction:CW speed: 30% #2: Blue/lave/Yellow Featherlight DirectionCCW Speed: 30%		Cales of Locar Chatter (77514) Develope (30) Cale of Z. Blacy (La/Yellow Featherfold) Speed: 300 Focus: Slight Soft Gel: Split Mist (R61) Gel: Split Mist (R61) Gel: And Clear
L8	Cosmic Scale	Reel EFX DF-50 DMX	Reel EFX DF-50 DMX DIFFUSION HAZER	Reel EFX		DEFRIEION	
L7	Atomic Mayhem	Placed on inside of origami paper on each fold on wall and ceiling to create project mapping twinkle effect	Scenex Lighting WHITE	German Light Products			

Eve Frudakis Exhibition and Experience Design	Fashion Institute of Technology School of Graduate Studies	Project:	Client:	DISCLAIMER This is an unpublished and proprietary work simultaneously protected under copyright, trade secret, and like laws of the United States and other	Key Plan:	Title: Area Introduction		EX 205
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SYMBOL	ARTIFACT	EXHIBIT AREA	DESCRIPTION	РНОТО
A1	Ecosphere	What We Can See	The Ecosphere, or self-sustaining habitat, explores conditions necessary to sustain life. Algae capture energy from sunlight and, in turn, are eaten by shrimp. The waste from the shrimp then fertilizes the algae.	
A2	"Antarctic & Southern Elephant Skulls" Large photo	What We Can See Display 1	Photo caption "In 2018, antarctic has again shrunk to it's lowest level on record. By 2100 global sea level rise could turn hundreds of millions of humans into climate refugees."	
A3	"Disposable sunset" Large photo	What We Can See Display 2	Photo caption: "It's estimated by 2050 there will be more plastic than fish in the oceans."	
A4	"Constellation 1" Large photo	What We Can See Display 3	Photo caption: "Ocean acidification due to global warming could destroy 90% of Earths coral reefs by 2050"	D
A5	"Snow leopard 1"	What We Can See Display 4	Photo caption: "There are less than 4000 snow leopards left on the planet as climate change continues to reduce their haitate. their only preditor is man.	
A6	The Brain fractal 10 -1	What is a fractal? Media cube 1	Brain Fractal	
A7	Human eye fractal 10 -2	What is a fractal? Media cube 2	Eye Fractal	2
A8	Wave legnths of visible light 10 -7	What is a fractal? Media cube 3	The human eye sees only visible light. all the colors of the rainbow are produced by light w/ wavelengths between 400 and 70000 nanometeres	
A9	Blood stream image 10- 6 to -8	What is a fractal?	"within the bloodstream" activity	
A10	DNA fract 10 -9	What is a fractal? Media cube 4	dna fractal	
A11	Trifid Nebula	Cosmic Scale		

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Key Plan:	Title:
	Area Introduction

n	Scale:	EX 206
	Drawn by: Eve Frudakis	
	Date: 11 02 2021	Drawin

:: PLANS AND SECTIONS

::LOCATION PLAN





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Title: Location Plan

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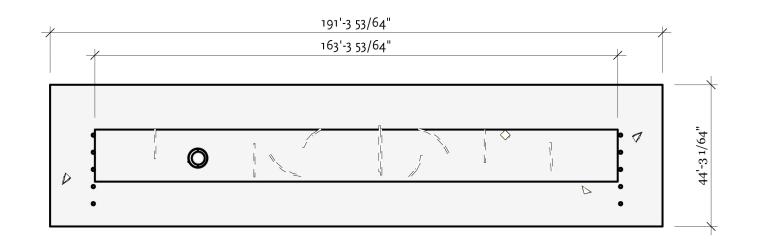
Drawn by: Eve Frudakis

Date: 11.03.2021


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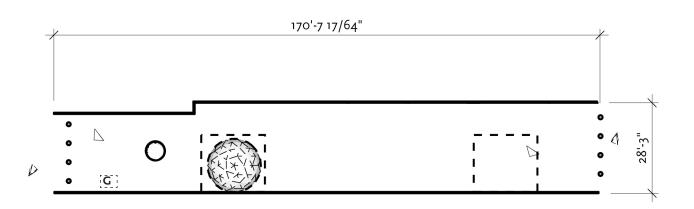
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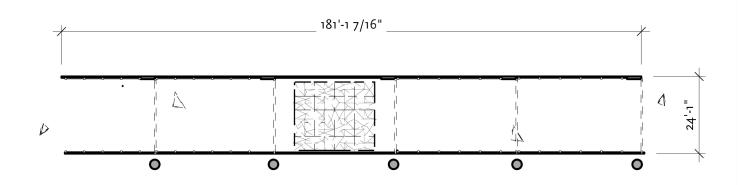
 What We Can See O1A ::Location:: Shubert Alley btw 44th & 45th st. New York NY 10036 scale: N/A



 What is a Fractal? O2A ::Location:: 200 W 45th St, New York, NY 10036 Minscoff Theatre underpass scale: N/A



 What is a Fractal? O4A ::Location:: 200 W 45th St, New York, NY 10036 Minscoff Theatre underpass scale: N/A

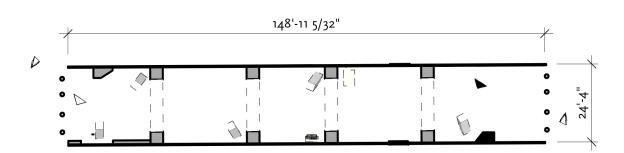

:: Cosmic Scale 03A ::Location:: James M. Nederlander Alley 46th st. Side of Marriott Marquis btw Broadway & 8th Ave. 10036

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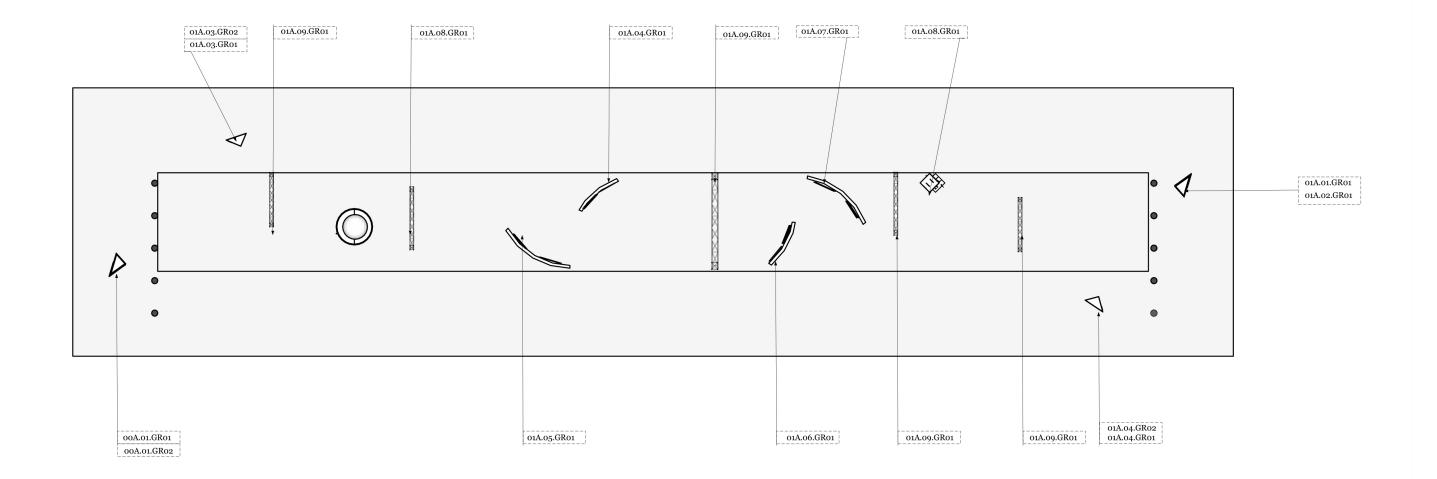
Title: Site Plan

Scale: N/S

1 EX 301

Drawn by: Eve Frudakis Date: 11.03.2021

Drawing



:: Graphic Location Plan
::Location:: Shubert Alley btw 44th & 45th st. New York NY 10036

scale: 1/16 = 1'

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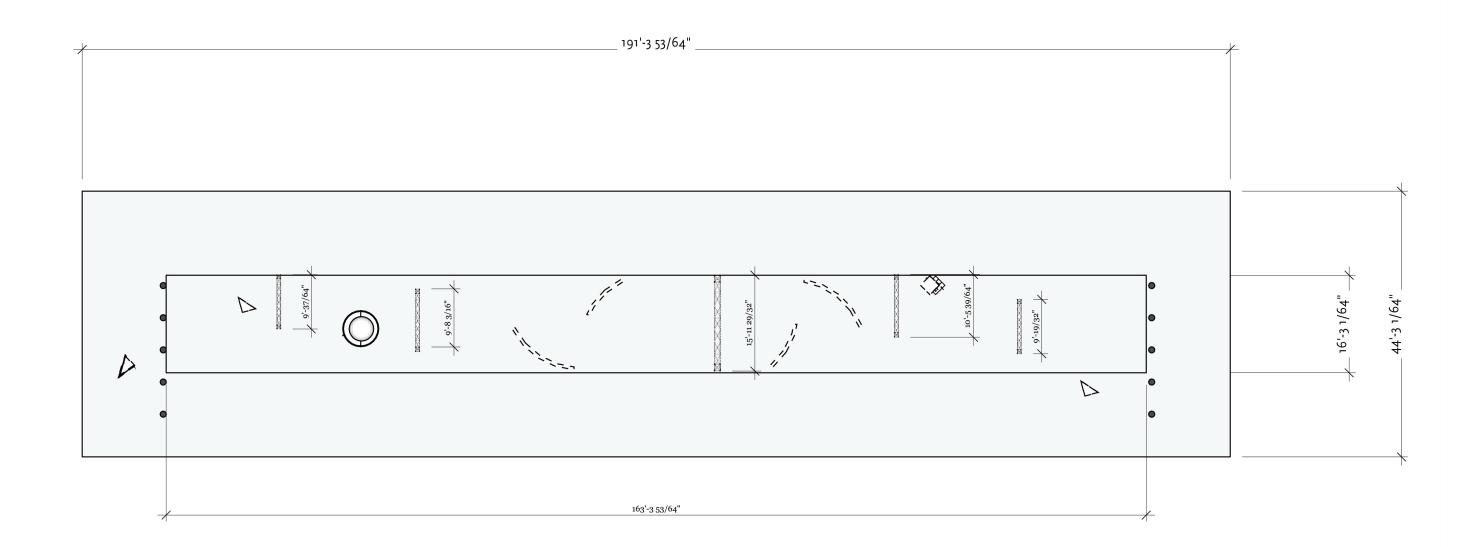
Graphic Location Plan

Scale: 1/16 " = 1'

EX 1 Drawn by: Eve Frudakis

Date: 11.03.2021

Drawing



∷ Dimension Area 01 **A** :Location:: Shubert Alley btw 44th & 45th st. New York NY 10036 scale: 1/16 = 1'

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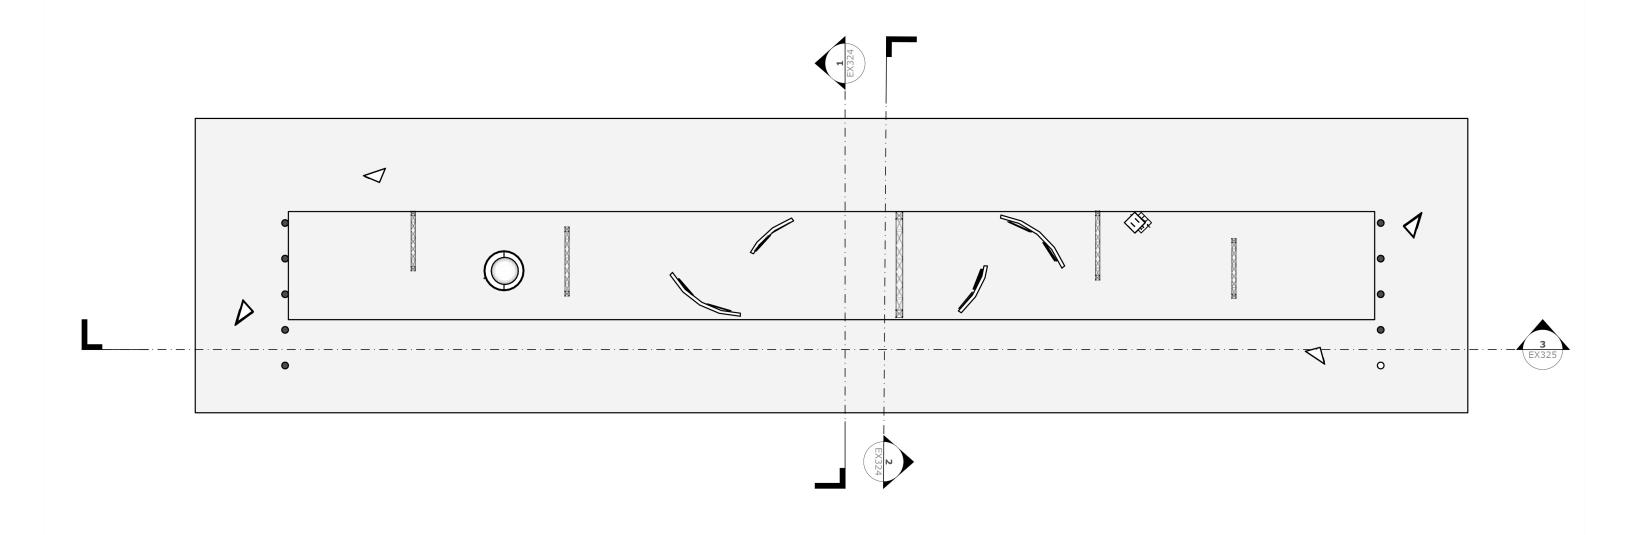
Dimension Area 01A

Scale: 1/16 = 1'

Drawn by: Eve Frudakis Date: 11.03.2021

Drawing

EX



::Location:: Shubert Alley btw 44th & 45th st. New York NY 10036 scale: 1/16 = 1

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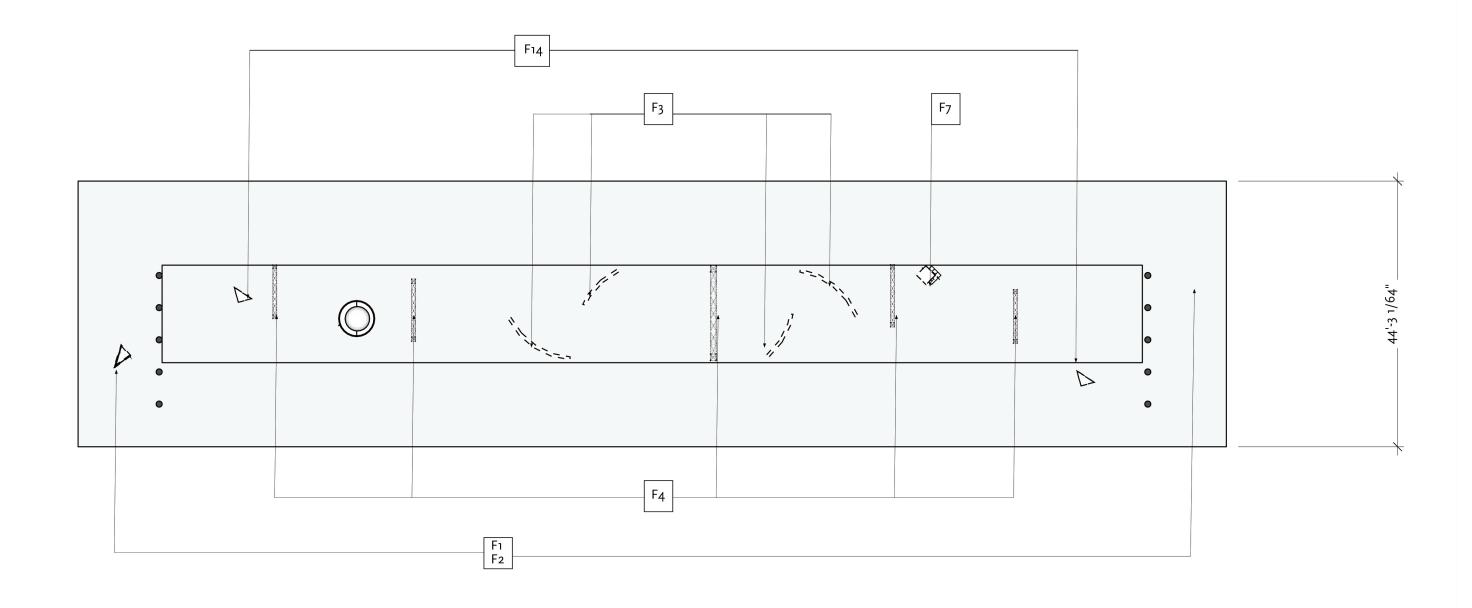


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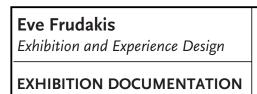
EX 1 304

Drawn by: Eve Frudakis Date: 11.03.2021

Drawing NO.



∴ Finish Plan Area 01 A ::Location:: Shubert Alley btw 44th & 45th st. New York NY 10036



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Title: Finish Plan 01A

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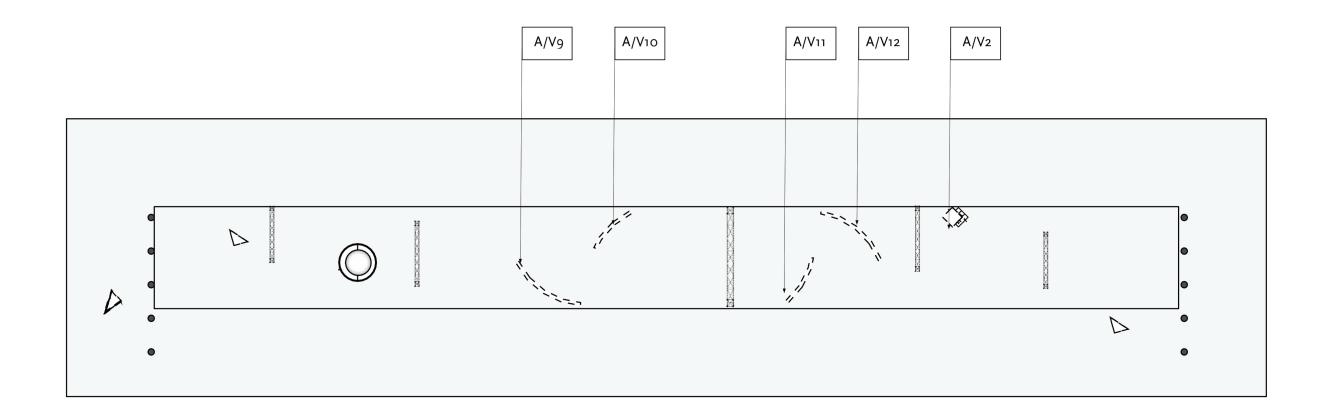
Drawn by: Eve Frudakis

Date: 11.03.2021

Drawing

EX

305



∷ Media Plan Area 01 A

::Location:: Shubert Alley btw 44th & 45th st. New York NY 10036

scale: 1/16 = 1'

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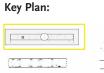
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Title: Media Plan 01A

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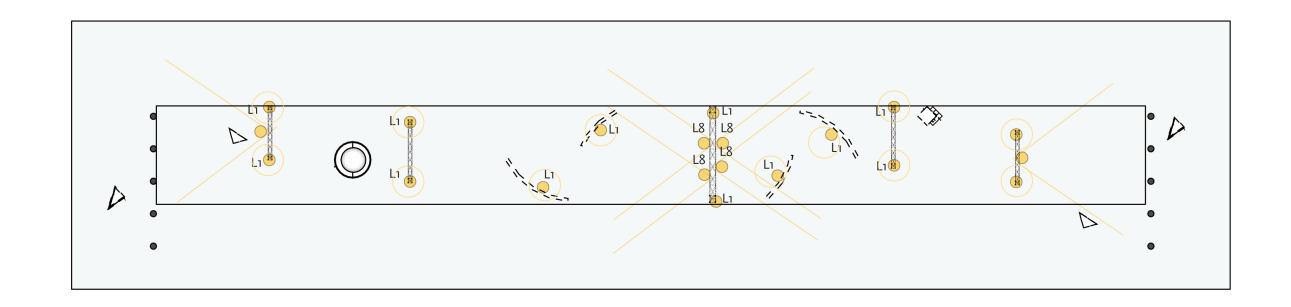
EX

306

Drawing

Drawn by: Eve Frudakis

Date: 11.03.2021



RCP Area o1 A ::Location:: Shubert Alley btw 44th & 45th st. New York NY 10036

scale: 1/16 = 1'

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Title: RCP 01A


Scale: 1/16 = 1'

Drawn by: Eve Frudakis

Date: 11.03.2021

Drawing

EX

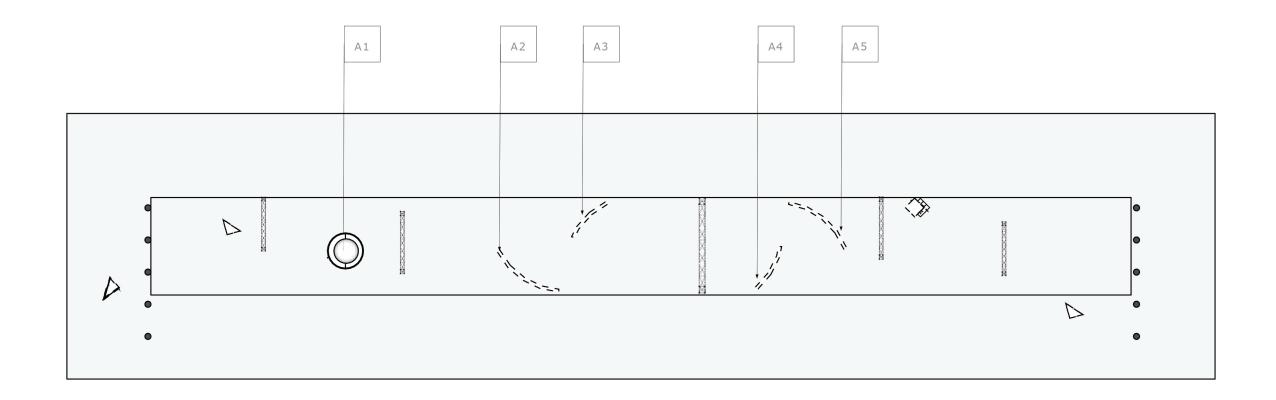



::Location:: Shubert Alley btw 44th & 45th st. New York NY 10036

scale: 1/16 = 1

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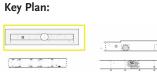
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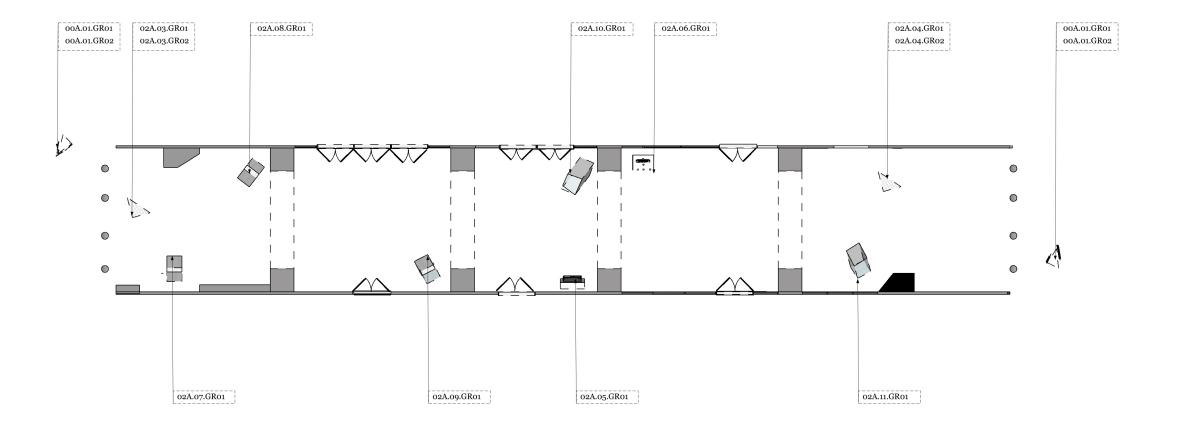
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EX 308 Drawn by: Eve Frudakis

Date: 11.03.2021

Drawing NO.



∷ Graphic Location Plan O2A ::Location:: 200 W 45th St, New York, NY 10036 Minscoff Theatre underpass scale: 1/16 = 1

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Graphic Location Plan


Scale: 1/16" = 1'

1 Drawn by: Eve Frudakis

Date: 11.03.2021

Drawing NO.

EX

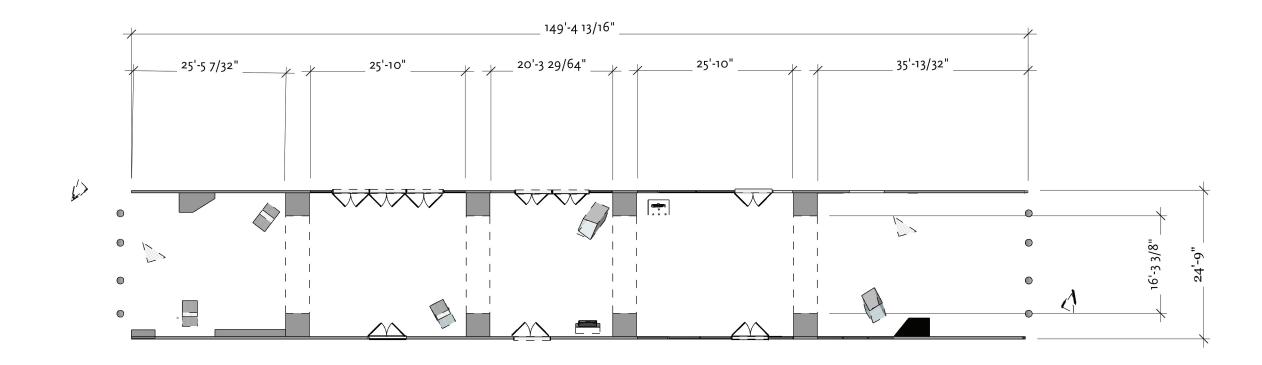

:: Dimension Area 02 A

::Location:: 200 W 45th St, New York, NY 10036 Minscoff Theatre underpass

scale: 1/16 = 1'

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Title: Dimensions Area 02A

a o2A | Scale: 1/16 = 1'


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Drawn by: Eve Frudakis

Date: 11.03.2021

Drawing NO.


EX

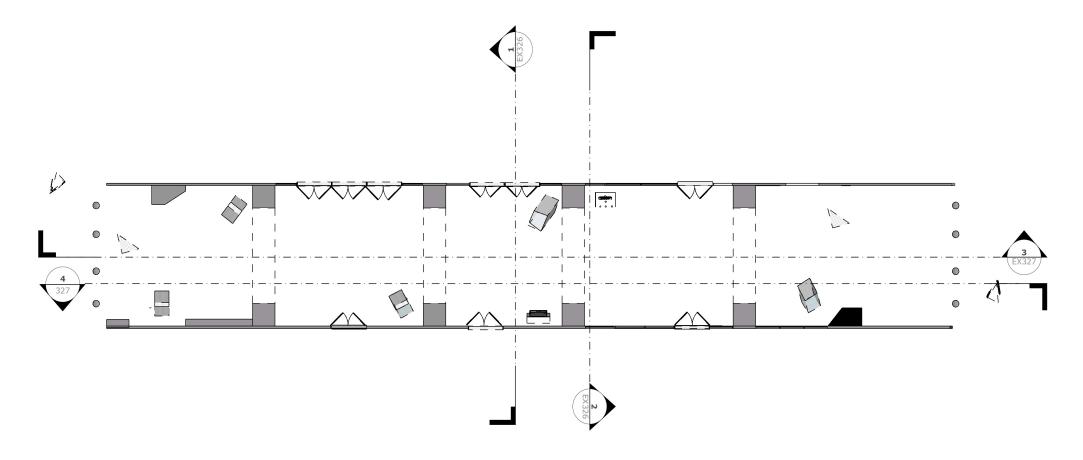

:: Coded Floor Plan Area 02A ::Location:: 200 W 45th St, New York, NY 10036 Minscoff Theatre underpass scale: 1/16 = 1'



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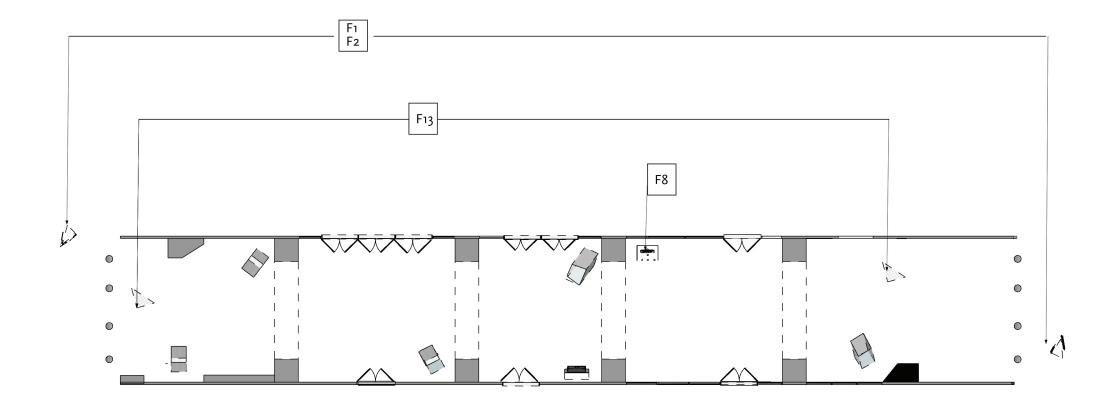
Title: Coded Floor Plan

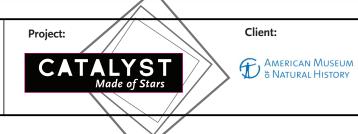Scale: 1/16 = 1'

1 Drawn by: Eve Frudakis

Date: 11.03.2021

Drawing NO.



:: Finish Plan Area 02 A
::Location:: 200 W 45th St, New York, NY 10036 Minscoff Theatre underpass

scale: 1/16 = 1'

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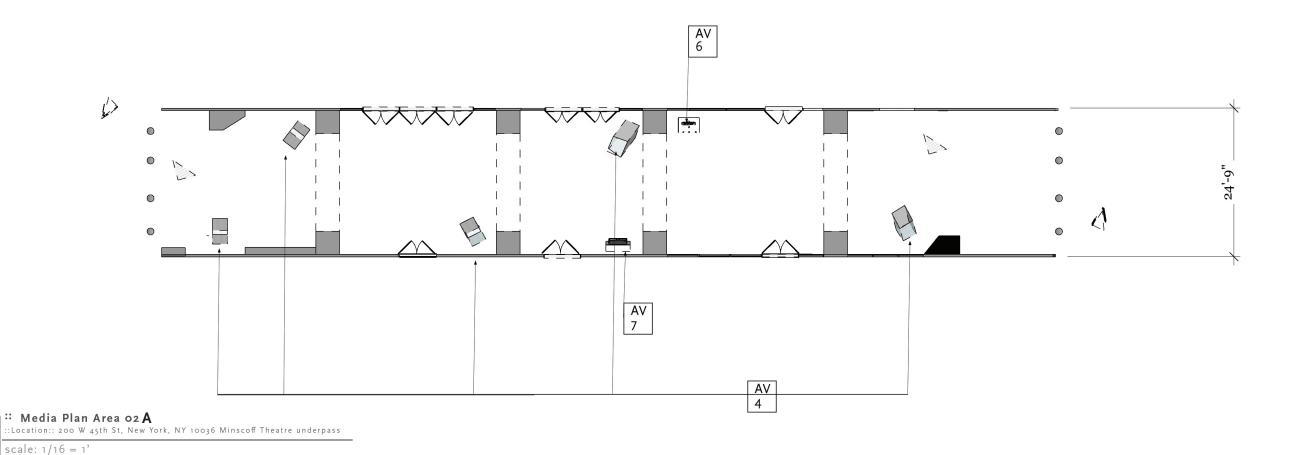


Finish Plan Area 02A

Scale: 1/16 = 1'

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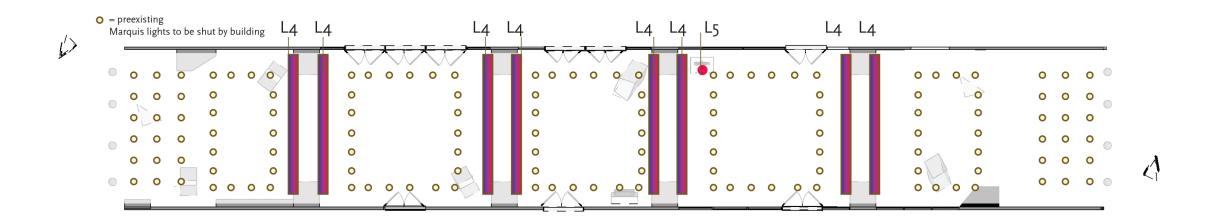
Title: Media Plan Area 02A

Scale: 1/16 = 1'

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Drawn by: Eve Frudakis Date: 11.03.2021

Drawing NO.



∷ RCP Area o2A

:Location:: 200 W 45th St, New York, NY 10036 Minscoff Theatre underpass




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Title: RCP 02A

Scale: 1/16 = 1

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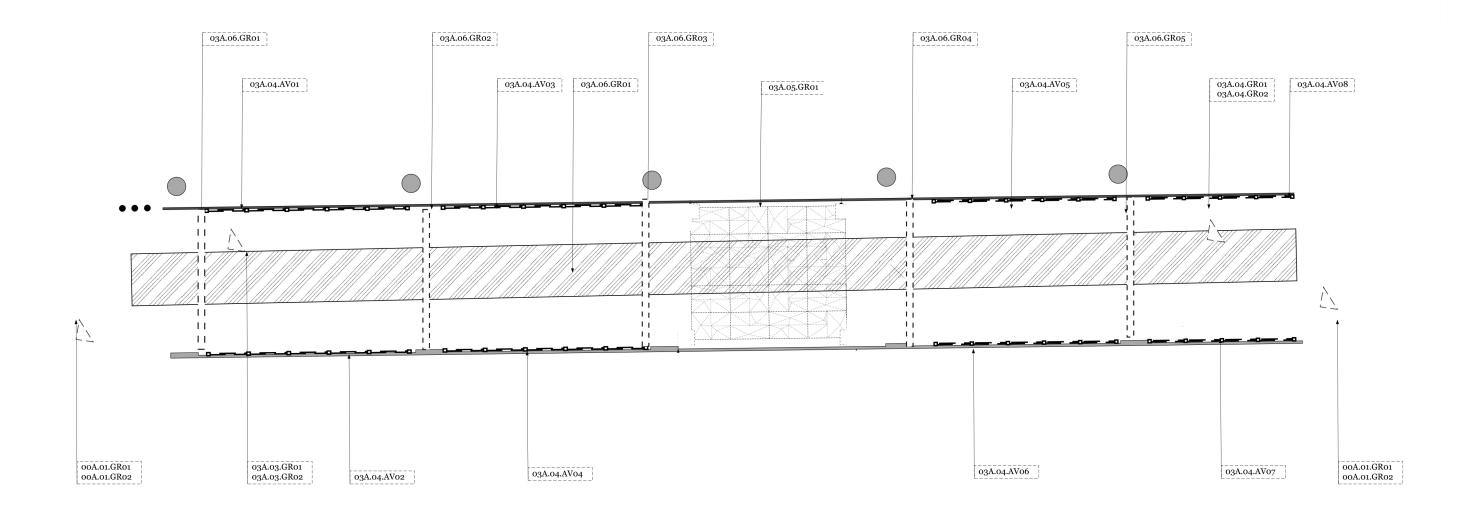
Drawn by: Eve Frudakis

Drawing NO.

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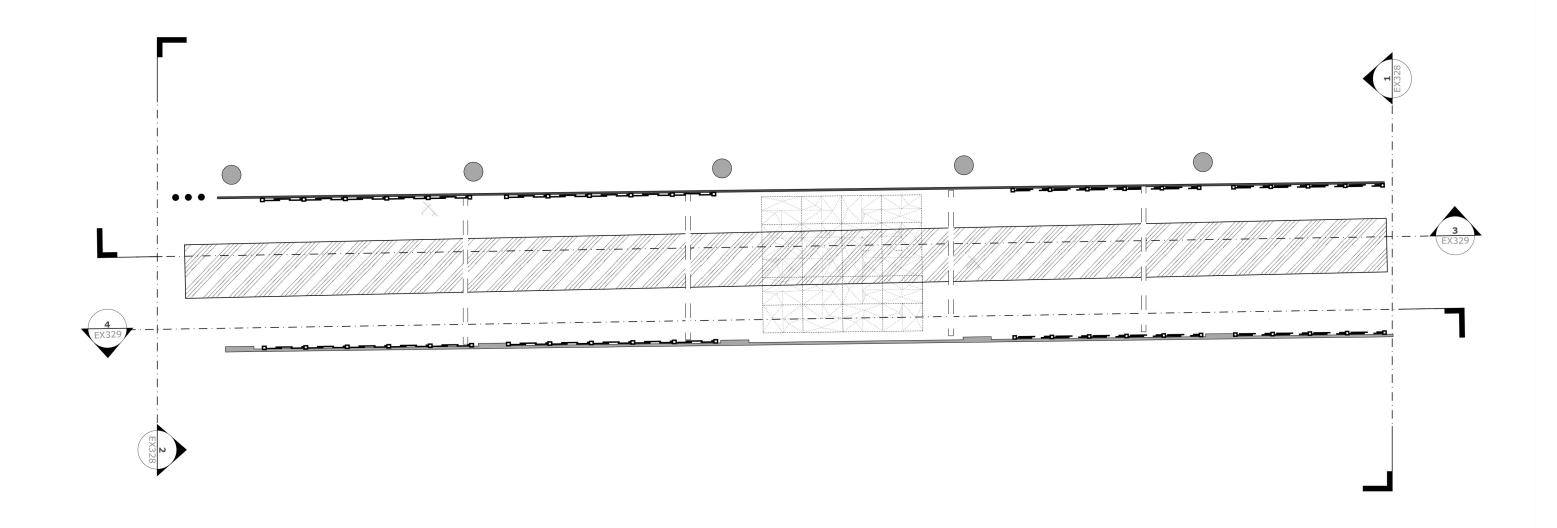
314

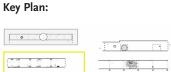Date: 11.03.2021



Graphic Location Plan **03A**::Location:: The Marriott Marquis Parking Lot 1535 Broadway





Coded Floor Plan Area o3 A
::Location:: The Marriott Marquis Parking Lot 1535 Broadway

scale: 1/16 = 1'

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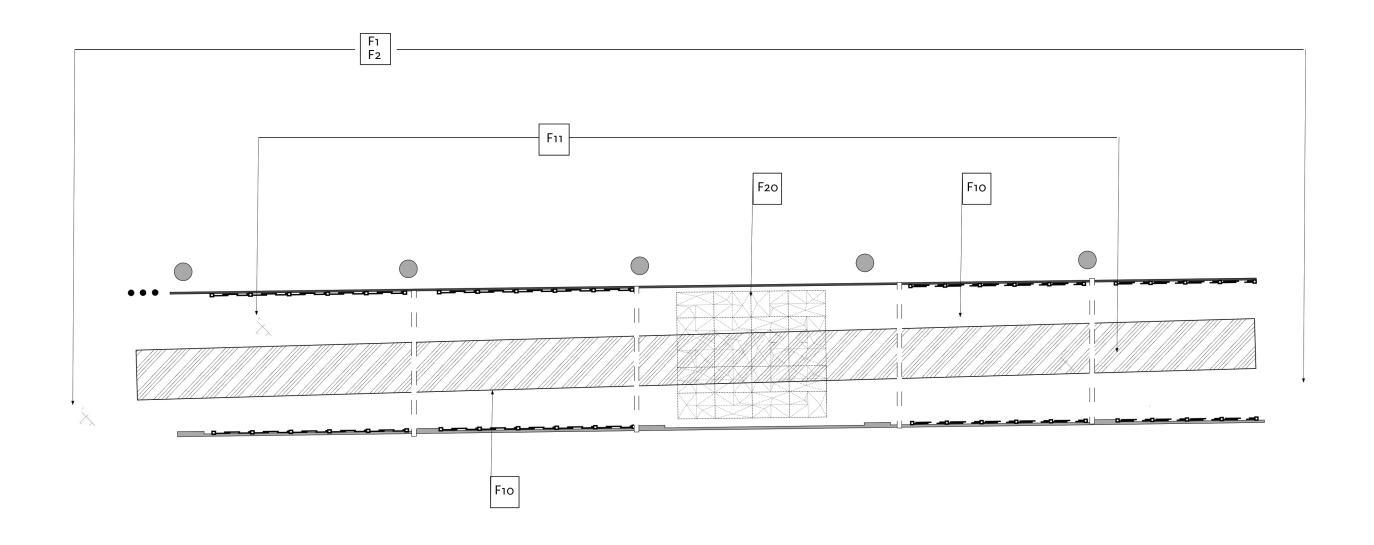
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Title: Coded Floor Plan 03A

Scale: 1/16 = 1'

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Key Plan:

. 60

Title: Finish Plan 03A

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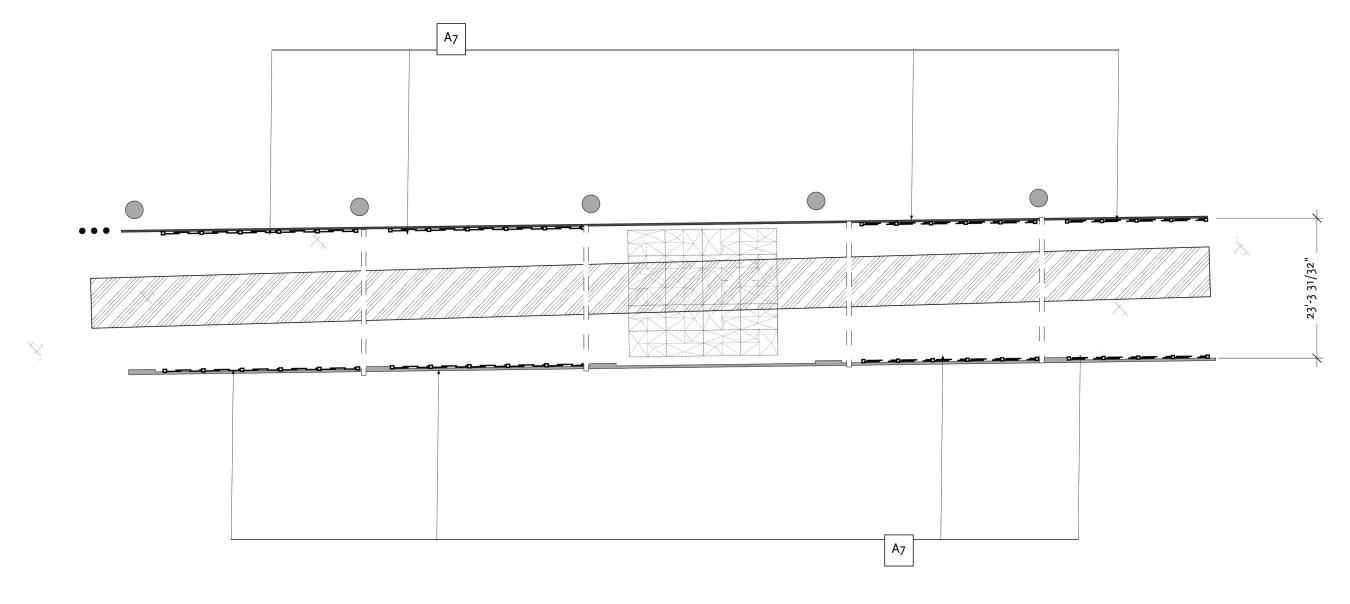
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EX

Drawn by: Eve Frudakis Date: 11.03.2021

Drawing

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∷ Media Plan Area o3 A ::Location:: The Marriott Marquis Parking Lot 1535 Broadway scale: 1/16 = 1'

Eve Frudakis

Exhibition and Experience Design

EXHIBITION DOCUMENTATION

Fashion Institute of Technology School of Graduate Studies 272 West 27th St. New York, NY 10011



Client:

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Key Plan:

Title: Media Plan 03A


Scale:

1/16 = 1'

Drawn by: Eve Frudakis Date: 11.03.2021

Drawing

EX 318

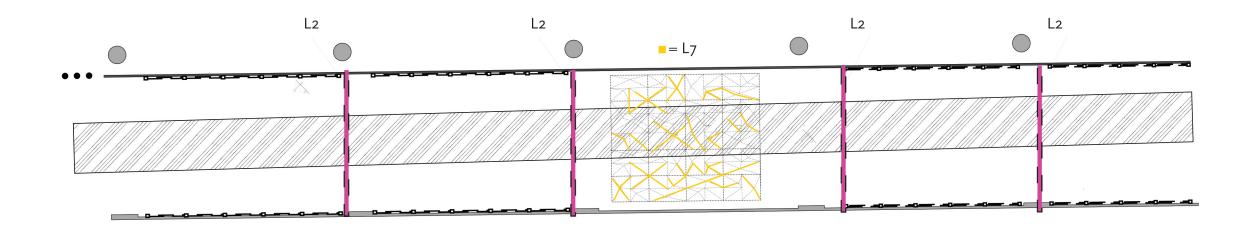


scale: 1/16 = 1'

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Key Plan: . 60


Title: RCP 03A

Scale: 1/1<u>1</u>264= 1'

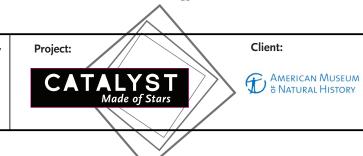1 Drawn by: Eve Frudakis

Date: 11.03.2021

Drawing NO.

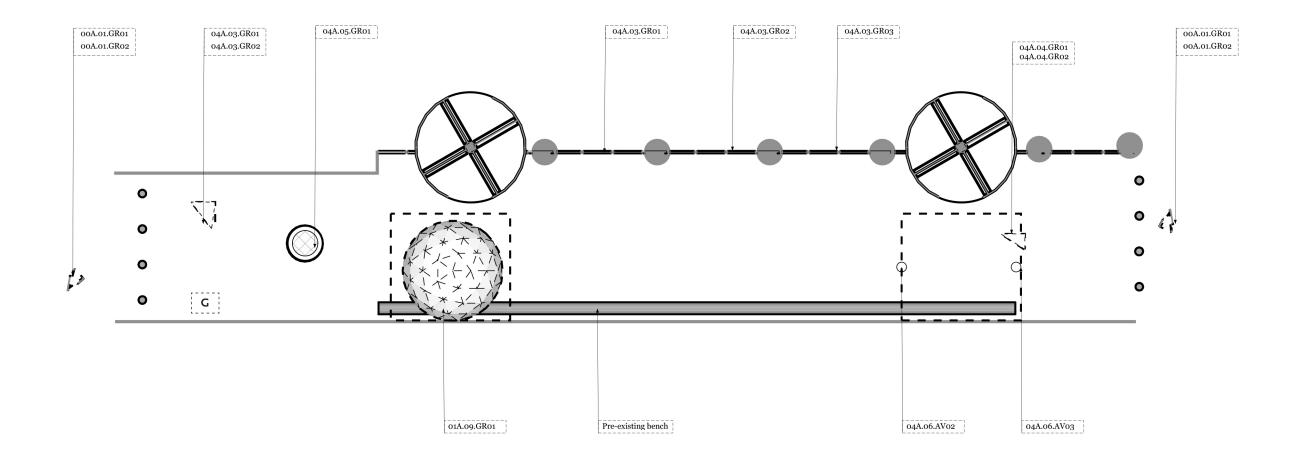

:: Graphic Location Plan 04A ::Location:: James M. Nederlander Alley 46th st. Side of Marriott Marquis btw Broadway & 8th Ave. 10036

scale: 1/16 = 1

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Key Plan:


Title: Graphic Location Plan 04A

Scale: 1/16" = 1'

Drawn by: Eve Frudakis

Drawing Date: 11.03.2021 NO.

EX

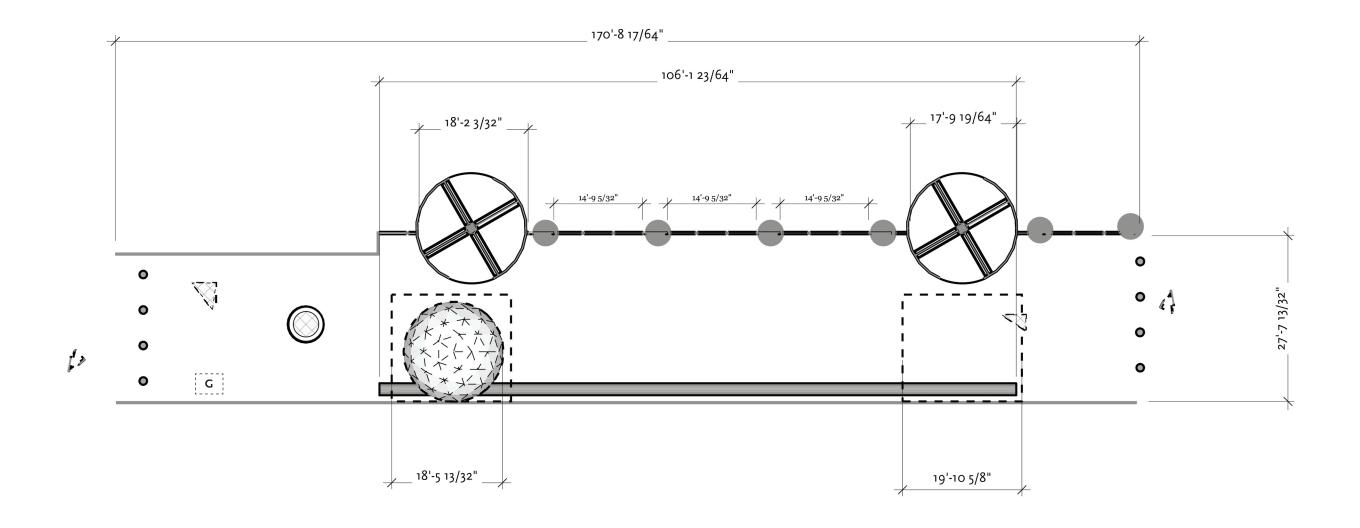

: Dimension Plan Area 04 A :Location:: James M. Nederlander Alley 46th st. Side of Marriott Marquis btw Broadway & 8th Ave. 10036

scale: 1/16 = 1'

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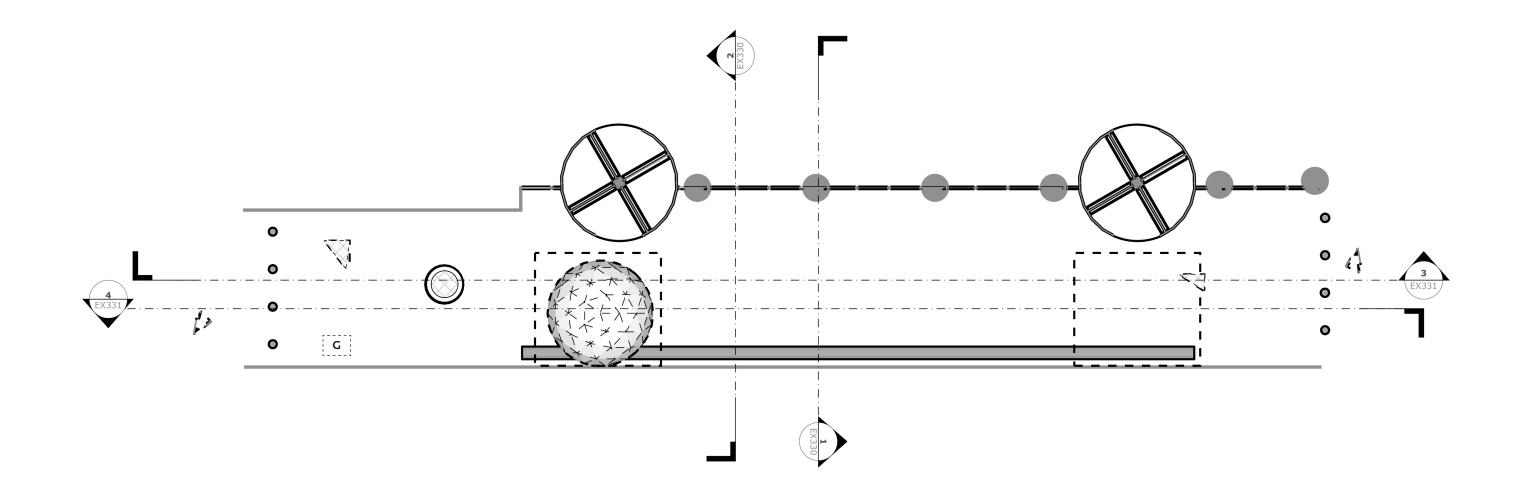
Title: Dimension Plan Area 04

Scale: 1/16 = 1'

1 Drawn by: Eve Frudakis

Date: 11.03.2021

Drawing NO.



:: Coded Floor Plan Area 04 A ::Location:: James M. Nederlander Alley 46th st. Side of Marriott Marquis btw Broadway & 8th Ave. 10036

scale: 1/16 = 1'

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Key Plan:


Title: Coded Floor Plan Area 04A

Scale: 1/16 = 1'

1 Drawn by: Eve Frudakis Date: 11.03.2021

Drawing NO.

EX

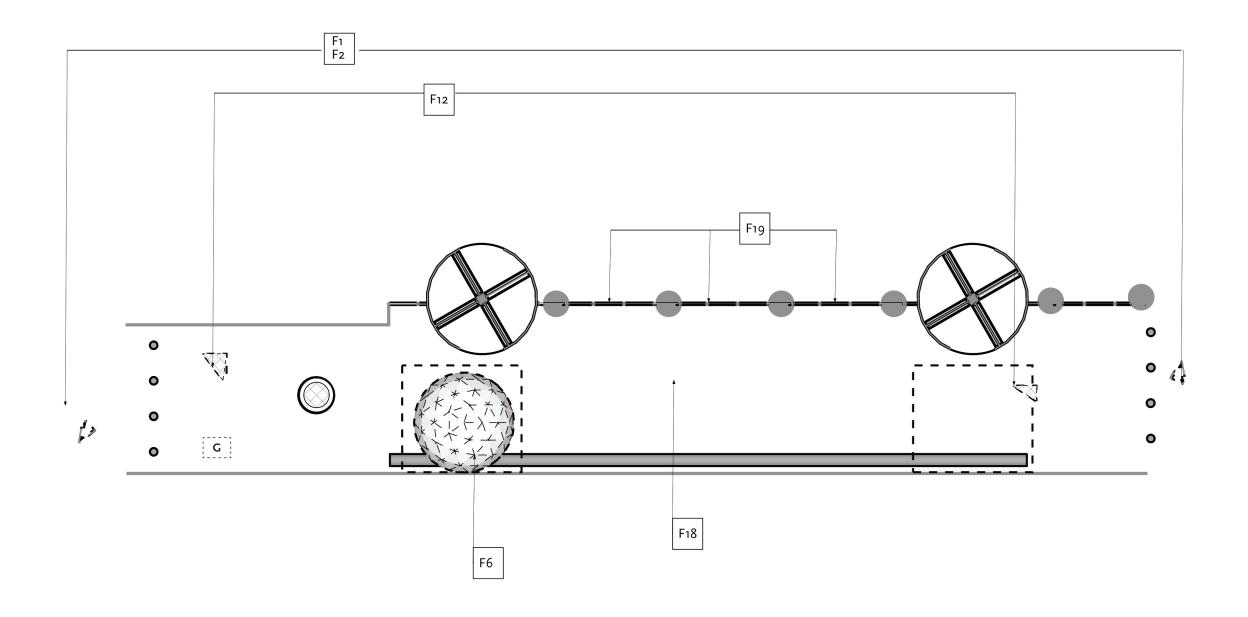

∷ Finish Plan Area 04A

Location:: James M. Nederlander Alley 46th st. Side of Marriott Marquis btw Broadway & 8th Ave. 10036

scale: 1/16 = 1'

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Title: Finish Plan Area 04A


Scale: 1/16 = 1'

Drawn by: Eve Frudakis

Date: 11.03.2021

Drawing NO.

EX

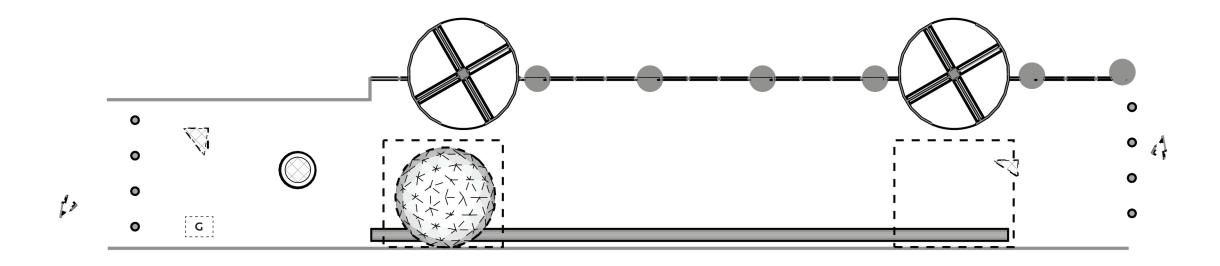

scale: 1/16 = 1

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Title: Media Plan 04A

Scale: 1/16 =1'


1

EX 324

Drawn by: Eve Frudakis

Drawing Date: 11.03.2021

=preexisting light
** Marquis lights to be shut by building

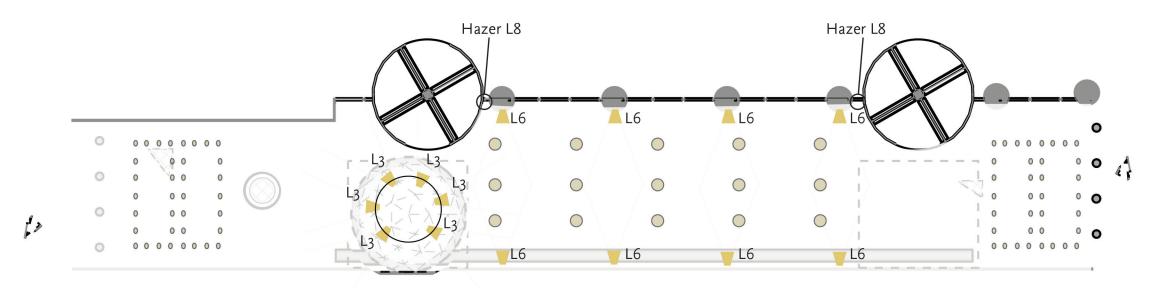

RCP Area 04
::Location:: James M. Nederlander Alley 46th st. Side of Marriott Marquis btw Broadway & 8th Ave. 10036

scale: 1/16 = 1'

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Title: RCP 04A


Scale: 1/16 = 1'

1'

Drawn by: Eve Frudakis

Date: 11.03.2021

Drawing
NO.

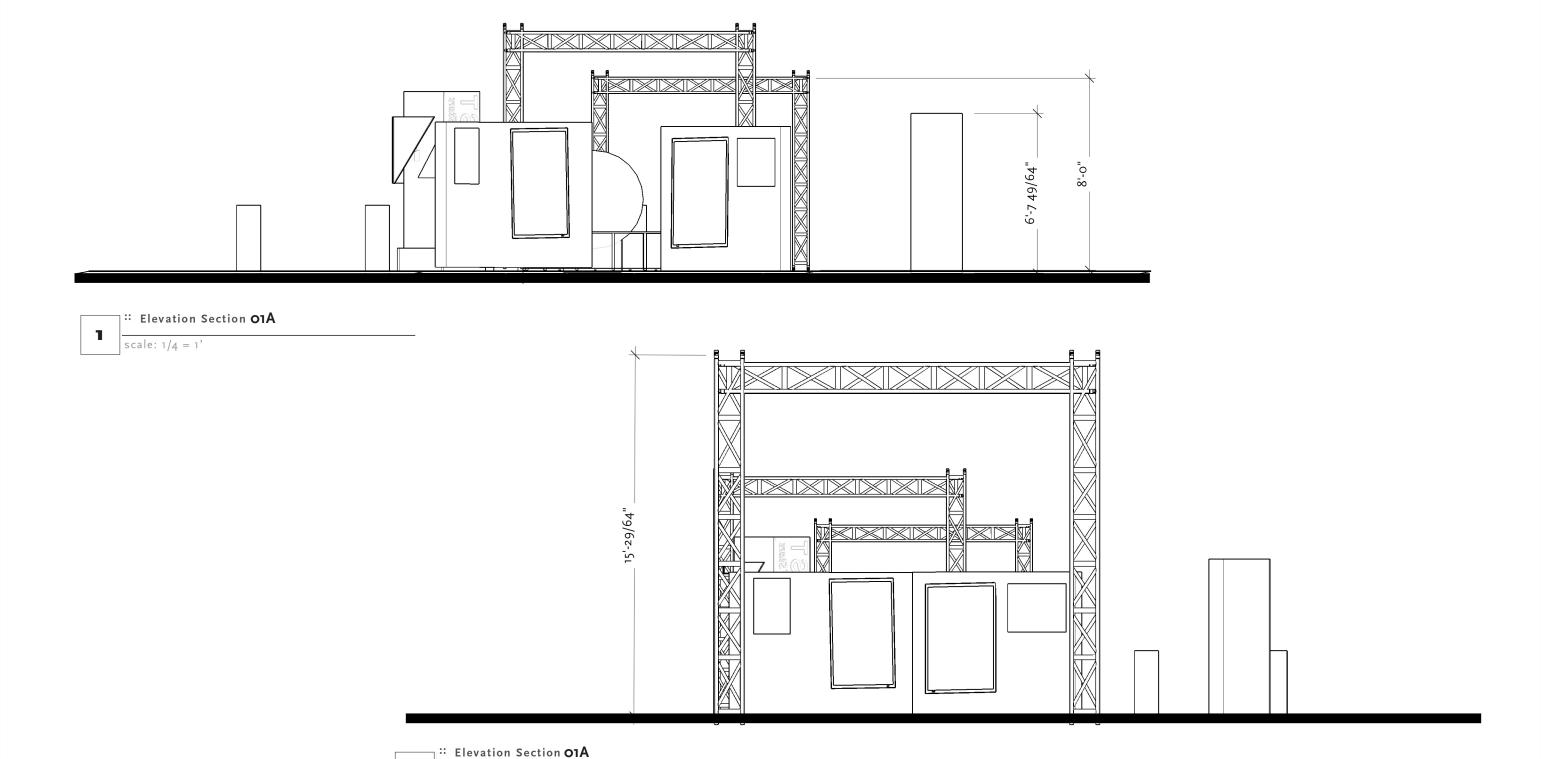



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scale: 1/4 = 1

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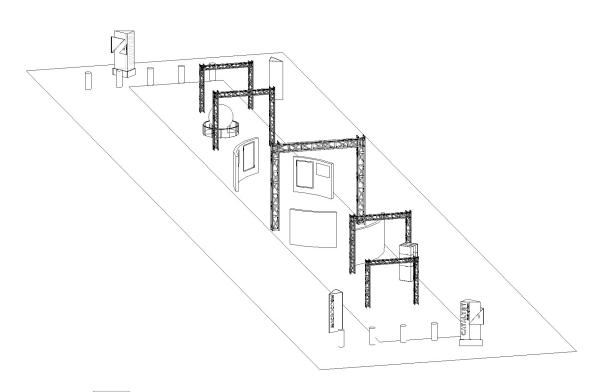
o1A Sections 1 and 2

Scale: 1/4" =1'

Drawn by: Eve Frudakis


Date: 11.03.2021

Drawing NO.



o1A :: AXO View Reference

o scale: N/A

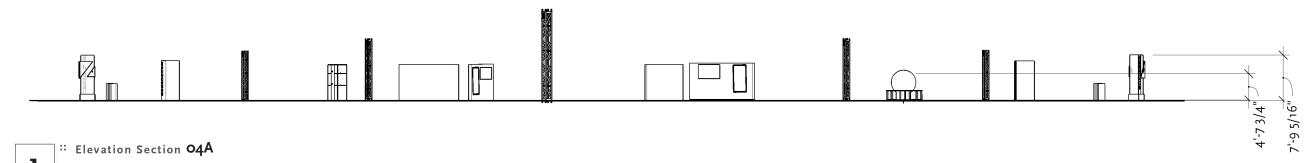

scale: 1/16 = 1

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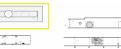


Client:



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Title:

Scale: Area 01A Section 3 1/16" = 1'


Drawn by: Eve Frudakis


Drawing NO.

1

EX

Date: 11.03.2021

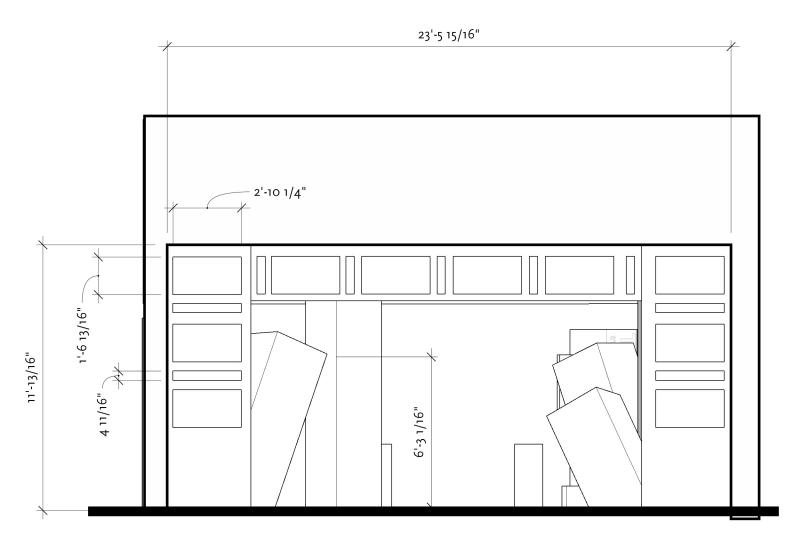

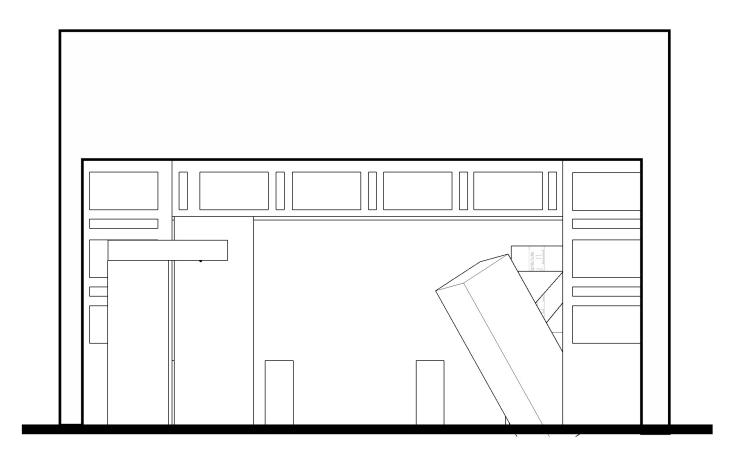

 $\frac{\text{:: Elevation Section O2A}}{\text{scale: } 1/4 = 1'}$

Elevation Section 02A

scale: 1/4 = 1'




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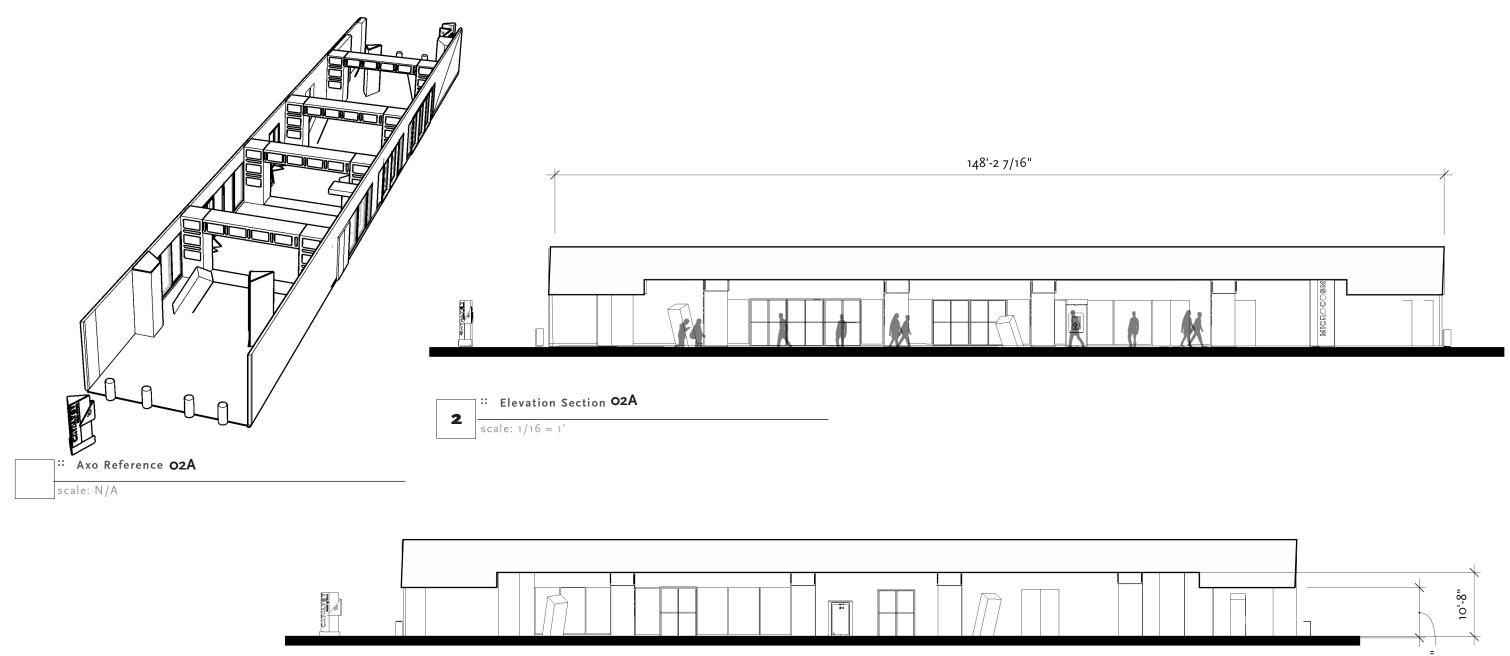
Title: 02A Section 1 and 2


Scale: 1/4" = 1'

Drawn by: Eve Frudakis

Date: 11.03.2021

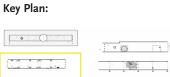Drawing
NO.



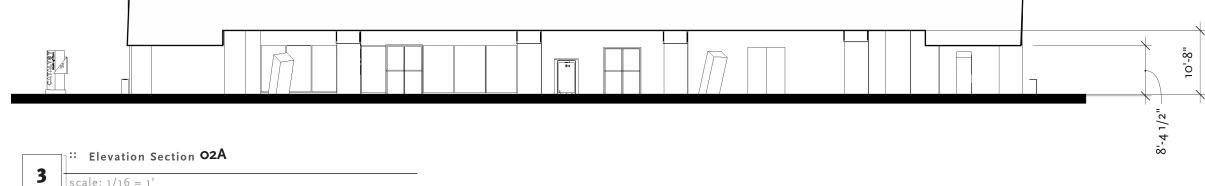

scale: 1/16 = 1'

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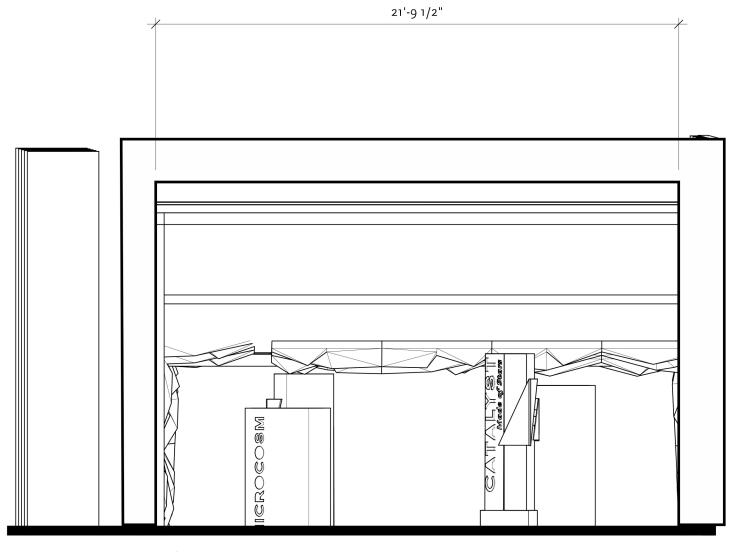
Title: 02A Sections 3 and 4

Scale: 1/16 = 1'

1

Drawn by: Eve Frudakis

Drawing Date: 11.03.2021 NO.



MICHOCOSM 6'-1 3/8"

∷ Elevation Section O3A

scale: 1/4 = 1'

 ∷ Elevation Section O3A 1 scale: 1/4 = 1'

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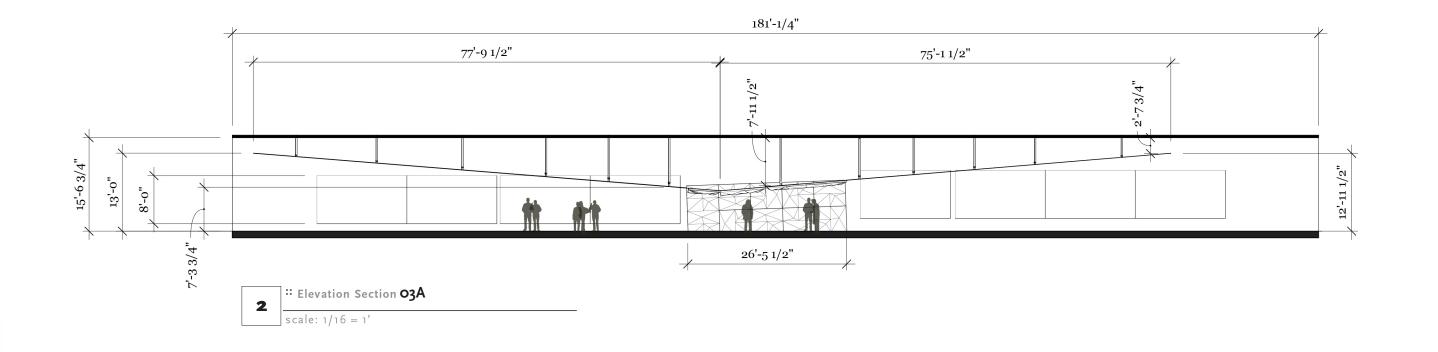
Title: 03A Sections 1 and 2


Scale:

1/4 = 1'

1 EX 330 Drawn by: Eve Frudakis Date: 11.03.2021

Drawing NO.



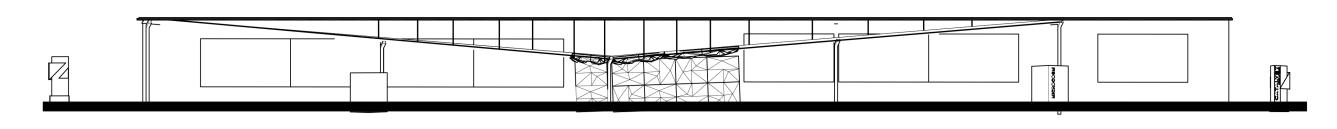

:: Elevation Section 03A scale: 1/16 = 1

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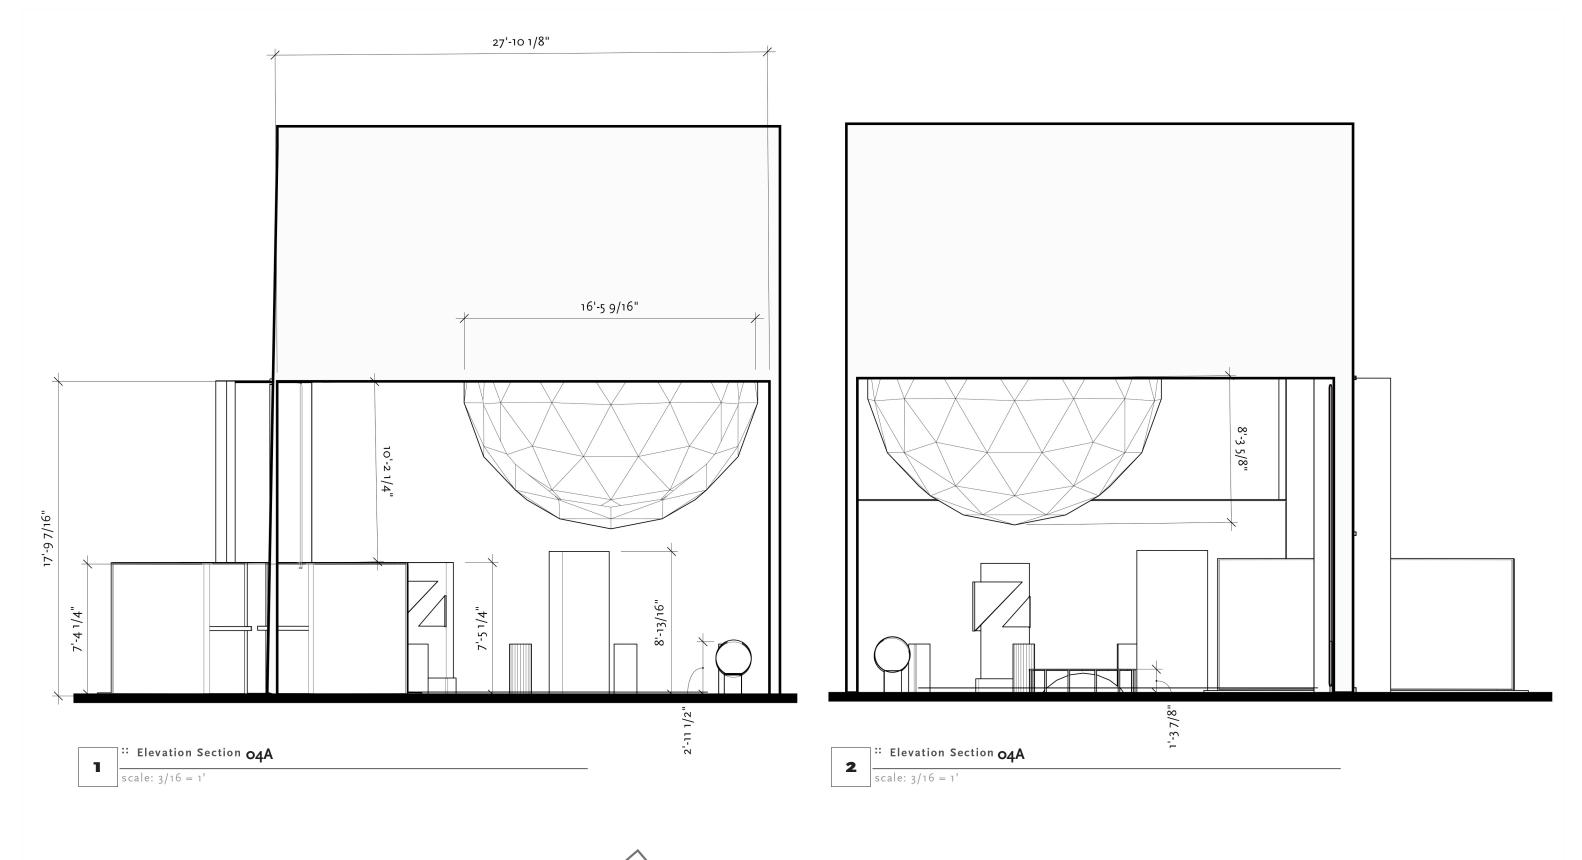
03A Sections 3 and 4

Scale: 1/16 = 1'

1 Drawn by: Eve Frudakis

Date: 11.03.2021

Drawing NO.



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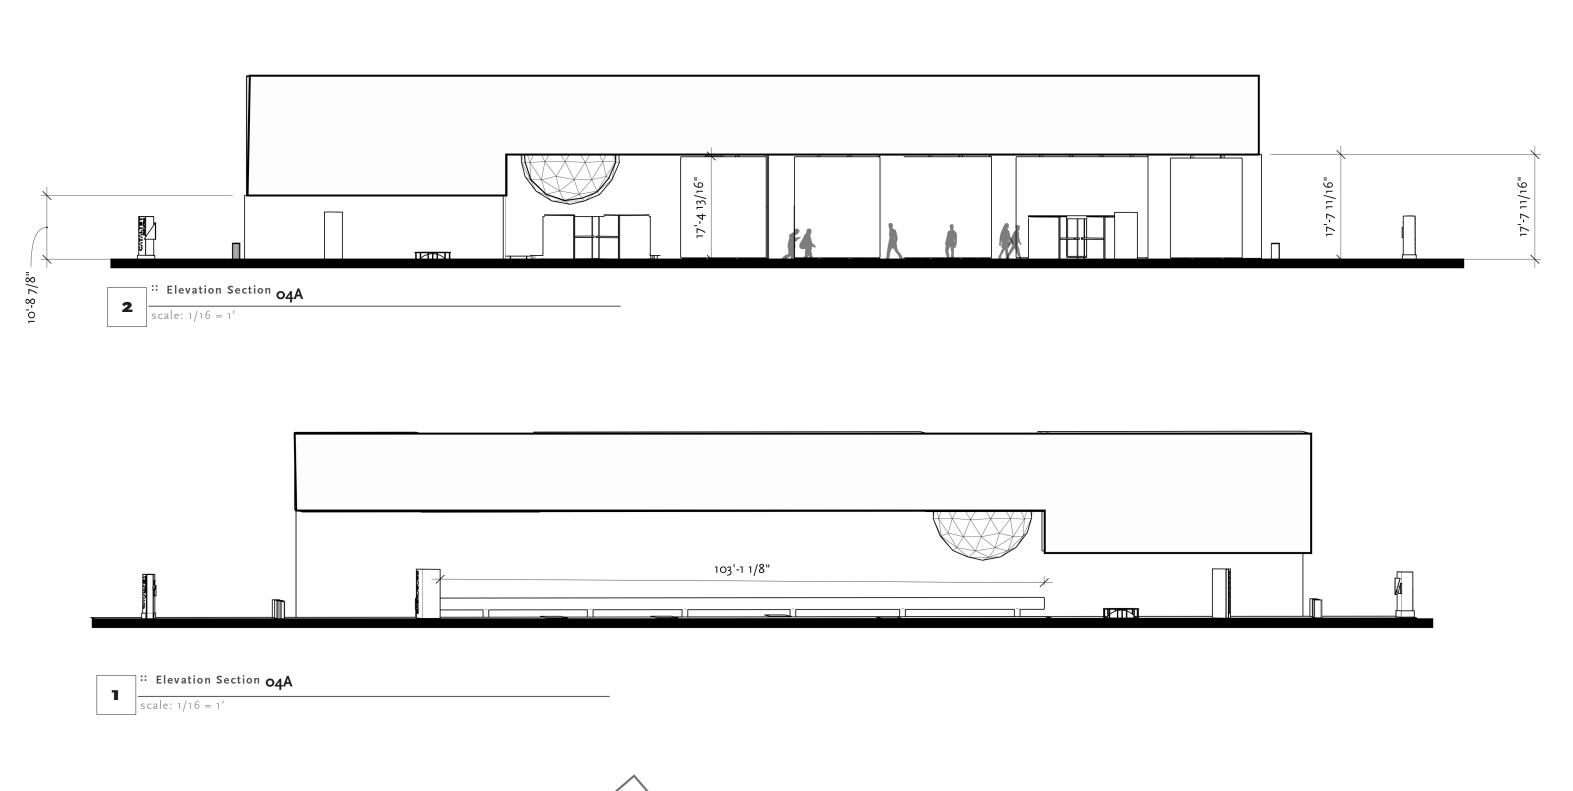
Title: 04A Sections 1 and 2

Scale: 3/16 = 1'

1 Drawn by: Eve Frudakis

Date: 11.03.2021

Drawing NO.



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Key Plan:

Title: 04A Sections 1 and 2

Scale: 1/16 =1'

EX 333

Drawn by: Eve Frudakis

Date: 11.03.2021

Drawing NO.



:: GRAPHIC IDENTITY

TYPE

CATALYST Made of Stars

AN IMMERSIVE JOURNEY OF THE INNATE... EXPERIENCE THE LARGE AND SMALL WORLDS THAT COEXIST WITHIN AND AROUND YOU.

Lorem ipsum dolor sit amet, consectetuer adipisc ing elit, sed diam nonummy nibham eauismod tinc unt ut laoreet dolore magna aliquam erat volutpat. Ut wisi enim adminl miminim veniam, quis nostrud exerci tation ullamcoper suscipit lobortis nisl ut et aliquip ex ea commodo consequat. Duis autem vel eum iriure dolor in hendre.

"Be still and listen, the earth breathes."

ABCDEFGHIJKLM NOPORSTUVWXYZ NOPORSTUVWXYZ abcdefghijklm nopgrstuvwxyz 1234567890

ABCDEFGHIJKLM

NOPQRSTUVWXYZ

abcdefghijklm

nopqrstuvwxyz

1234567890

ABCDEFGHIJKLM abcdefghijklm nopqrstuvwxyz 1234567890

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NOPORSTUVWXYZ

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nopgrstuvwxyz

REFERENCE


Patterns | Textures










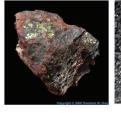



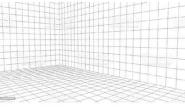

Patterns A

Look Reference


Patterns B

Texture B

Texture C

Pattern C

Material

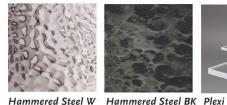





Texture A




Lighting




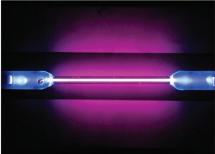

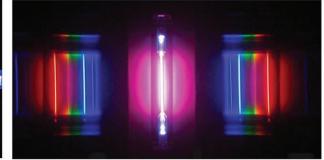

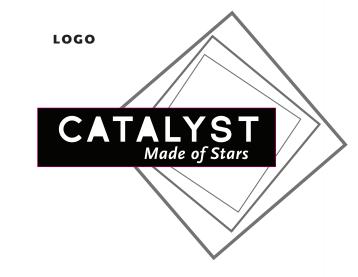

COLOR

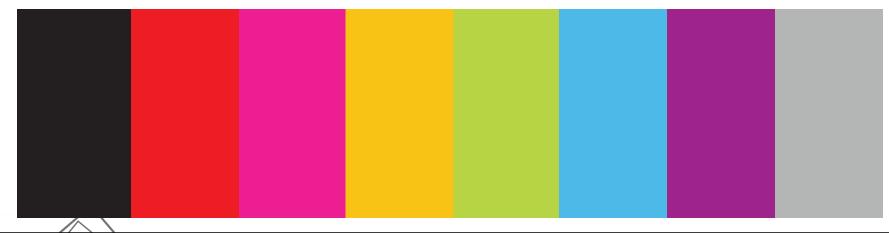

Eve Frudakis

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Key Plan:

Graphic Identity


Scale: N/A

Drawn by: Eve Frudakis

Date: 11.03.2021

Drawing

EX

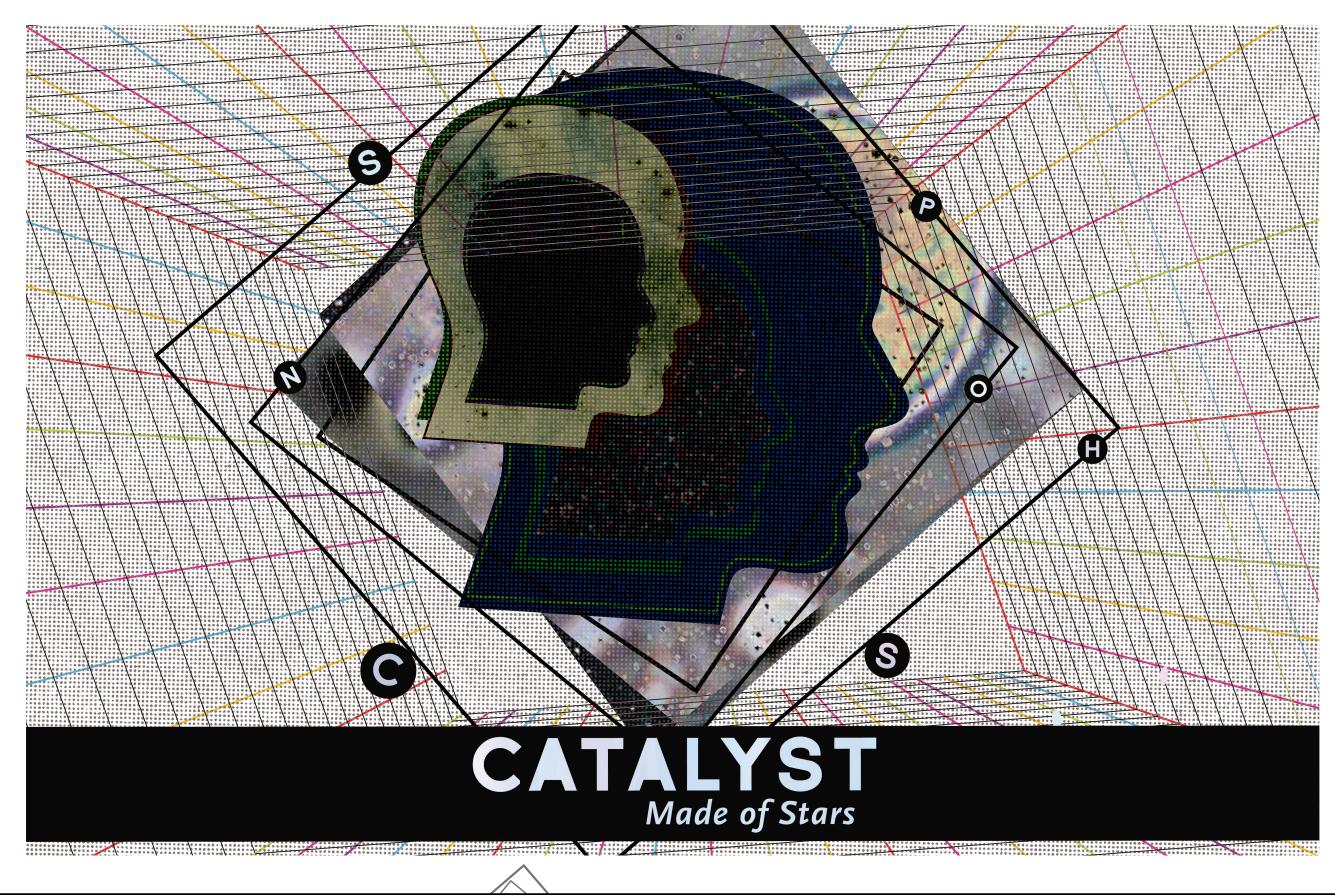



Exhibition and Experience Design

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New York, NY 10011

Project:

CATALYST

Made of Stars

Client:

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Key Plan:

Look and Feel

Scale: N/A


Drawn by: Eve Frudakis

Date: 11.03.2021


401

Drawing


:: AREA LOOK AND FEEL

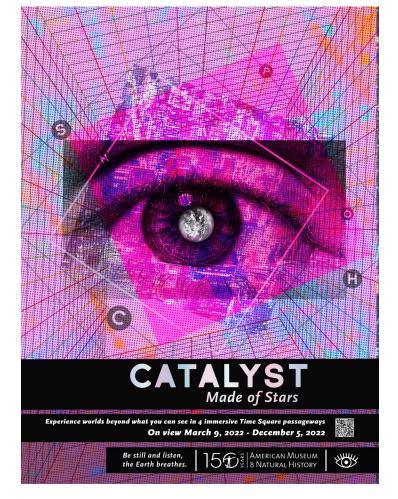


AREA O1: WHAT WE CAN SEE

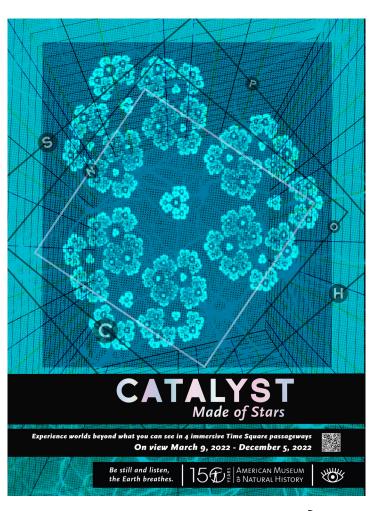

AREA 02: WHAT IS A FRACTAL?

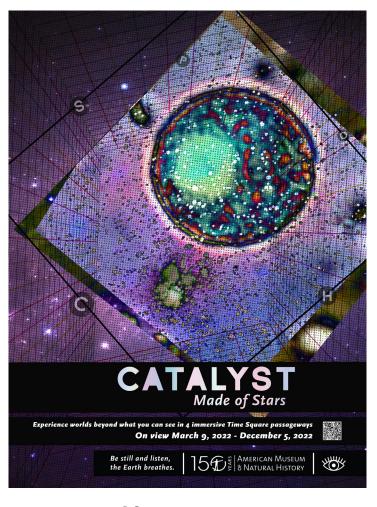

AREA 03: ATOMIC MAYHEM

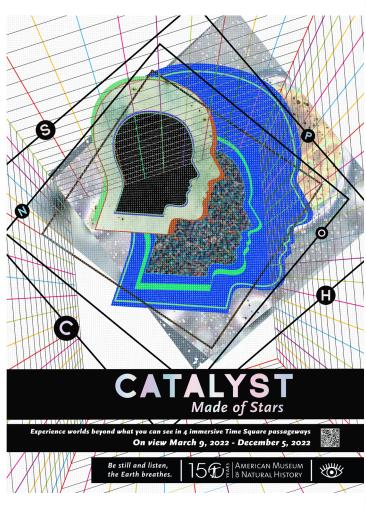

AREA 04: COSMIC SCALE

Eve Frud	lakis	S	
Exhibition	and	Experience	Design

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ixcy i iaii.

Title: Area Look and Feel

Scale: N/A

Drawn by: Eve Frudakis

Date: 11.03.2021

Drawing NO.

402

:: WAY-FINDING





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Key Plan:

Title: Waγ-finding


Scale:

Drawn by: Eve Frudakis Date: 11.03.2021

Drawing NO.

EX

:: WAY-FINDING

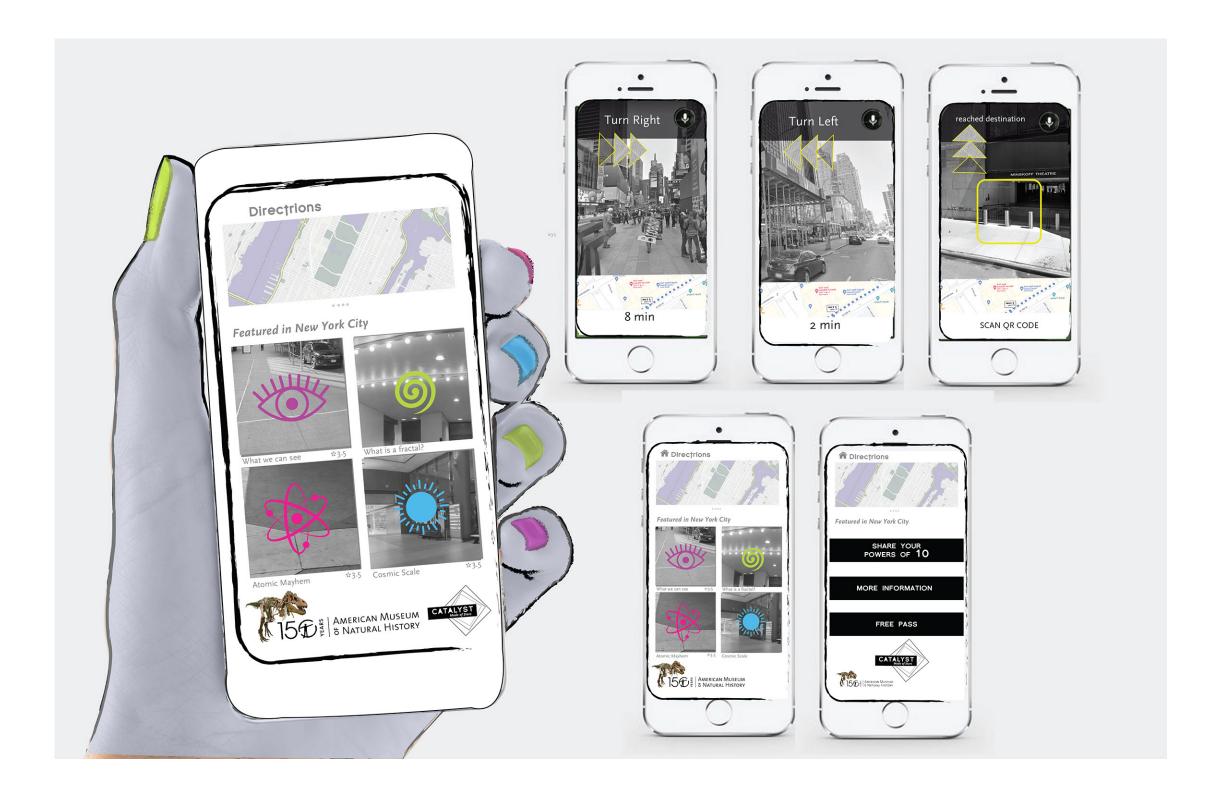

Eve F	rudakis
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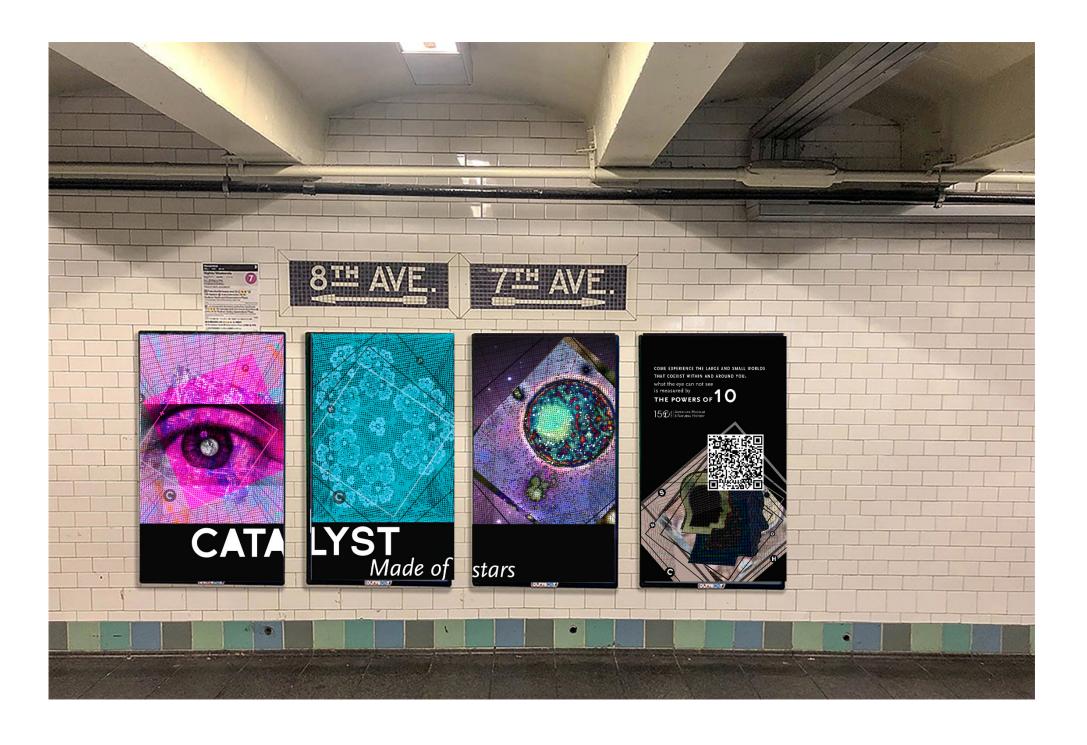
Key Plan:

Title: Waγ-finding Scale: N/A

Drawn by: Eve Frudakis

EX

:: WAY-FINDING






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Title: Waγ-finding

Scale: N/A

Drawn by: Eve Frudakis

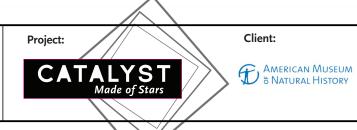Date: 11.03.2021

Drawing NO.

EX

:: COLLATERAL



PASSES UPON CHECK IN AT AMNH W/ DIGITAL PASS



KALEIDOSCOPE



FIDGET CUBE



PRISM

Eve Frudakis

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Key F	Plan:
-------	-------

Title: Collateral Scale:

Drawn by: Eve Frudakis

Date: 11.03.2021

Drawing

EX

:: EXHIBITION DETAILING

:: 00.01.GR01 | Introduction | Sign Type A & B





:: ooA.o1.GRo1 TOP

Scale: N/A

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Key Plan:

Title: Introduction: Infinity Mirror

Scale:
1:24

Drawn by: Eve Frudakis


Drawing NO.


EX

500

Date: 11.03.2021

:: oo.o1.GRo1 | Introduction | Sign Type A & B

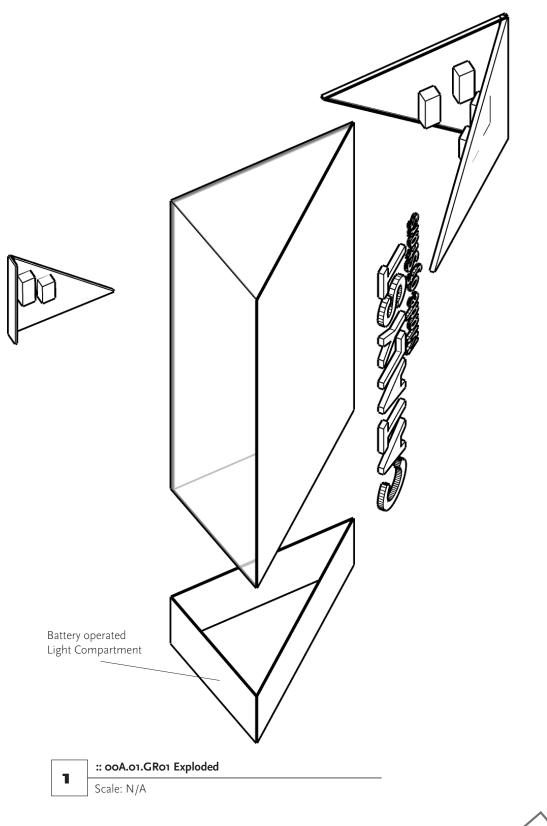

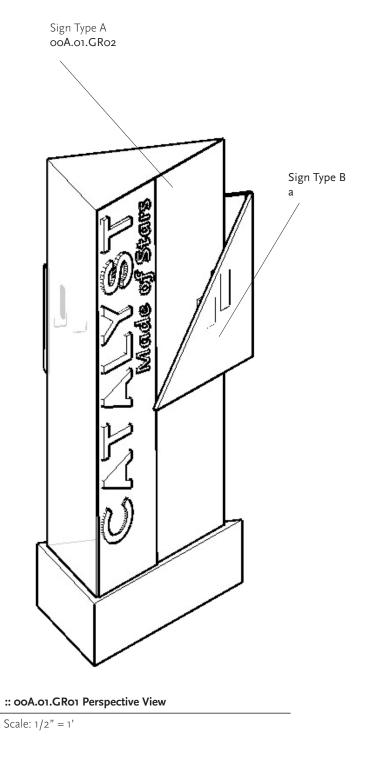

:: ooA.o1.GRo2 Perspective View

Scale: 1/2" = 1'

Eve Frudakis Exhibition and Experience Design

EXHIBITION DOCUMENTATION

Fashion Institute of Technology School of Graduate Studies 272 West 27th St. New York, NY 10011

Project:

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Key Plan:

Title: Area Introduction


Scale: 1:24

Drawn by: Eve Frudakis

Date: 11.03.2021

Drawing

EX

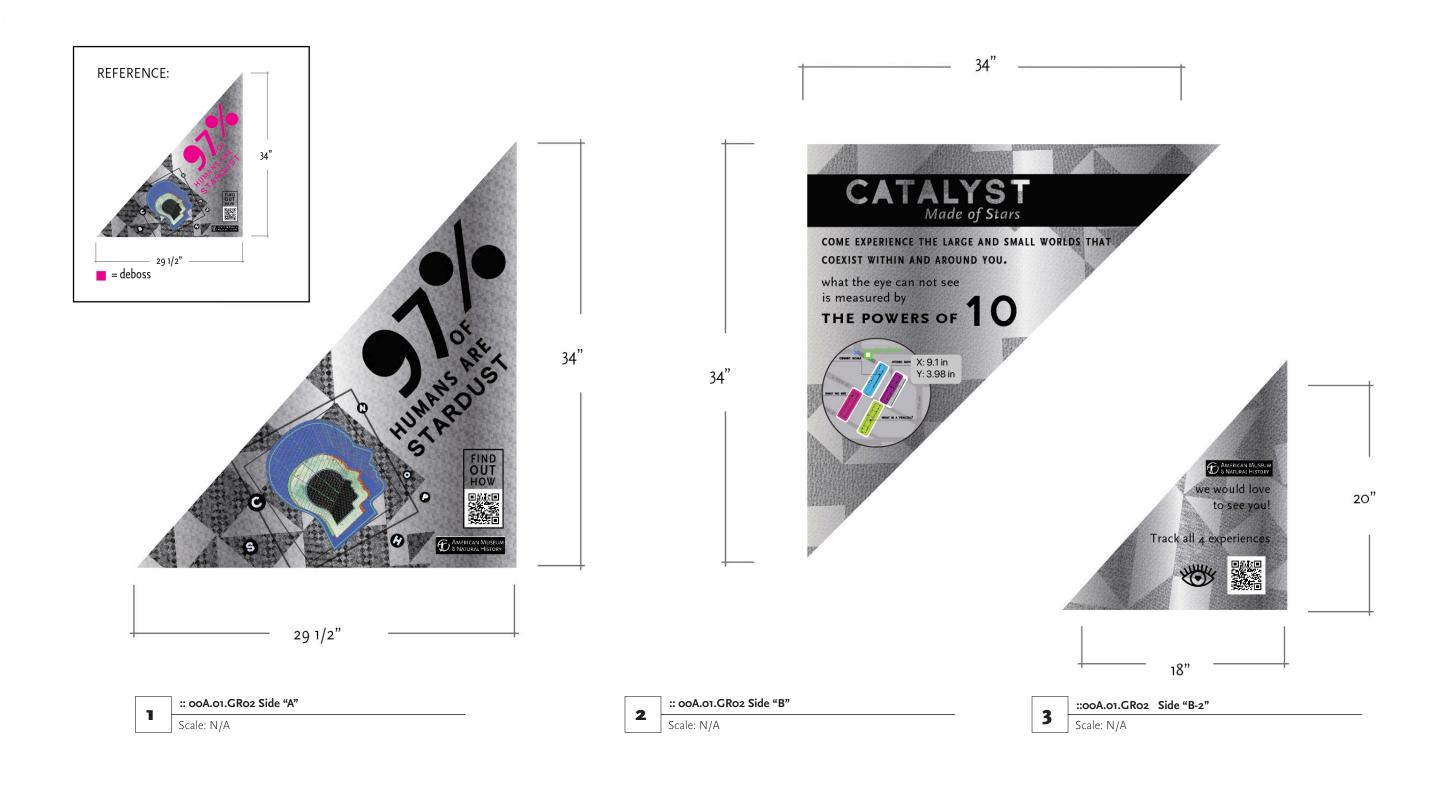

Client:



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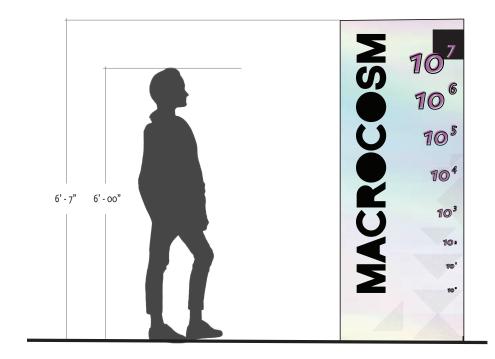
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Key

Plan:	Title: Area Introduction

Scale: EX 502 Drawn by: Eve Frudakis Drawing Date: 11.03.2021

NO.









:: 02A.03.GR01 Elevation Front View "A" Scale 1/2 = 1'

Client:

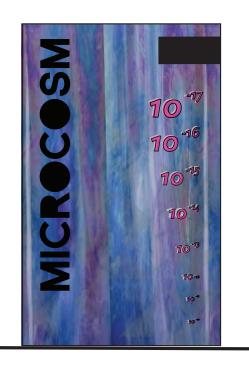

:: 03A.03.GR01 Elevation Front View "A" Scale 1/2 = 1'

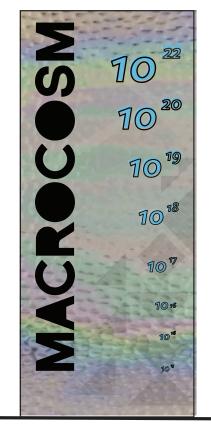

:: 04A.03.GR01 Elevation Front View "A" 2 Scale 1/2 = 1'

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Key Plan:

Area Introduction


Scale: 1/2"=1'

Drawn by: Eve Frudakis


Drawing Date: 11.03.2021 NO.


EX


:: 01A.03.GR01 | Area Introduction

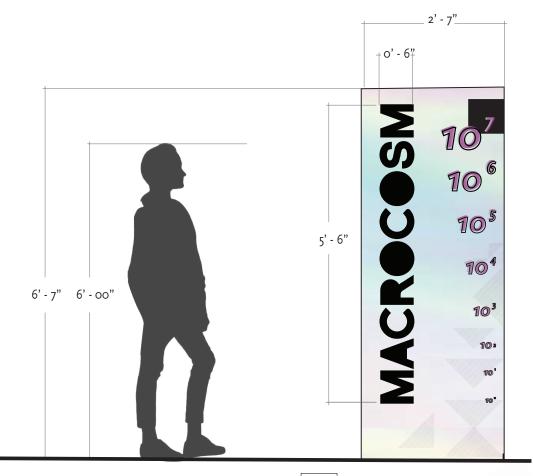



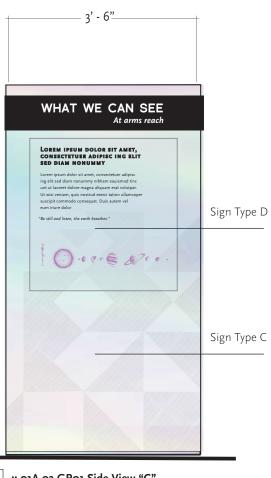


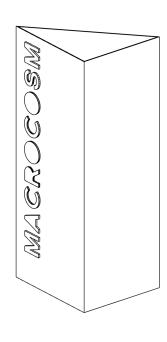


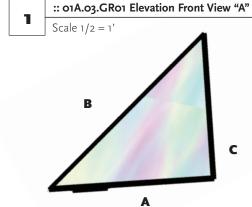

:: 01A.03.GR01 Elevation Top View

Scale 1/2 = 1'

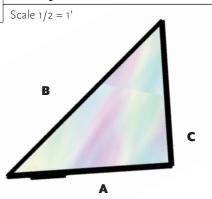

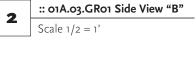



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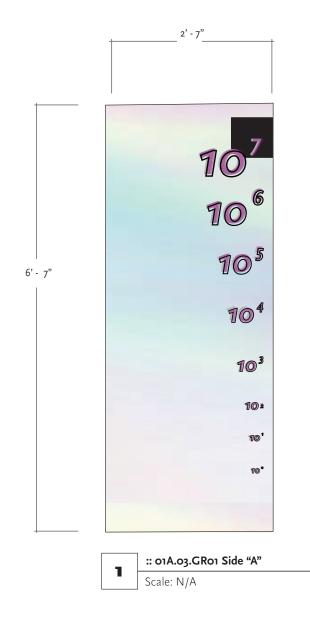
Title: Area Introduction

Scale: EX 1:24 504 Drawn by: Eve Frudakis Date: 11.03.2021

Drawing NO.

:: 01A.03.GR01 | Area Introduction | Sign Type C












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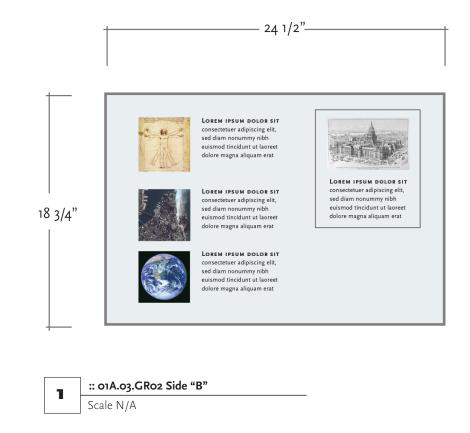


Area Introduction

Scale: 1:24

505 Drawn by: Eve Frudakis Date: 11.03.2021

Drawing NO.

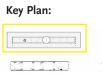

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"Be still and listen, the earth breathes."

:: 01A.03.GR02 Side "C"

Scale N/A

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Title: Area Introduction

Scale:
N/A


Drawn by: Eve Frudakis

Drawn by: Eve Frudakis


Date: 11.03.2021

Drawing NO.


EX

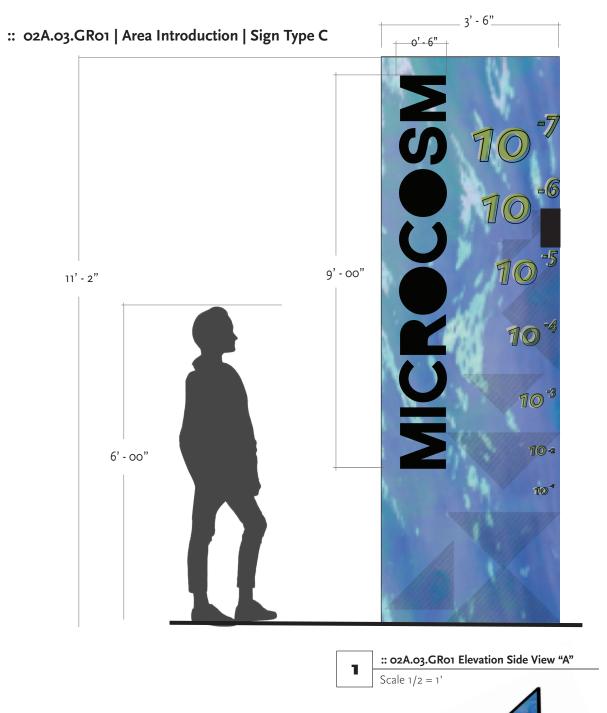



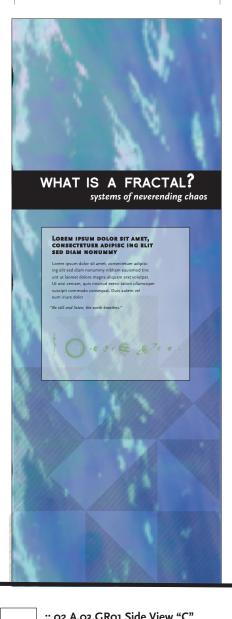

4' - 00"

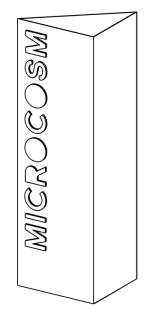

Scale 1/2 = 1'

B

:: 02A.03.GR01 Side View "B"

Scale 1/2 = 1'

3 :: 02 A.03.GR01 Side View "C"

Scale 1/2 = 1'

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2

Scale 1/2 = 1'



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Title: Area Introduction

ion

Scale:
1/2"=1'


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EX
507

Date: 11.03.2021 Drawing NO.


:: 02A.03.GR01 | Area Introduction | Sign Type C



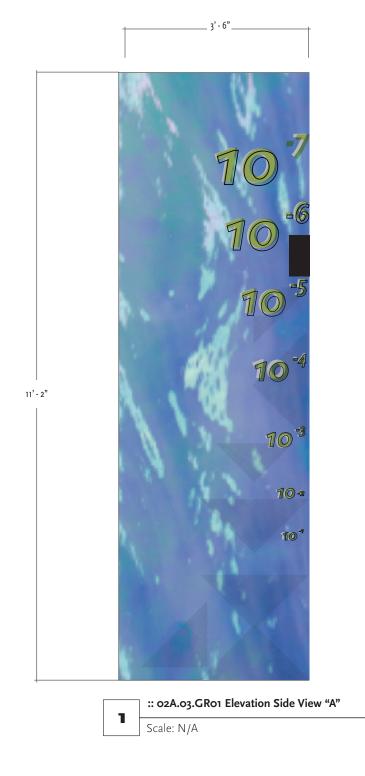

Powers 10⁻² - 10⁻⁷ :: 02A.03.GR01 Side View "B" 2

Scale: N/A

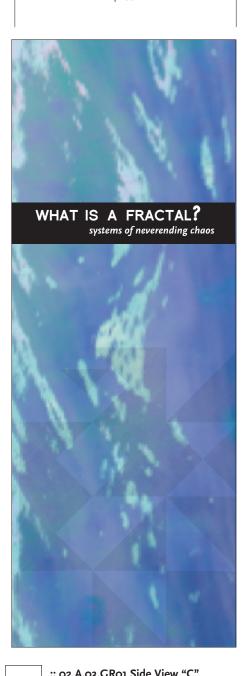

:: 02 A.03.GR01 Side View "C" Scale: N/A

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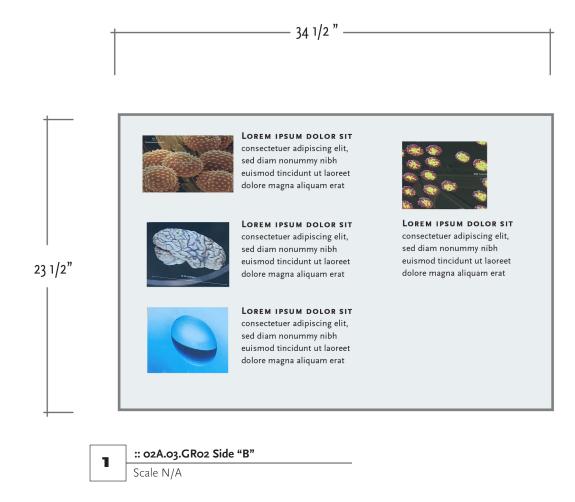
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Area Introduction

Scale: N/A

Drawn by: Eve Frudakis Date: 11.03.2021

Drawing NO.



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"Be still and listen, the earth breathes."



:: 02A.03.GR02 Side "C"

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Client:



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33"

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. 00

Area Introduction

Scale: N/A

Drawn by: Eve Frudakis


Drawing

EX

509

Date: 11.03.2021

:: 03A.03.GR01 | Area Introduction | Sign Type C

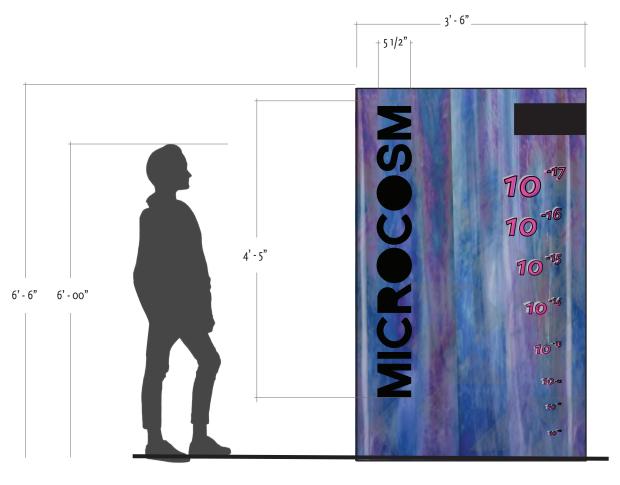

Powers 10⁻¹⁰ - 10⁻²⁰

Formi

fermis

picometers

angstrom

ATOMIC MAYHEM
Storing and releasing energy

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"Be still and lister, the earth breathes."

4'-00"

Scale 1/2 = 1'

B

A

33A.03.GR01 Side Top "C"

Scale 1/2 = 1'

:: 03A.03.GR01 Side View "B"

Scale 1/2 = 1'

:: **o3A.o3.GRo1 Side View "C"**Scale 1/2 = 1'

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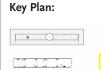


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00

Title: Area Introduction Scale: 1/2"=1"

Drawn by: Eve Frudakis

Date: 11.03.2021 Drawing NO.





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. 0

Area Introduction


Scale: N/A

Drawn by: Eve Frudakis

Date: 11.03.2021

Drawing NO.

EX

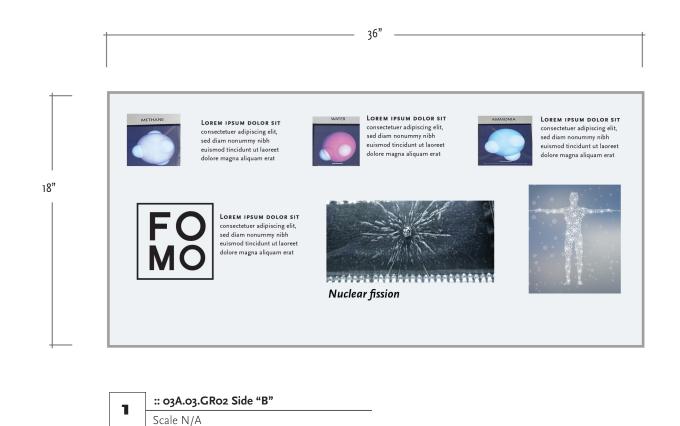

LOREM IPSUM DOLOR SIT AMET, CONSECTETUER ADIPISC ING ELIT **SED DIAM NONUMMY** Lorem ipsum dolor sit amet, consectetuer adipisc ing elit sed diam nonummy nibham eauismod tinc unt ut laoreet dolore magna aliquam erat volutpat. Ut wisi veniam, quis nostrud exerci tation ullamcoper suscipit commodo consequat. Duis autem vel eum iriure dolor 33" "Be still and listen, the earth breathes."

:: 03A.03.GR02 Side "C"

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Area Introduction

00

Drawn by: Eve Frudakis


Date: 11.03.2021

Scale:

N/A


Drawing

EX

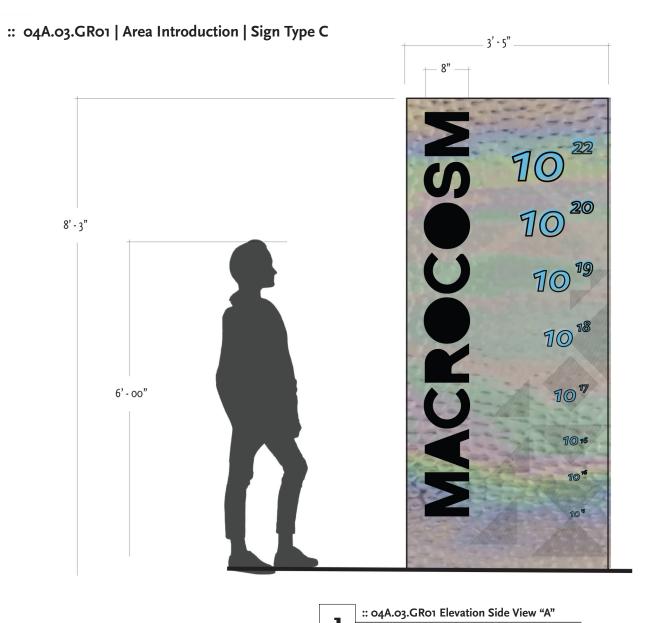



3' - 10"

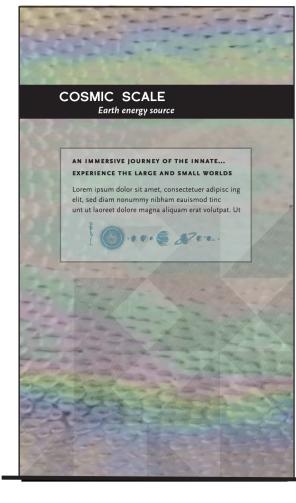

4' - 00"

C

:: 04A.03.GR01 Side View "B"

:: 04A.03.GR01 Side View "C" Scale 1/2 = 1'

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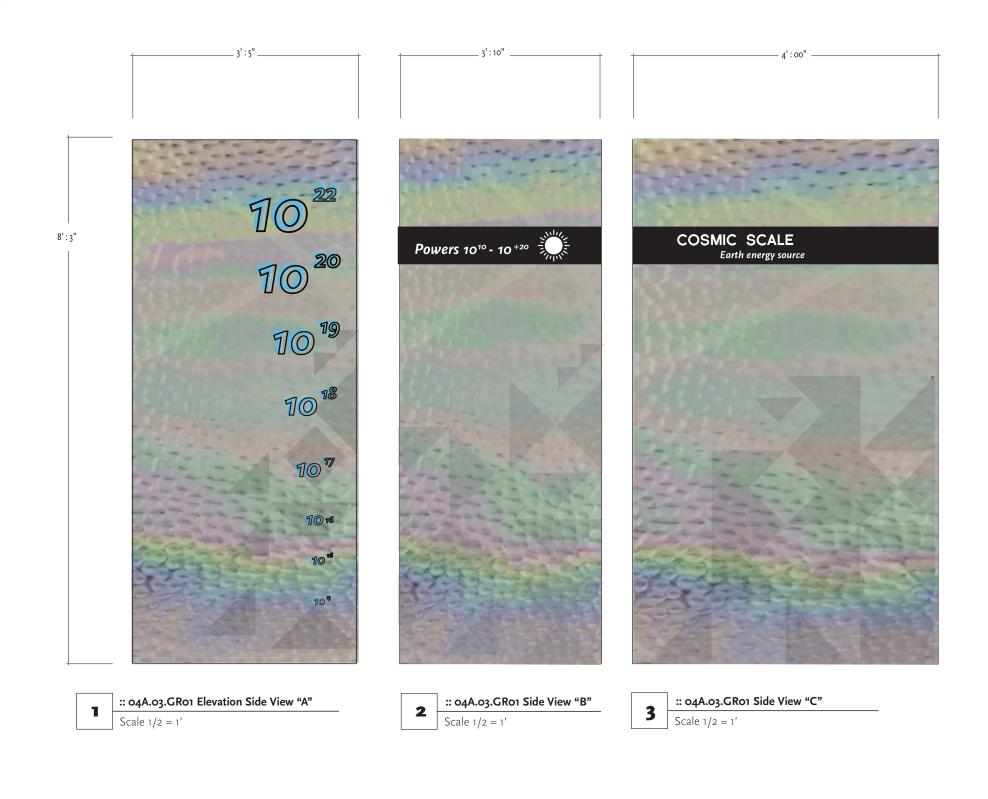


Title: Area Introduction


Scale: 1/2"=1


513 Drawn by: Eve Frudakis Date: 11.03.2021

Drawing





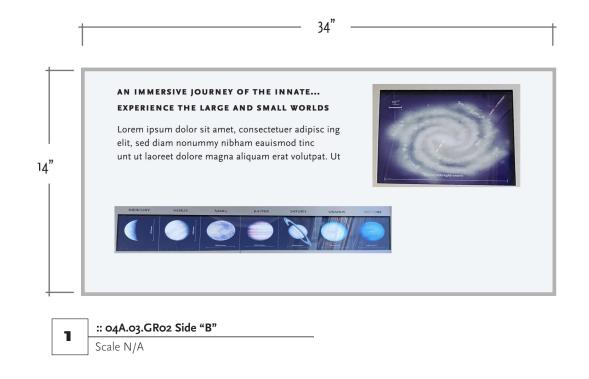

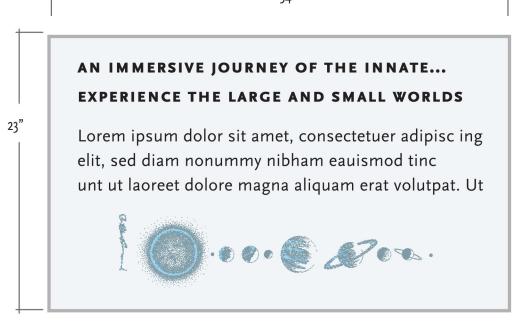

2 :: 04A.03.GR02 Side "C"

Scale N/A

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.

Title: Area Introduction

Scale: N/A


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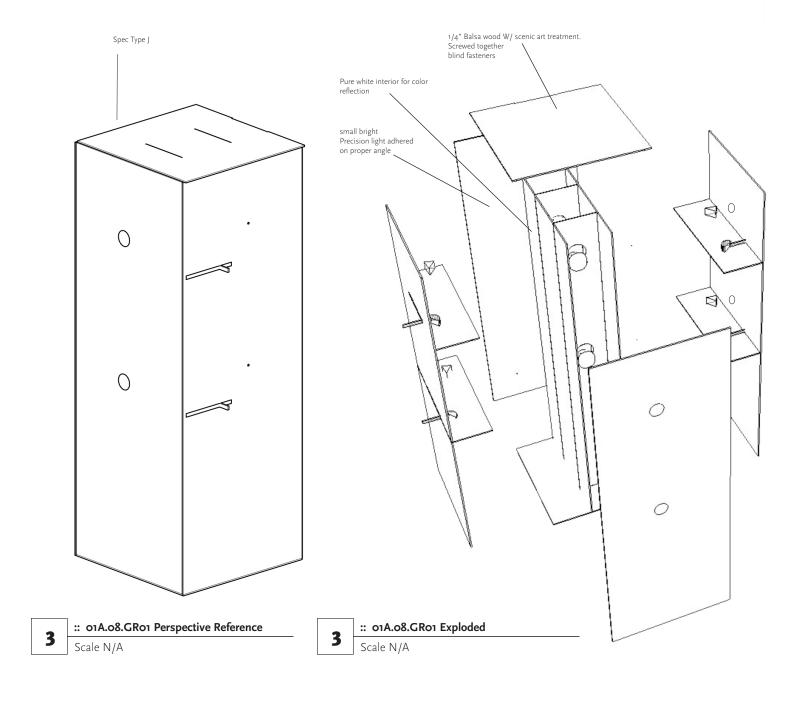
Drawn by: Eve Frudakis

Date: 11.03.2021

Drawing NO.

EX



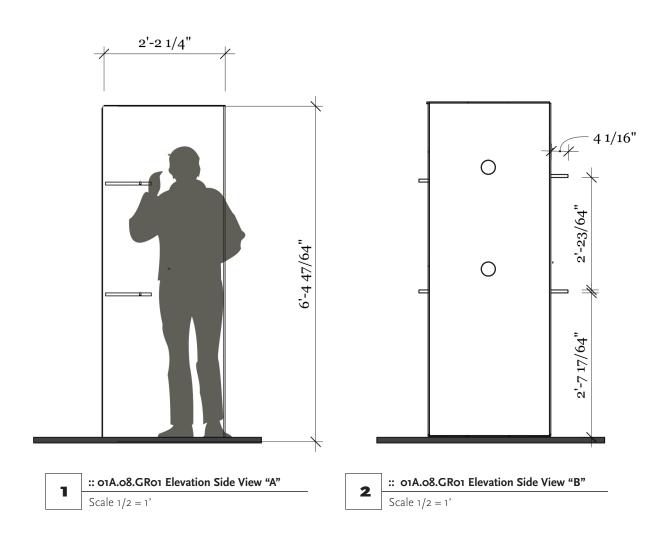

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Title: 01A Look, See, Hear

Scale: N/A

le: A

Drawn by: Eve Frudakis
Date: 11.03.2021

Drawing NO.

1



:: 01A.08.GR01 Elevation Side View "A" Scale 1/2 = 1



:: 01A.08.GR01 Elevation Side View "B" Scale 1/2 = 1



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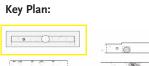
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Title: 01A Look, See, Hear

Scale: N/A


Drawn by: Eve Frudakis Date: 11.03.2021

Drawing NO.

1

EX

:: 02A.06.GR01 | Enter the Bloodstream

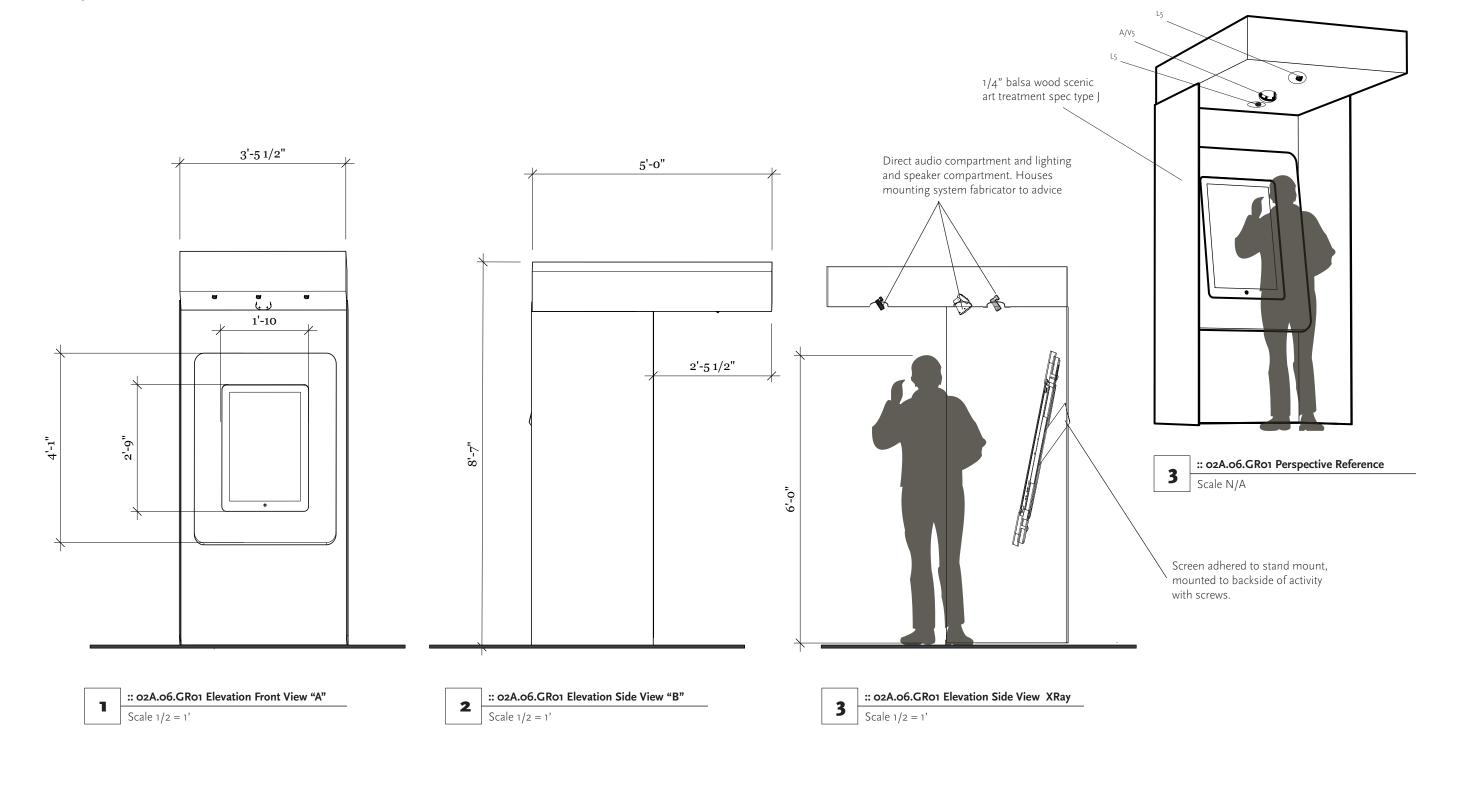



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Title: 02A Enter the Bloodstream


Scale: 1/2" = 1'


1

Drawn by: Eve Frudakis Date: 11.03.2021

Drawing NO.

:: 02A.06.GR01 | Enter the Bloodstream

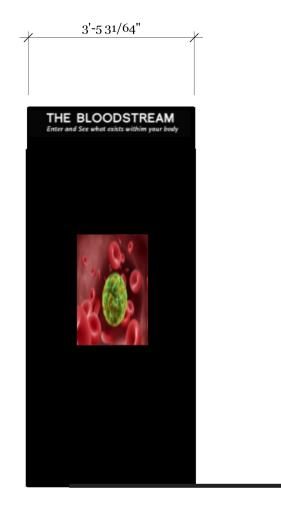

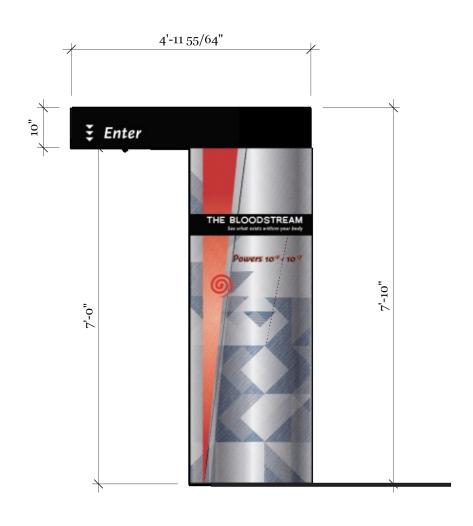

:: o2A.o6.GRo1 Elevation Front View "A"

Scale 1/2 = 1'

2 :: **02A.06.GR01** Elevation Side View "B"

Scale 1/2 = 1'



3 :: 02A.06.GR01 Elevation Back View "C"

Scale 1/2 = 1'

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Key Plan:



Title: Ao2

Title: Solution Ao2
Enter the Bloodstream

Scale: 1/2" = 1'


Frudakis


Drawn by: Eve Frudakis

Date: 11.03.2021

Drawing NO.

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00

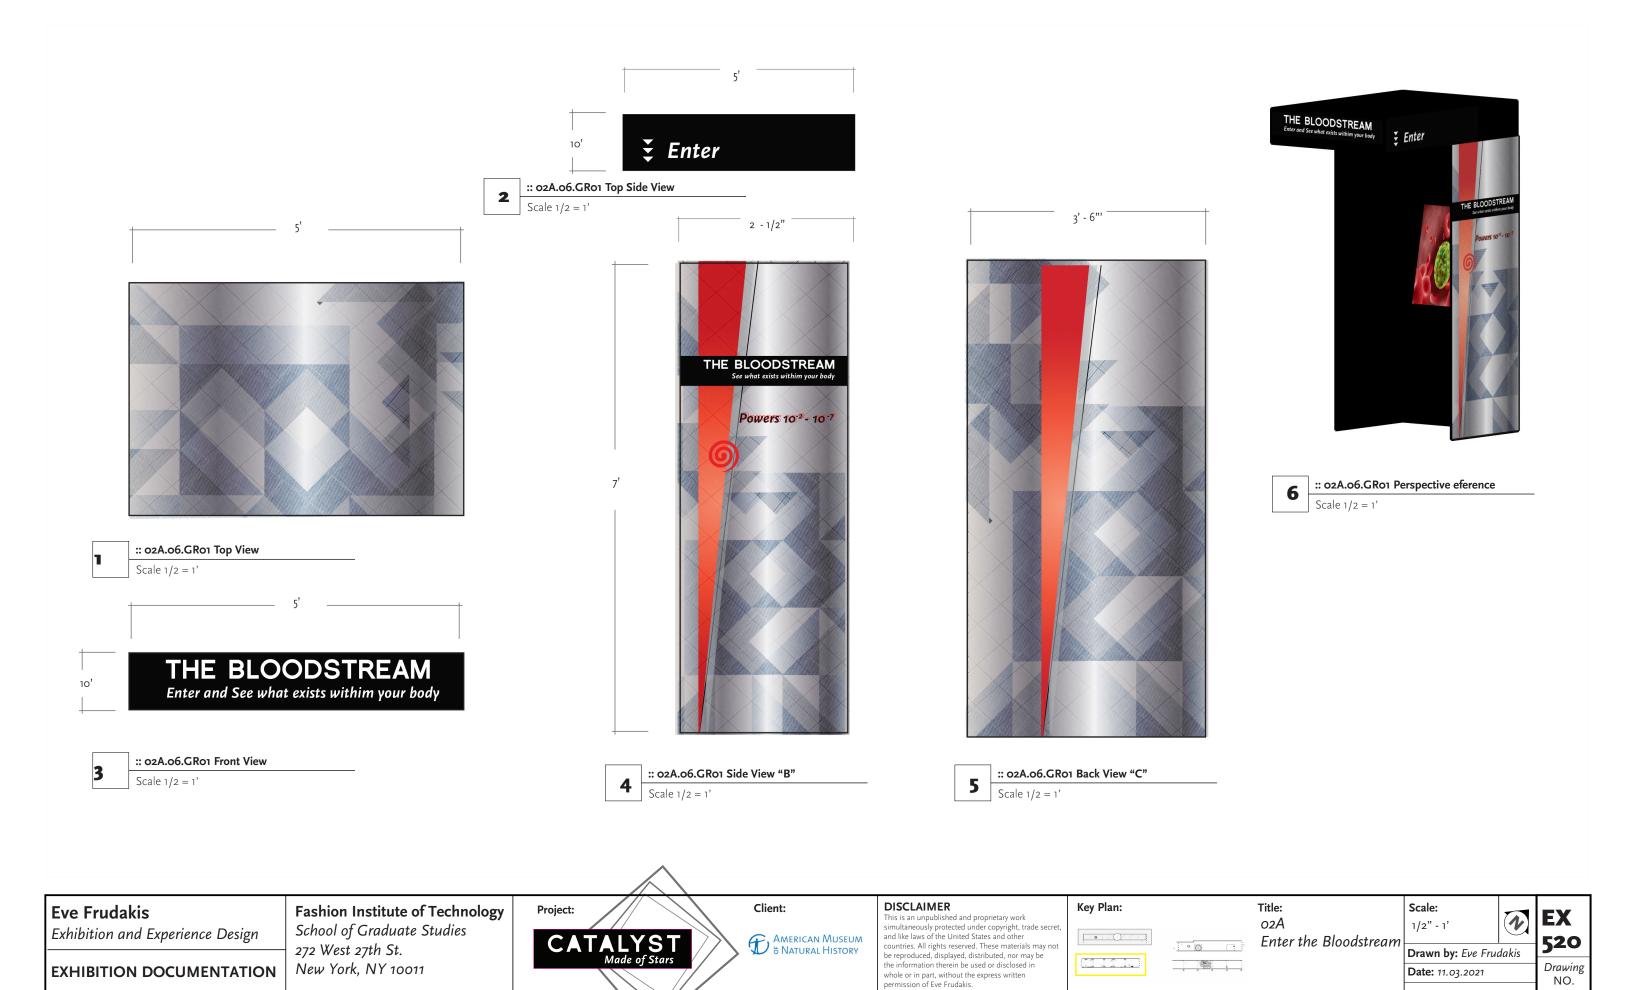Title: 03A Nucleus Detail

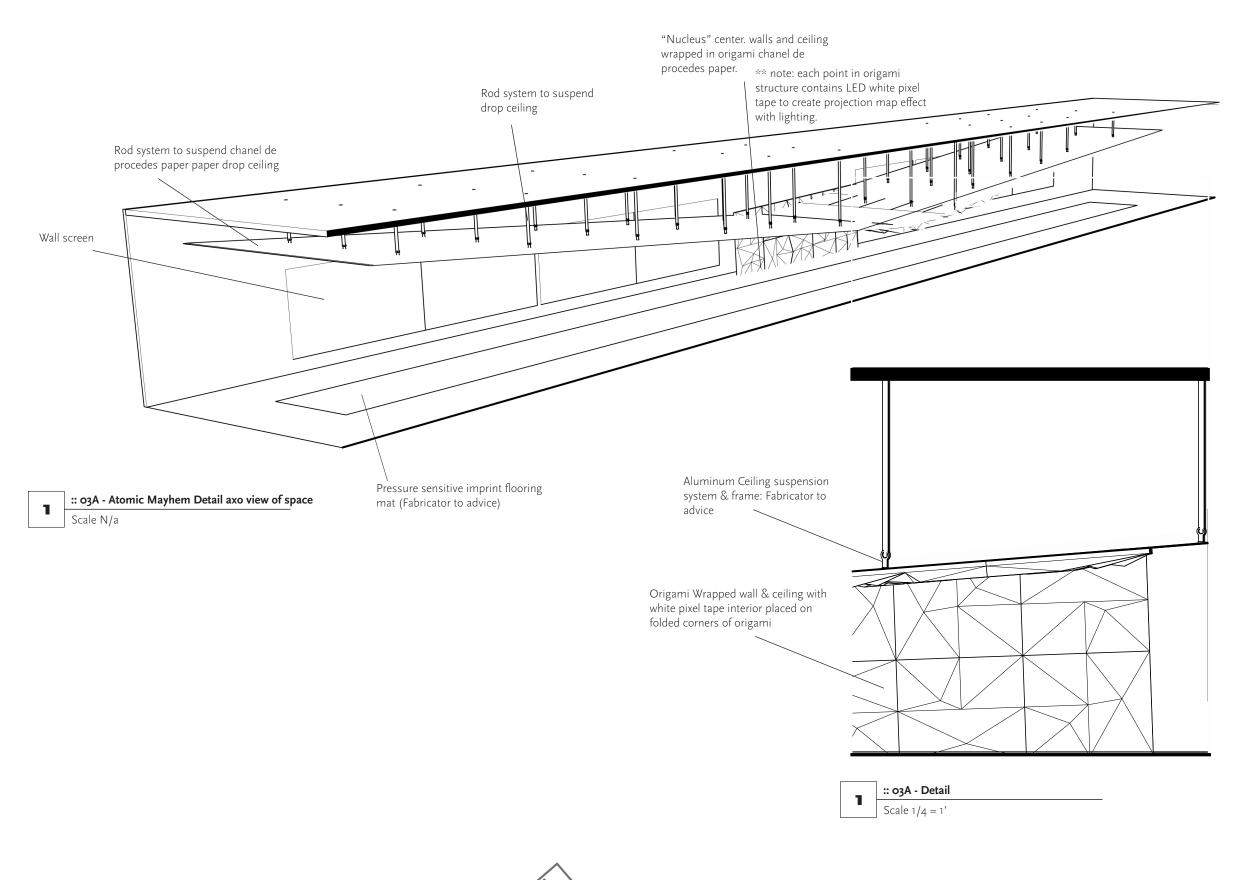Scale: 1/4 = 1'

4 = 1'

Drawn by: Eve Frudakis

1

EX