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Purchasing@fitnyc.edu

NOTICE TO ALL FIRMS

Date: June 29, 2023

To: All Prospective Bidders

From: Sam Li

Deputy Director of Purchasing

Re: Addendum Number 2

IFB # C1576 - D442 Classroom Renovation

Notes:

As there are no dwelling units in the building, the DOB should not require a Tenant Protection Plan to obtain a Construction Permit.

2) Mechanical & Electrical scope of work has been revised so that it no longer includes the VAV box. The VAV box is being removed from the scope of this project. The VAV will be installed by FIT as part of a separate on-going project. The D442 Contractor is to coordinate with FIT's other Contractor who will be installing the VAV box.

See attached revised Mechanical & Electrical Drawings (attached to the bottom of this addendum):

M-001.00

M-104.00

M-501.00

M-701.00

M-801.00

E-200.00

E-600.00

Questions:


- Q1. Specification section 088030 (Magnetic Pegboard) is included in the spec book. Where is this item installed on the project?
- A1. Refer to drawing A-100. On the plan 1/A-100 wall elevation reference points to the wall where Clarus Float Magnetic Glass Marker Board W/Box Tray is located, between 2 TV monitors. See construction plan note #5. Also see sheet A-300, east-interior elevation 2.
- Q2. Construction plan note 11, on drawing A-100.00, to "patch exist quarry tile floor & install self-leveling". Since the quarry tile was concealed by the existing finished floor, we cannot determine the extent of the patching that may or may not be required. How do we proceed?
- A2. On the drawing DM-100.00 4th Floor Demolition Plan demolition note #5 calls for "Remove Existing Carpeting & Vct Below Down to Quarry Tile, Scrape & Prep As Req". For purpose of bidding, assume 50% SF patching.
- Q3. Is the GC only required to provide back boxes and conduit stub ups for the data/comm/AV outlets?
- A3. Refer to Electrical drawings power notes on drawing E-200. FIT IT will pull the wiring. GC to coordinate with FIT's Data and AV contractor.
- Q4. Reflected Ceiling Plans, 3 & 11, notes to patch and repair the existing slab & beam. To what extent are these surfaces to be repaired?

- A4. On RCP Plan notes #3 and #10 call for patching and repair. These surfaces are scheduled to be painted, thus they have to be repaired and prepped to have a smooth and even appearance, to receive priming before painting.
- Q5. Drawing A-300, note 16 and elevation 4, indicates that all the windows are to receive new gaskets. It was mentioned at the site visit, only the operable windows were to receive new gasket. Please advise.
- Confirming that only operable windows will receive new gasket. All windows (both operable and non-operable) to have glass and frames cleaned.
- The scope of work notes to install new fire alarm strobes as indicated on plans. No fire alarm drawings were included in the set of documents. Please clarify.
- A6. There are no strobes, or other fire alarm devices in this project
- Q7. Please provide building fire alarm vendor information.
- A7. Not required. See answer A6.
- Q8. Can you please verify Furniture is supplied by owner vs. part of GC Package?
- A8. Client supplies the furniture.
- Q9.
- What is your time frame for Furniture Quotes /Estimated installation dates? Once the contractor wins the project, they should contact the furniture dealer and find out and put A9. that in their schedule to meet the deadline.
- Are you accepting alternates for the furniture? Q10.
- A10. No.
- Q11. Bid drawing "DM-400", demolition note # 11 states "Existing Ceiling and Lighting to be removed and Stored for Reinstallation. Coordinate the exact demo. scope with mech. Dwgs". In contrast to this, bid drawing "A-400", Reflected ceiling plan note # 4 states "Remove & Replace existing ceiling tiles as required to complete mechanical work". Please clarify.
- A11. See attached revised DM-400.01 and A-400.01 with revised notes.
- Bid drawing "A-100", Construction plan note # 8 states "Relocated 36 existing lockers". However, Q12. the quantity of lockers depicted on the bid drawings are 24. Please clarify the exact quantity.
- A12. 24 lockers to be reinstalled. Contractor is responsible for disposal of the remaining 12 lockers. See attached revised a-100.01 with revised notes.
- Q13. Bid drawing "A-100", Construction plan note # 12 states "New courtesy telephone". Please specify the specifications of courtesy telephone as bid documents do not specify.
- A13. Courtesy telephone to be provided by FIT. Contractor to provide black box and empty conduit. Coordinate with FIT IT and their installer.
- Q14. Bid drawing "A-700", Door schedule specifies the thickness of corridor door 1 as 2-1/4 inch. However, the specified manufacturer has confirmed that they do not provide 2-1/4 inch thickness. Specified manufacturer has confirmed the thickness of door to be 1-3/4" inches. Please confirm.
- A14. 1-3/4" thickness is acceptable. See revised A-700.01
- Q15 a. Will FIT provide a room to GC, during the execution of project, to be used as site office? b. Will FIT allow the GC, during execution of project, to use existing toilets?
- a. No site office will be available, but the facility will try to accommodate. A15.
 - b. Yes, however, GC is responsible for leaving it clean daily at the end of shift.

- Q16. Will GC be allowed to used building elevator and stair case to access work area?
- A16. Contractors- to use the staircase P to bring equipment & material up and down. They may also use the freight elevator in Dubinsky (which was shown to contractors who attended walk-through). The passenger elevator may not be used for equipment or materials, but the workers may use it for site access only.

THIS ADDENDUM IS PART OF THE CONTRACT DOCUMENT AND SHALL BE INCLUDED WITH YOUR REQUEST FOR PROPOSAL SUBMITTAL. YOUR SIGNATURE BELOW WARRANTS THAT YOU UNDERSTAND THIS ADDENDUM AND THAT YOU HAVE MADE THE APPRORIATE ADJUSTMENTS IN YOUR PROPOSAL AND CALCULATIONS.

Signature
Print Name and Title of Authorized Representative
Print Name of Company/Partnership/Individual
Date

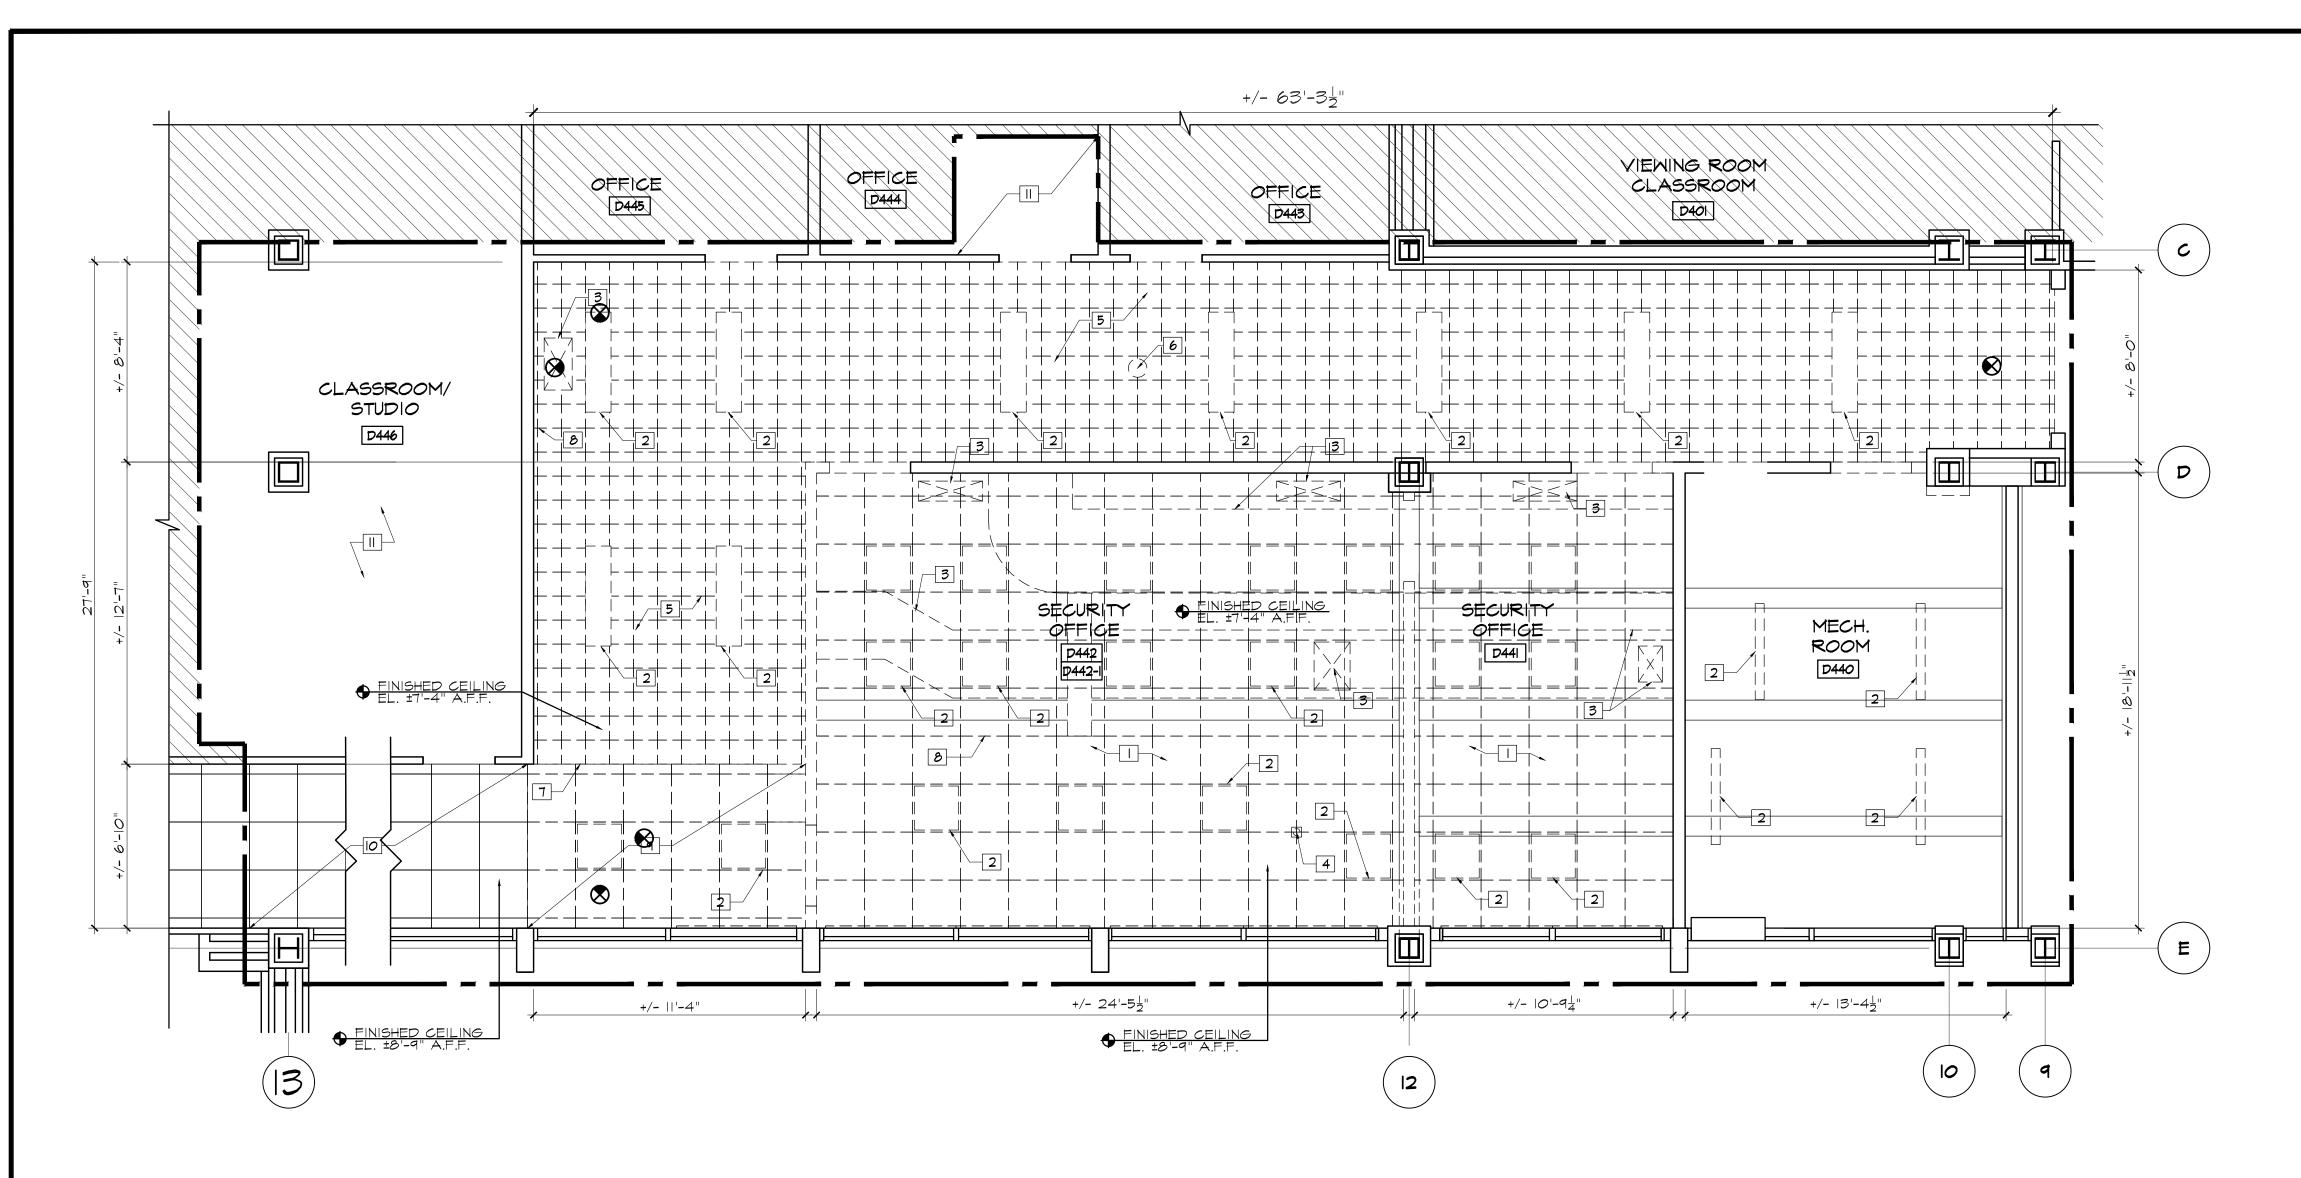

1 4TH FLOOR DEMO RCP DM-400 SCALE : 1/4" = 1'-0"

DEMOLITION NOTES

REMOVE ALL EXISTING 2X2 CEILING TILES, HANGERS AND SUPPORTING FRAME.

2 REMOVE ALL CEILING LIGHTS.

3 REMOVE EXIST. CEILING VENTS AND DUCTWORK, SEE MECH. DWGS FOR DETAILS

4 REMOVE EXIST. LIGHT SENSOR.

5 REMOVE EXIST. SPLINE CEILING AND ALL SUPPORTS.

6 FIT TO REMOVE EXIST. WIRE ACCESS POINT (WAP)

7 REMOVE EXIST. SOFFIT.

8 REMOVE EXIST. SPEAKER

9 EXIST. 2X2 ACT & LIGHTING TO BE REMOVED AND STORED FOR REINSTALLATION

O EXIST. 2X2 ACT & LIGHTING TO REMAIN & PROTECT AS REQ.

REMOVE AND INSTALL NEW CEILING TILES AS REQUIRED TO COMPLETE MECHANICAL WORK

GENERAL NOTES:

- I. ALL EXISTING EQUIPMENT TO REMAIN TO BE PROTECTED AS REQUIRED.
- CONTRACTOR TO PROVIDE PROTECTION TO ALL EXISTING WALLS AND CEILINGS THAT ARE TO REMAIN (TYP.).
 PROTECT ALL ADJACENT AREAS AND PATHWAYS OF TRAVEL TO AND FROM AREAS OF WORK.


LEGEND

= J = DOOR & DOOR FRAME TO BE REMOVED

= = = = = WALL TO BE REMOVED

WALL TO REMAIN

CONSTRUCTION LIMIT LINE

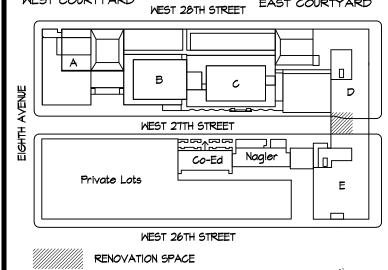



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 443 Park Avenue South
 New York, NY 10016

 212 889 4045
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PRO IFC

D442 CLASSROOM RENOVATION POMERANTZ 300 7TH AVE NEW YORK NY 10001

DRAWING TITLE:

4TH FL DEMOLITION PLAN REFLECTED CEILING PLAN


DEPARTMENT OF BUILDING JOB #

SEAL & SIGNATURE:

DATE: 6.7.2023
PROJECT No: 22320.3
DRAWING BY: M5/MH
CHK BY: DH & CK
DWG No:

DM-400.01

SCALE: AS NOTED 4 of 12

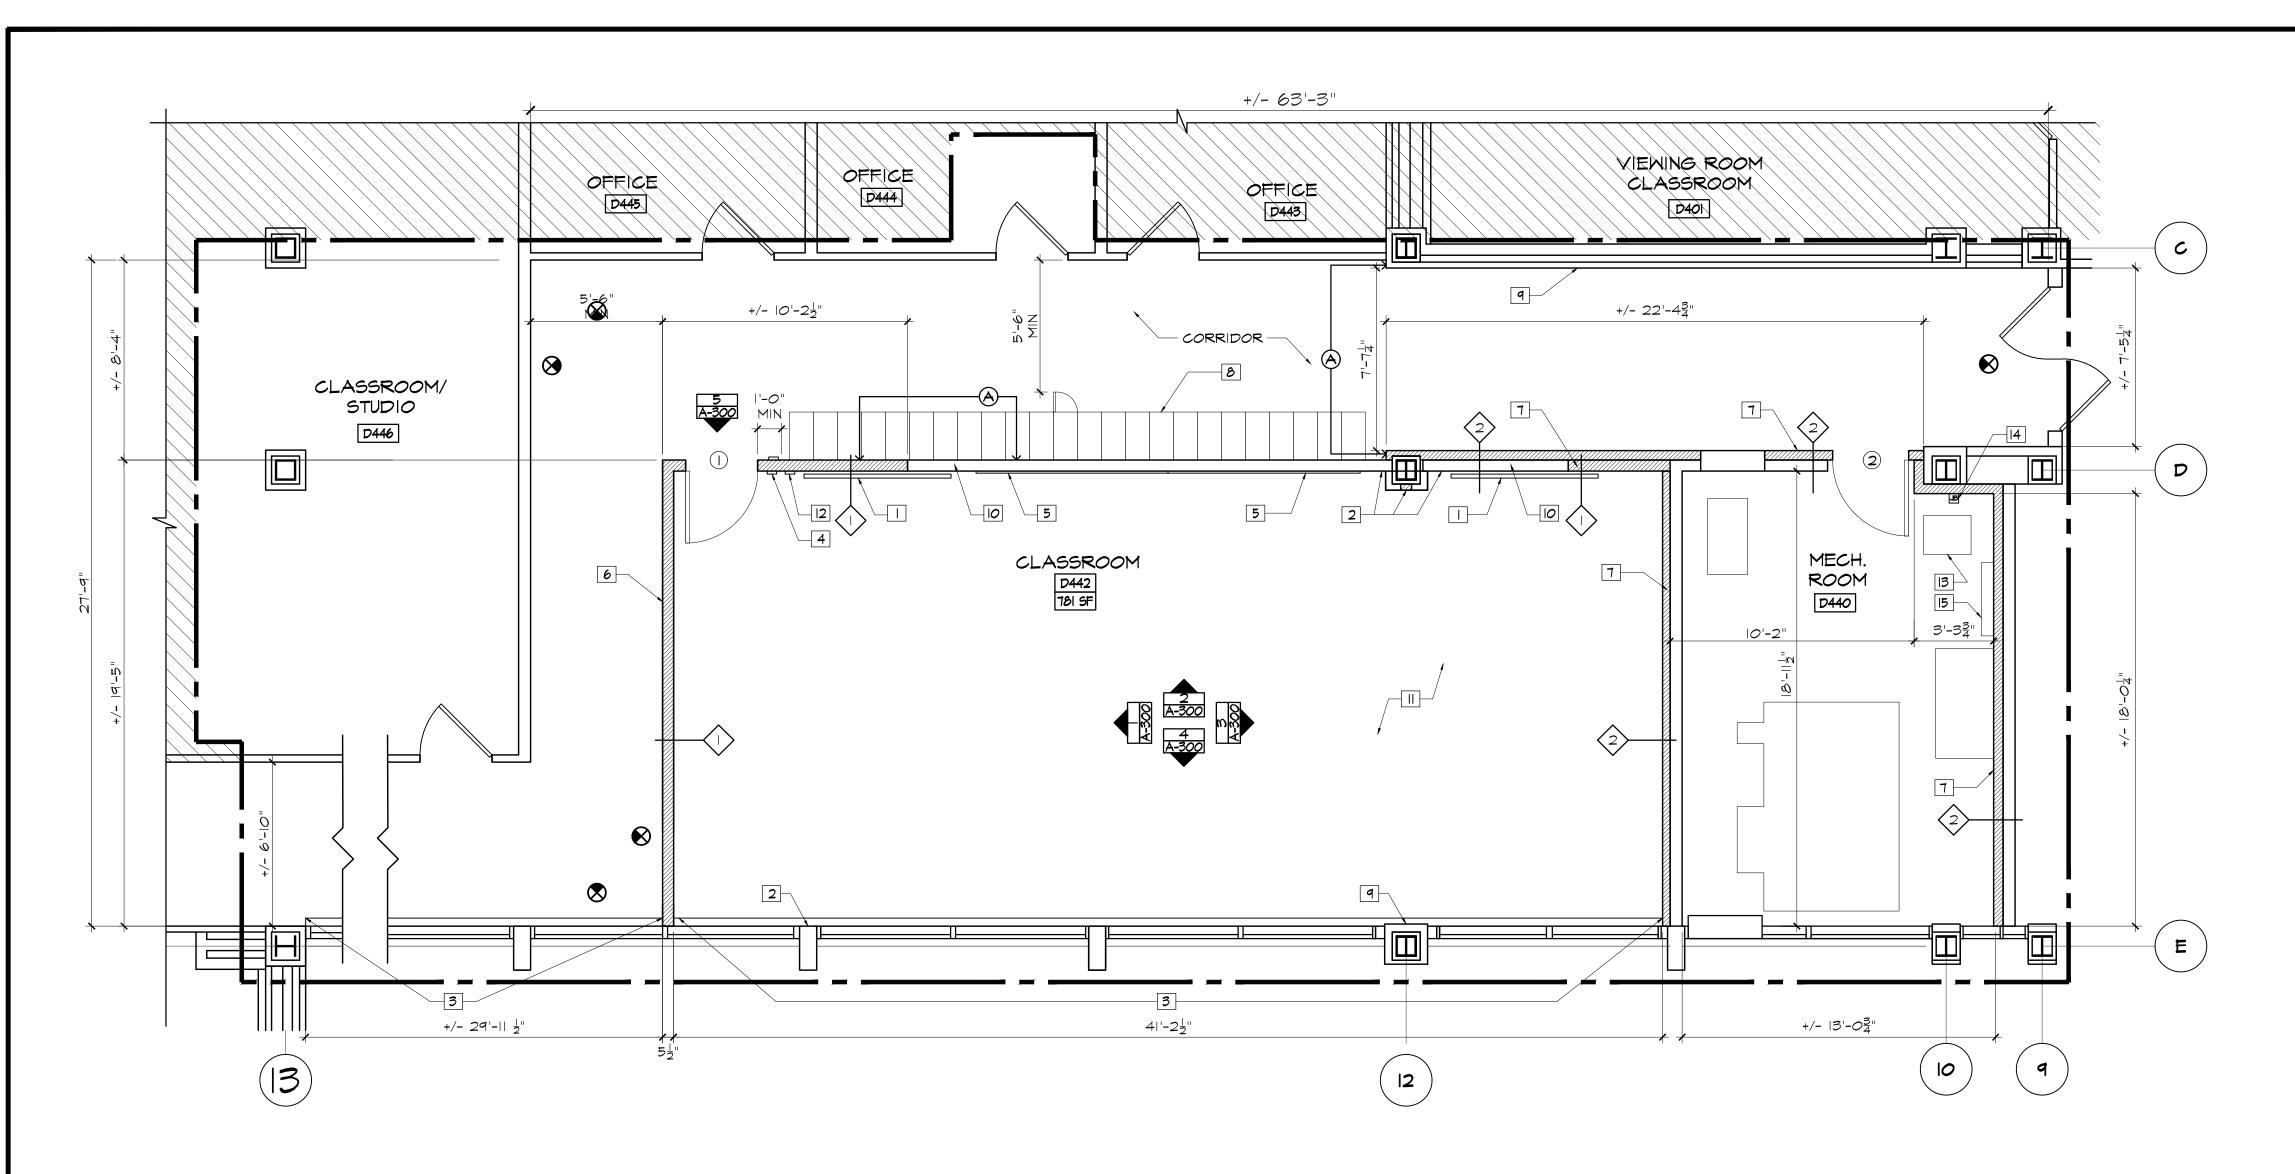

1 4TH FLOOR PLAN A-100 SCALE : 1/4" = 1'-0"

CONSTRUCTION PLAN NOTES

- I INSTALL TY MONITOR & PROVIDE BLOCKING AS REQ'D
- 2 PATCH EXISTING. FIRE-PROOFING AS REQUIRED
- 3 NEW FTR COVER POWDER COATED COLOR WHITE. SEE MECHANICAL DRAWINGS (TYP).
- 4 LIGHTING CONTROL
- 5 NEW CLARUS FLOAT MAGNETIC GLASS MARKER BOARD W/BOX TRAY & PROVIDE BLOCKING AS REQ'D
- 6 NEW GWB WALL. SEE DRAWING A-700 FOR PARTITION TYPES.

- 7 NEW 2-HR RATED SHAFT PARTITION FURRED-OUT, PROVIDE FIRE STOPPING AT ALL RATED WALL PENETRATIONS (TYP)

 8 RELOCATED 24 EXISTING LOCKERS. DISPOSE THE REMAINING 12

 9 EXIST. LIMESTONE PANEL TO BE PATCHED, PREP TO RECEIVE PAINT. SEE A-801 FOR FINISHES.
- PATCH EXIST. FIRE RATED WALL WHERE MECH. DUCTWORK HAS BEEN REMOVED USING WALL TYPE-I TO MATCH EXIST. WALL
- PATCH EXIST. QUARRY TILE FLOOR & INSTALL SELF LEVELING
- 12 NEW COURTESY TELEPHONE
- 13 REINSTALL EXIST. HEATER
- [4] EXIST. J-BOX TO BE RELOCATED POWERED ONTO NEW FURRED OUT WALL.
- 15 EXIST. TELEPHONE WIRING TO BE RELOCATED BY FIT

CONSTRUCTION NOTES:


I. MAINTAIN MIN 5'-6" WIDTH FOR CORRIDOR


CONSTRUCTION LEGEND EXISTING WALL TO REMAIN

NEW WALL

NEW DOOR & FRAME W/ DOOR NUMBER

rev. no. date revisions / 1 \ 06/29/2023 ADDENDUM #2

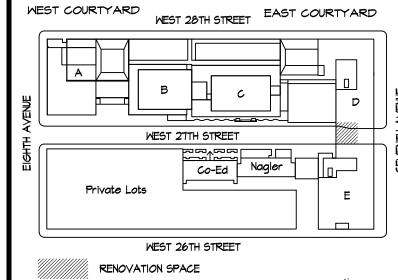

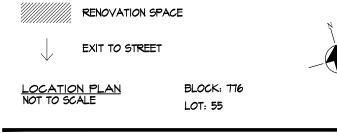

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DRAWING TITLE:

4H FLOOR PLAN


DEPARTMENT OF BUILDING JOB #

SEAL & SIGNATURE:

DATE: 6.7.2023 PROJECT No: 22320.3 DRAWING BY:MS/MH CHK BY: DH & CK

A-100.01

SCALE: AS NOTED | 5 of 12

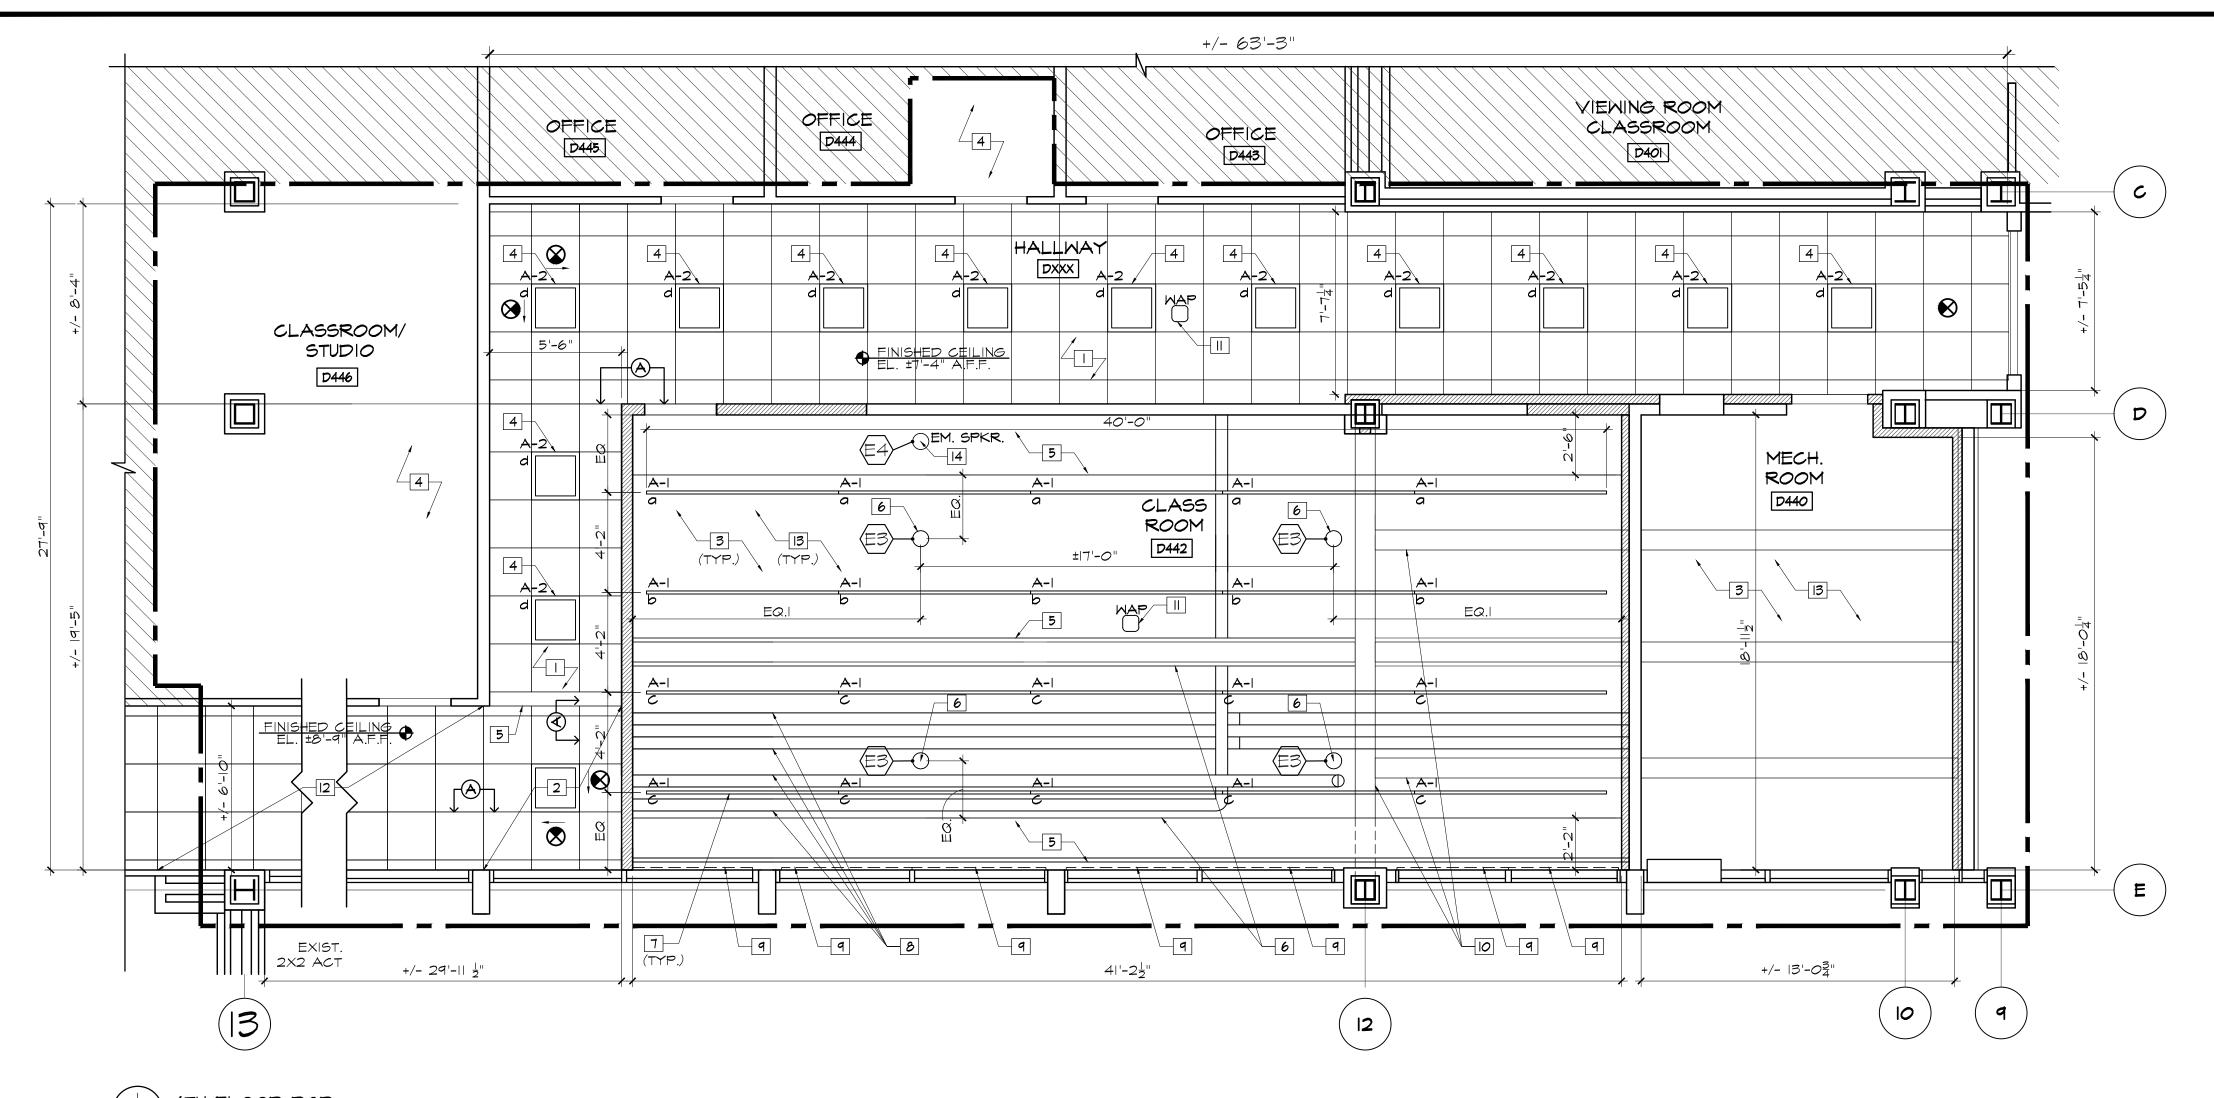

1 4TH FLOOR RCP A-400 SCALE : 1/4" = 1'-0"

REFLECTED CEILING PLAN NOTES

- NEW 2'X2' ACT CEILING WITH SUSPENSION SYSTEM, MATCH EXIST.
- 2 REINSTALL EXIST. 2'X2' ACT & LIGHTING
- 3 PATCH & PAINT UNDERSIDE OF THE EXIST. STRUCTURAL SLAB
- [4] REMOVE # INSTALL NEW CEILING TILES AS REQUIRED TO COMPLETE MECHANICAL WORK
- 5 NEW GWB SOFFIT
- 6 NEW PENDANT SPEAKER (TYP) SEE EQUIPMENT SCHEDULE ON DWG. A-800
- 7 NEW PENDANT LIGHT (TYP)
- 8 ALL EXIST. PLUMBING PIPING IN CEILINGS TO BE INSULATED & FINISHED W/ PVC JACKETTING (TYP)
- 9 NEW BLACK-OUT SHADES & POCKET COVER. PROVIDE BLOCKING AS REQ'D
- O PATCH, REPAIR & PAINT EXIST. CONCRETE BEAM (TYP)
- II WIRE ACCESS POINT (WAP)
- 12 EXIST. 2X2 ACT TO REMAIN
- 13 ACOUSTIC COTTON PANEL ECHO ELIMINATOR TO BE APPLIED TO UNDERSIDE OF SLAB
- 14 NEW EMERGENCY SPEAKER, SEE EQUIPMENT SCHEDULE ON DWG. A-800

LEGEND:

LINEAR LIGHTING

2X2 FIXTURE

CLG MOUNTED EXIT SIGN

WALL MOUNTED EXIT SIGN

WAP

CEILING MOUNTED WIRELESS ACCESS POINT

CEILING RECESSED EMERGENCY SPEAKER

RETURN AIR REGISTER

SUPPLY AIR REGISTER

ACCESS PANEL

RCP NOTES:

- I. REFER TO MECHANICAL DRAWINGS FOR HVAC EQUIPMENT INFORMATION. INCLUDING FIN TUBE COVERS
- 2. ALL WAP UNITS ARE TO BE COORDINATED WITH FIT IT.
- 3. REFER TO ELECTRICAL DRAWINGS FOR LIGHTING CONTROL
- 4. CONTRACTOR TO SUPPLY & INSTALL (8) 18"X18" GRFC ACCESS PANELS TAPED & SPACKLED INTO GMB SOFFIT. LOCATIONS TO BE COORDINATED IN THE FIELD.

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MEP Consultant

rev. no. date revisions

↑ 06/24/2023 ADDENDUM #2

WEST COURTYARD WEST 28TH STREET EAST COURTYARD

WEST 26TH STREET

BLOCK: T76 LOT: 55

RENOVATION SPACE

EXIT TO STREET

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D442 CLASSROOM RENOVATION POMERANTZ 300 7TH AVE NEW YORK NY 10001

DRAWING TITLE:

4TH FLOOR RCP # LIGHTING SCHEDULE

DEPARTMENT OF BUILDING JOB #

SEAL & SIGNATURE:

DATE: 6.7.2023 PROJECT No: 22320.3 DRAWING BY: MS/MH CHK BY: DH & CK

A-400.01

SCALE: AS NOTED 7 of 12


LIGHTING FIXTURE SCHEDULE

TYPE	FIXTURE DESCRIPTION	MANUFACTURER	LAMP QUANT	LAMP . TYPE	TOTAL WATTS	VOLTAGE	CONTROL	MTG HEIGHT	COMMENTS
Al	QUICKLINE LINEA 1.5" PENDANT DIRECT/INDIRECT	QUICKLINE QLPI-032	20	LED 3500K	108	UNV	0-10V DIM	8'-0" AFF	DIMMABLE, UP/DOWN LIGHT FEATURE INDIVIDUALLY CONTROLLED, 4 PRE-SET SETTINGS, SUSPENDED, WHITE FINISH, 8'-O" LENGTH
A2	EZPAN LOW-PROFILE LED PANEL 2'X2' EDGE-LIT PANELS.	RAB	12	LED 4000K	360	120V 50/60Hz	0-10V DIM	+/- 7'-4" AFF	DIMMABLE, RECESSED DRYWALL MOUNTED, MATCH EXIST.
*	UNO EDGELIT EXIT SIGN	ENCORE LIGHTING		LED				±8'-2" AFF	CLG MOUNTED SINGLE FACE CLEAR

Door Schedule


	DOC	DR .		DOC	DRS			FRAMES LABEL HARDWARE REMARKS				REMARKS	
#	FROM	TO	SIZE	THICK	MAT.	TYPE	MAT.	TYPE	JAMB	HEAD		SET	
	CORRIDOR	D442	3'-0"x7'-0"	1-3/4"	H.M./GLASS	I	H.M.		2A	ЗA	UL 45 MIN	l	FIRE RATED GLASS
(2	CORRIDOR	D440	3'-0"x7'-0"	1 3/4"	H.M.	Ш	H.M.	2	2B	3B	1.5 HR	2	

NOTES: I. ALL DIMENSIONS ARE TO MATCH EXISTING DOORS TO BE REMOVED. VERIFY ALL DIMENSIONS IN FIELD PRIOR TO FABRICATION.

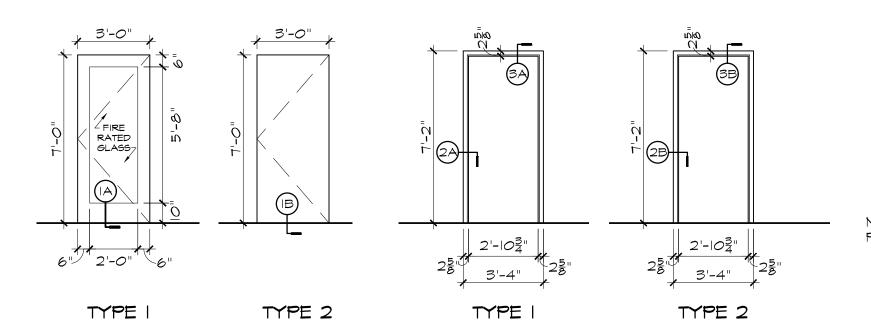




2 FRAME TYPE A-700 SCALE : 1/4" = 1'-0"

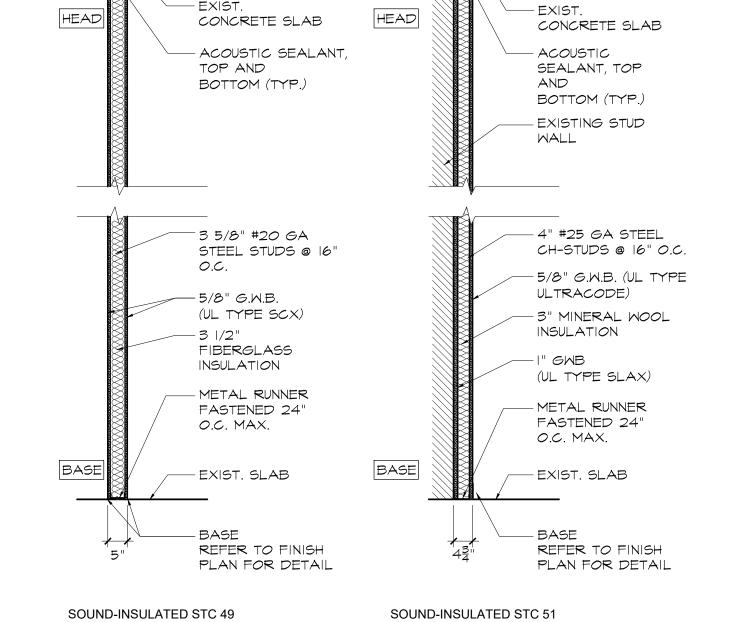


2-HR RATED PARTITION
UL DESIGN# U415




1-HR RATED PARTITION
UL DESIGN # U419

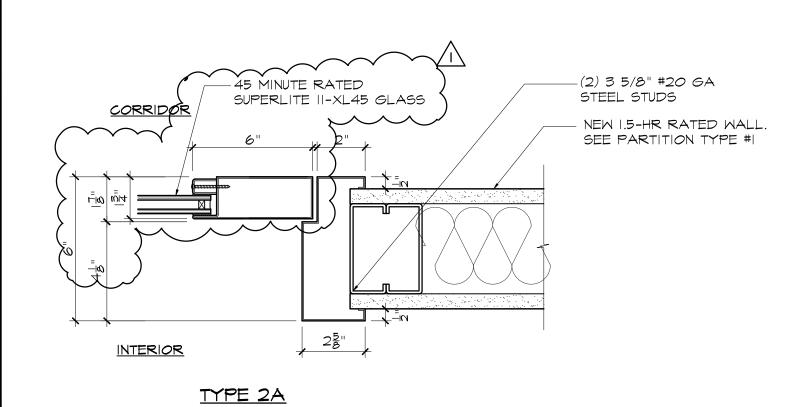


4 DOOR JAMB DETAIL A-100 SCALE : 3" = 1'-0"

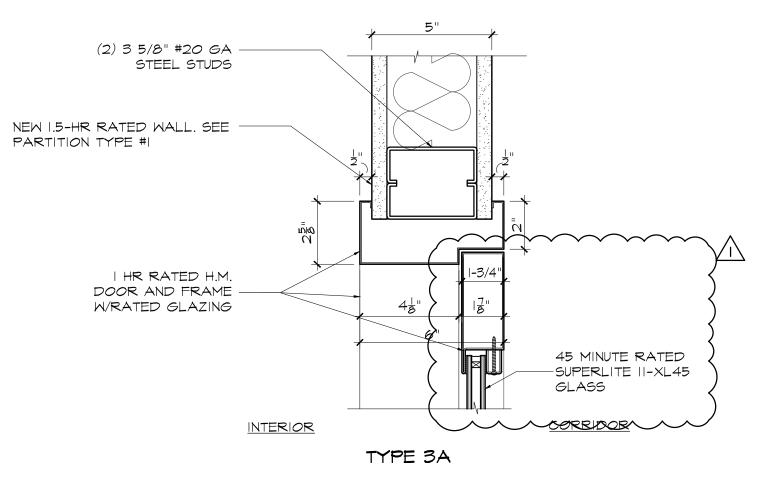


5 DOOR HEAD DETAILS A-100 SCALE : 3" = 1'-0"

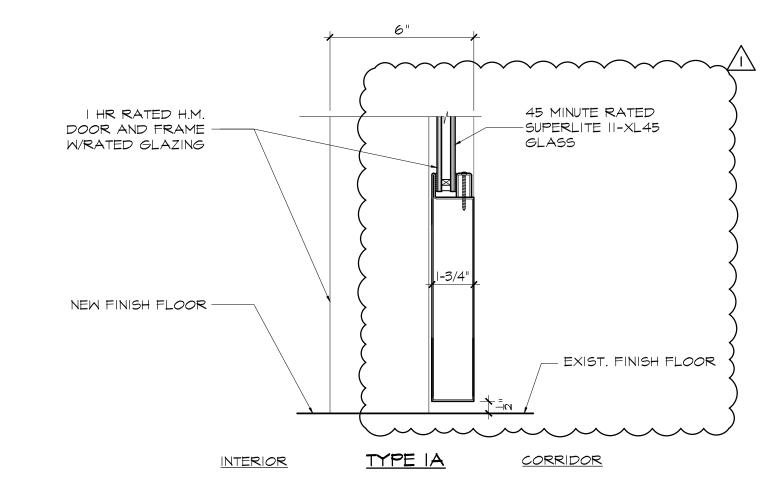

6 DOOR TYPES DETAILS A-700 SCALE : 3" = 1'-0"

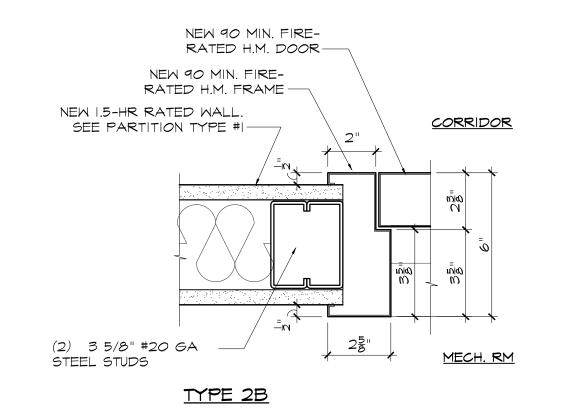



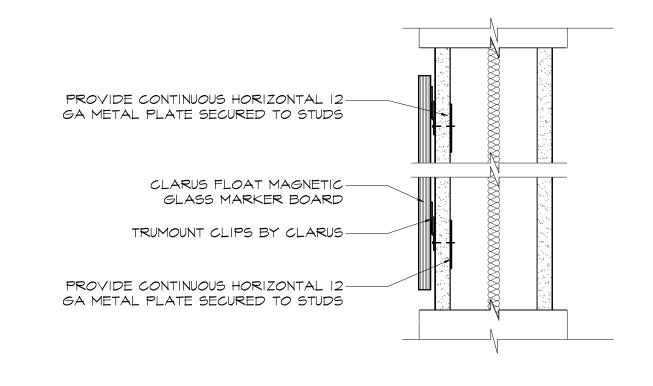

NEW 1.5-HR RATED WALL.-

(4) $3\frac{1}{2}$ " 20 GA STUDS-

NEW 90 MIN. FIRE-

NEW 90 MIN. FIRE-

RATED H.M. DOOR

INTERIOR

EXIST. FINISH FLOOR -

INTERIOR

<u>CORRIDOR</u>

-90 MIN. FIRE

RATED HOLLOW METAL DOOR


- EXIST. FINISH FLOOR

CORRIDOR

RATED H.M.FRAME

SEE PARTITION TYPE #

A-100 SCALE : 3" = 1'-0"

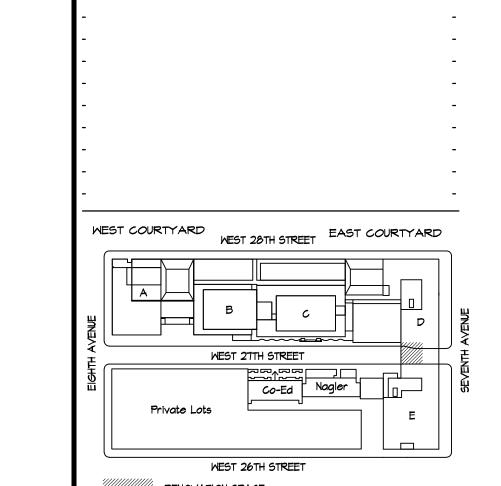

rev. no. date revisions

/ | 06/29/2023 ADDENDUM #2



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PROJECT:

D442 CLASSROOM RENOVATION POMERANTZ 300 7TH AVE NEW YORK NY 10001

DRAWING TITLE:

PARTITION &

DOOR SCHEDULE & DETAILS

DEPARTMENT OF BUILDING JOB #

SEAL & SIGNATURE:

DATE: 6.7.2023

PROJECT No: 22320.3

DRAWING BY: MS/MH

DRAWING BY: MS/MH
CHK BY: DH & CK
DWG No:

A-700.01

SCALE: AS NOTED 8 of 12

ADDR-"	SYMBOL	DESCRIPTION
ABBREV.	<u> </u>	DESCRIPTION
(E)	<u> </u>	EXISTING WORK TO REMAIN
	<u> </u>	NEW WORK
	\$ ////////// \$	EXISTING WORK TO BE REMOVED
	\$ \$	DIRECTION OF FLOW
		RETURN OR EXHAUST DUCT DOWN
		RETURN OR EXHAUST DUCT UP
		SUPPLY DUCT DOWN
		SUPPLY DUCT UP
MD	h WD h MD	MOTORIZED DAMPER
SD/AD, FD/AD,		FIRE & SMOKE DAMPERS WIACCESS DOOR
SD/AD		IN DUCT AT WALL ACOUSTICALLY LINED DUCT
		<u> </u>
	(SD)	DUCT MOUNTED SMOKE DETECTOR W/AD
	(CO2)	CARBON DIOXIDE SENSOR
	()	THERMOSTAT WITH DISPLAY
	(H)	HUMIDISTAT WITH DISPLAY
	•	CONNECT NEW TO EXISTING WORK POINT OF DISCONNECTION. CAP IF NOT TO
	—	BE RECONNECTED
TS	®	TEMPERATURE SENSOR
	, Џ	THERMOMETER
	Ş <u></u>	WATER PRESSURE GAUGE
	∑	STEAM PRESSURE GAUGE WITH SYPHON
AAV	, A	AUTOMATIC AIR VENT
CV	<u> </u>	TWO WAY CONTROL VALVE
	Ş————————————————————————————————————	THREE WAY CONTROL VALVE
	- 	BUTTERFLY VALVE
	<u> </u>	BUTTERFLY CONTROL VALVE
PSV	\$ \\\\\\\\\\\\\\\\\\\\\\\\\\\\\\\\\\\\	SAFETY RELIEF VALVE
		GATE VALVE / SHUT-OFF VALVE
	\$ 	GLOBE VALVE
	,	BALL VALVE
	Ş—— 	CHECK VALVE
	├	PLUG VALVE
	└─── ✓	COMBINATION FLOW MEASURING AND BALANCING VALVE
	├	NEEDLE VALVE
	\$\$	NEEDLE VALVE WITH BLOCK AND BLEED
	\\\\\\\\\\\\\\\\\\\\\\\\\\\\\\\\\\\\\\	STRAINER WITH CAPPED BLOW-DOWN VALVE
TDV	\$ <u>\$\tag{\tag{\tag{\tag{\tag{\tag{\tag{</u>	TRIPLE DUTY VALVE
	S	ECCENTRIC REDUCER
	>	UNION
	\$	CHILLED WATER RETURN CHILLED WATER SUPPLY
	\$ LPC ──\$	LOW PRESSURE CONDENSATE RETURN
	\$\$	LOW PRESSURE STEAM
	5 — cw — 5	COLD (CITY) WATER
	<u></u>	PIPE DOWN PIPE UP
		END CAP
		+

	ABBREVIATIONS
ABV AC	ABOVE AIR CONDITIONING
ACC AD	AIR COOLED CONDENSER ACCESS DOOR
AFF AFM	ABOVE FINISHED FLOOR AIR FLOW MEASURING STATION
AHU AL	AIR HANDLING UNIT ACOUSTIC LINING
APD ATC	AIR PRESSURE DROP AUTOMATIC TEMPERATURE CONTROL
BHP BG	BRAKE HORSEPOWER BOTTOM GRILLE
BMS BOD	BUILDING MANAGEMENT SYSTEM BOTTOM OF DUCT
BOP BR	BOTTOM OF PIPE BOTTOM REGISTER
BTU CAR	BRITISH THERMAL UNITS CONSTANT AIRFLOW REGULATOR
CD CFM CHWS/R	CONDENSATE DRAIN CUBIC FEET OF AIR PER MINUTE CHILLED WATER SUPPLY AND RETURN
CO COP	CLEANOUT COEFFICIENT OF PERFORMANCE
CR CT	CEILING REGISTER COOLING TOWER
CTE CW	CONNECT TO EXISTING DOMESTIC COLD WATER MAKE-UP
CWS/R DB	CONDENSER WATER SUPPLY AND RETURN DRY BULB (TEMPERATURE)
DDC DN	DIRECT DIGITAL CONTROL DOWN
DP DR	DIFFERENTIAL PRESSURE DRAIN
DWG E	DRAWING EXISTING
EAT EBH	ENTERING AIR TEMPERATURE ELECTRIC BASEBOARD HEATER
ELEV ESP	ELEVATION EXTERNAL STATIC PRESSURE
EUH EWT	ELECTRIC UNIT HEATER ENTERING WATER TEMPERATURE
FC FD	FLEXIBLE CONNECTION FIRE DAMPER
FSD FLA	COMBINATION FIRE/SMOKE DAMPER FULL LOAD AMPERES
FLR FOF	FLOOR FUEL OIL FILL
FOR FOS	FUEL OIL RETURN FUEL OIL SUPPLY
FOV FPM	FUEL OIL VENT FEET PER MINUTE
FT FTR	FEET HOT WATER FINNED TUBE RADIATION
GA GAL	GAUGE GALLONS
GPM GS/R	GALLONS PER MINUTE GLYCOL SUPPLY AND RETURN
HP HPWLS/R	HORSEPOWER HEAT PUMP LOOP SUPPLY AND RETURN
HWS/R HZ	HOT WATER SUPPLY AND RETURN HERTZ
KW LAT	KILOWATT LEAVING AIR TEMPERATURE
LBS LD	POUNDS LINEAR DIFFUSER
LRA LWT	LOCKED ROTOR AMPS LEAVING WATER TEMPERATURE
MAX MBH	MAXIMUM THOUSAND BRITISH THERMAL UNITS PER HOU
MCA MD	MINIMUM CIRCUIT AMPACITY MOTORIZED DAMPER
MER MFS	MECHANICAL EQUIPMENT ROOM MAXIMUM FUSE SIZE
MHP MIN	MOTOR HORSEPOWER MINIMUM
MOCP NC	MAXIMUM OVERCURRENT PROTECTION NORMALLY CLOSED
N/C NO	NOT IN CONTACT NORMALLY OPEN
NTS OA	NOT TO SCALE OUTSIDE AIR
OAI OED	OUTSIDE AIR INTAKE OPEN ENDED DUCT PRESSURE DROP
PD PH PRV	PHASE PRESSURE REDUCING VALVE
RG RL	RETURN GRILLE REFRIGERANT LIQUID PIPING
RLA RPM	RUNNING LOAD AMPS REVOLUTIONS PER MINUTE
RR RS	RETURN REGISER REFRIGERANT SUCTION PIPING
SD SEN	SMOKE DAMPER SENSIBLE
SG SR	SUPPLY GRILLE SUPPLY REGISTER
SPXF TG	SMOKE PURGE EXHAUST FAN TOP GRILLE
TO TR	TOP GRILLE TRANSFER OPENING TOP REGISTER
TRXF TSP	TOP REGISTER TRASH ROOM EXHAUST FAN TOTAL STATIC PRESSURE
TX TYP	TOTAL STATIC PRESSURE TOILET EXHAUST TYPICAL
UH UON	UNIT HEATER UNLESS OTHERWISE NOTED
V VAV	VENT VARIABLE AIR VOLUME
VD VFD	VOLUME DAMPER VARIABLE FREQUENCY DRIVE
VRF VRV	VARIABLE REFRIGERANT FLOW VARIABLE REFRIGERANT VOLUME
WB WC	WET BULB (TEMPERATURE) WATER COLUMN
WCC WMS	WATER COLOMIN WATER COOLED CONDENSER WIRE MESH SCREEN
WPD WT	WATER PRESSURE DROP WEIGHT

N.Y.C. BUILDING DEPARTMENT NOTES

- ALL WORK SHALL COMPLY WITH THE APPLICABLE SECTIONS OF THE BUILDING CODE, NEW YORK CITY, EFFECTIVE NOVEMBER 7, 2022 AND ALL AMENDMENTS AND RULES AND REGULATIONS OF THE DEPARTMENT OF BUILDINGS TO DATE, AND MATERIALS AND EQUIPMENT SUBJECT TO SPECIAL INSPECTION.
- THE FOLLOWING SPECIAL INSPECTIONS ARE REQUIRED BY THE NYC BUILDING CODE FOR HVAC SYSTEMS:
 - a) MECHANICAL SYSTEMS BC 1705.21
 - b) MECHANICAL AND ELECTRICAL COMPONENTS 1705.12.3 c) ENERGY CODE COMPLIANCE INSPECTIONS - BC 110.3.5
 - d) FINAL INSPECTIONS UNDER DIRECTIVE 14
- 3. THE FOLLOWING ENERGY CODE INSPECTIONS ARE REQUIRED BY THE NYC ENERGY CONSERVATION CODE FOR HVAC SYSTEMS:
 - a) VENTILATION AND AIR DISTRIBUTION SYSTEM (IB2)
 - b) HVAC-R AND SERVICE WATER HEATING EQUIPMENT (IB3), c) HVAC-R AND SERVICE WATER HEATING SYSTEM CONTROLS -
 - d) HVAC-R AND SERVICE WATER PIPING DESIGN AND
 - INSULATION (IB5), (IIB5) e) MAINTENANCE INFORMATION - (ID1), (IID1)
 - f) DUCT LEAKAGE TESTING, INSULATION AND DESIGN (IB6),
- 4. TEST OF MECHANICAL SYSTEMS SHALL BE PERFORMED IN ACCORDANCE WITH SECTION- MC 108 AND THE FOLLOWING SECTIONS OF THE NEW YORK CITY MECHANICAL CODE:
 - a) VENTILATION SYSTEM BALANCING MC 403.3.1.6
- 5. THE FOLLOWING WORK ITEMS, COMPONENTS, MATERIALS, CAPACITIES, ETC., SHALL COMPLY WITH THE FOLLOWING CODE REFERENCE.
 - a) TEMPERATURE CONTROL MC 309
 - b) NOISE CONTROL AND VIBRATION ISOLATION REQUIREMENTS
 - MC 313 c) DUCT CONSTRUCTION, SUPPORT - MC 603
 - d) FIRE DAMPERS AND SMOKE DAMPERS AND SMOKE **DETECTORS - MC 607**
- 6. 68 DEGREES F IS THE MINIMUM TEMPERATURE TO BE MAINTAINED IN OCCUPIED SPACES DURING HEATING SEASON
- VENTILATION FOR ALL AREAS SHALL COMPLY WITH MC 401
- UPON COMPLETION OF THIS VENTILATION SYSTEM, A TEST SHALL BE CONDUCTED IN THE PRESENCE OF AND DIRECTION OF A LICENSED PROFESSIONAL ENGINEER OR HAVING NOT LESS THAN FIVE (5) YEARS OF EXPERIENCE SUPERVISING INSTALLATION OF VENTILATING SYSTEMS. THE TEST SHALL SHOW COMPLIANCE WITH THE CODE REQUIREMENTS FOR VENTILATION AND THE PROPER FUNCTIONING OF ALL OPERATING DEVICES BEFORE THE SYSTEM IS APPROVED. THE LICENSED PROFESSIONAL ENGINEER OR REGISTERED ARCHITECT WHO CONDUCTS THE TESTS SHALL FILE A CERTIFICATE AS TO WHETHER THE SYSTEM COMPLIES WITH THE APPLICABLE LAWS. HE SHALL ALSO FILE WITH THE CERTIFICATION, A REPORT OF THE TEST, THE TEST AND REPORT SHALL BE MADE IN A MANNER SATISFACTORY TO THE SUPERINTENDENT. A STATEMENT SHALL BE FILED BY THE OWNER OR TENANT IN POSSESSION THAT THE SYSTEM WILL BE KEPT IN CONTINUOUS OPERATION AT ALL TIMES DURING NORMAL OCCUPANCY OF THE STRUCTURE AS PROVIDED IN THE APPLICABLE SECTIONS OF THE CODE. BASE BUILDING PLANS ARE FILED FOR SINGLE TENANT OCCUPANCY. ALL TENANT PLANS WILL BE FILED UNDER SEPARATE APPLICATIONS.
- ALL FIRE DAMPERS SHALL BE APPROVED BY THE NEW YORK CITY DEPARTMENT OF BUILDINGS AND SHALL BE MANUFACTURED AND INSTALLED IN ACCORDANCE WITH UL 555, STANDARD FOR FIRE DAMPERS AND CEILING DAMPERS.
- 10. REFER TO ARCHITECTURAL DRAWING FOR FIRE RATED WALL LOCATIONS AND RATED CONSTRUCTION.

NOTE

SYMBOLS AND ABBREVIATIONS LISTED IN THE TABLES ABOVE ARE TYPICAL FOR HVAC AIR AND WATER DISTRIBUTION SYSTEMS. NOT ALL OF LISTED SYMBOLS OR ABBREVIATIONS WERE USED IN THIS PROJECT.

GENERAL NOTES

- I. ANY EXISTING LEAD-BASED PAINT AREAS OF THE BUILDING WHERE THE CONTRACTOR AND ITS SUBCONTRACTORS ARE REQUIRED TO WORK SHALL BE MITIGATED PRIOR TO BEGINNING WORK. SUCH MITIGATION MAY INCLUDE FIT DIRECTING THE CONTRACTOR TO TAKE NECESSARY PRECAUTIONS AND WEAR PROTECTIVE GEAR TO WORK IN THE VICINITY OF THE LEAD PAINT. CONTRACTOR WILL NOT BE RESPONSIBLE FOR DELAYS CAUSED BY THE MITIGATION ACTIVITIES OR ANY ASSOCIATED COSTS.
- 2. ALL PIPING AND DUCTWORK SHALL BE SUSPENDED FROM BUILDING STRUCTURE ONLY, EXCEPT AS SPECIFICALLY ALLOWED IN THE SPECIFICATIONS. HVAC CONTRACTOR SHALL PROVIDE SUPPLEMENTARY STEEL AS NECESSARY TO SUPPORT PIPES AND DUCTS FROM BUILDING STRUCTURE. THE ARCHITECT AND STRUCTURAL ENGINEER SHALL BE THE SOLE DETERMINANT AS TO PERMISSIBILITY OF HANGING NEW WORK FROM BUILDING STRUCTURE AND SLABS.
- . PIPING AND DUCTWORK PROVIDED UNDER THIS CONTRACT SHALL BE COORDINATED UNDER THIS CONTRACT WITH WORK BEING PROVIDED BY OTHER TRADES.
- 4. WHILE THE DRAWINGS SHALL BE ADHERED TO AS CLOSELY AS POSSIBLE, THE ARCHITECT'S RIGHT IS RESERVED TO VARY THE RUN AND SIZE OF DUCTS DURING THE PROGRESS OF THE WORK IF REQUIRED TO MEET CEILING HEIGHTS, TO MEET STRUCTURAL AND FIELD CONDITIONS. CONTRACTOR SHALL PROVIDE REDRAWING OF SHOP DRAWINGS AS NECESSARY TO ACCOMMODATE THE ARCHITECT'S REQUIREMENTS, AT NO ADDITIONAL COST TO THE OWNER. REFER TO ARCHITECTURAL REFLECTED CEILING PLANS FOR REQUIRED CEILING HEIGHTS.
- 5. INSTALL ALL DUCTWORK IN STRICT ADHERENCE TO THE CEILING HEIGHTS INDICATED ON THE ARCHITECT'S DRAWINGS. CONSULT WITH OTHER CONTRACTORS AND IN CONJUNCTION WITH THE OTHER CONTRACTORS, ESTABLISH THE NECESSARY SPACE REQUIREMENTS FOR EACH TRADE.
- 6. 6. THE SHEET METAL DUCTWORK SHALL, WHETHER INDICATED OR NOT, RISE AND/OR DROP AND/OR CHANGE IN SHAPE TO CLEAR ANY AND ALL OTHER DUCTWORK, CONDUITS, LIGHTING FIXTURES, PLUMBING AND HEATING/COOLING MAINS TO MAINTAIN THE DESIRED CEILING HEIGHTS AND TO PROVIDE ADEQUATE MAINTENANCE ROOM AND HEADROOM IN MECHANICAL EQUIPMENT ROOMS. THE DRAWINGS, IN GENERAL, DO NOT SHOW ALL RISES, DROPS AND DUCT TRANSITIONS REQUIRED. THE DRAWINGS SHOW GENERAL ROUTING REQUIREMENTS ONLY.
- 7. ALL RECTANGULAR DUCTWORK, UNLESS OTHERWISE NOTED, SHALL BE BUILT FROM GALVANIZED SHEET STEEL AND THOROUGHLY BRACED AND STIFFENED.
- 8. PROVIDE 12" x 12" ACCESS DOORS EVERY 50'-0" RUN OF SUPPLY AND RETURN AIR DUCT FOR CLEANING PURPOSES, EXCEPT IN DUCT ABOVE SOUND CONTROL CEILING. PROVIDE 18" x 18" ACCESS DOORS UPSTREAM AND DOWNSTREAM OF EACH REHEAT COIL, AT EACH FIRE AND FIRE/SMOKE DAMPER, AT EACH MOTORIZED DAMPER. AT EACH CV AND VAV TERMINAL BOX AND WHEREVER ELSE INDICATED IN THE SPECIFICATION. IF THE DUCT IS TOO SMALL TO PROVIDE AN 18" x 18" ACCESS DOOR, A 12" x 12" ACCESS DOOR SHALL BE PROVIDED. SEE SPECIFICATIONS FOR ADDITIONAL ACCESS DOOR REQUIREMENTS.
- 9. SEE SPECIFICATION FOR DUCTS REQUIRED TO BE ACOUSTICALLY LINED. DIMENSIONS GIVEN ON PLANS ARE INSIDE CLEAR DIMENSIONS. INCREASE SIZE OF SHEET METAL DUCT TO PROVIDE THE SPECIFIED INSIDE CLEAR DIMENSION WITH ACOUSTICAL LINING
- 10. PROVIDE ISOLATION VALVES WHERE TYING NEW PIPING INTO THE EXISTING SYSTEM. REFER TO THE VALVES SPECIFICATIONS FOR THE PROPER VALVE TYPE FOR THE SERVICE. REFER TO THE DRAWINGS FOR THE PIPE/VALVE SIZE. IN ADDITION TO THE ISOLATION VALVES AT THE TIE-IN POINTS, ALSO PROVIDE A BALANCING VALVE ON THE SUPPLY SIDE FOR CHILLED WATER. CHILLED GLYCOL/BRINE. CONDENSER WATER AND HEATING/REHEAT HOT WATER SYSTEM TIE-INS.
- 11. SYMBOLS AND ABBREVIATIONS SHOWN ON THE DRAWINGS ARE FOR MECHANICAL DRAWINGS ONLY. SEE OTHER TRADES DRAWINGS FOR THEIR RESPECTIVE SYMBOLS AND ABBREVIATIONS.
- 12. PRIOR TO PERFORMING ANY CORE DRILLING OR CUTTING OF EXISTING FLOOR OR ROOF SLAB. CONTRACTOR SHALL PERFORM A SCAN OF THE SLAB USING GROUND PENETRATING RADAR (GPR) TO CONFIRM THAT THERE ARE NO EXISTING CONDUITS OR PIPES IN THE AREA OF CORE DRILL OR CUTTING OF THE SLAB.

PROJECT DATA LOCATION: 300 7TH AVENUE NEW YORK, NY 10001 PROPERTY IS NOT LOCATED IN SPECIAL FLOOD HAZARD AREA.

DEMOLITION NOTES

- DEMOLITION OF HVAC ITEMS SHALL BE PERFORMED UNDER THE HVAC
- LOCATION OF THE EXISTING DUCTWORK & PIPING AS SHOWN ON DRAWINGS IS APPROXIMATE.
- PROVIDE TEMPORARY SUPPORTS WHERE REQUIRED.
- DURING DEMOLITION, PROPERLY CAP AND PROTECT ALL DUCTWORK, EQUIPMENT, AND PIPING THAT WILL REMAIN IN OPERATION.
 - WHERE EXISTING INSULATION TO REMAIN IS DAMAGED BY THE REQUIREMENTS OF THE WORK, REPLACE ANY DAMAGED INSULATION TO MATCH EXISTING.
- DEMOLISH ALL EQUIPMENT AS INDICATED, FIXTURES AND/OR MISCELLANEOUS ARTICLES IN THEIR ENTIRETY INCLUDING AUXILIARY EQUIPMENT, PIPING, WIRING, CONDUIT AND DUCTWORK. DEMOLITION WORK SHALL BE PERFORMED BY WORKMEN EXPERIENCED IN THIS TYPE OF WORK AND SHALL BE CARRIED THROUGH TO COMPLETION WITH DUE REGARDS TO THE SAFETY OF ALL BUILDING OCCUPANTS AND THE EMPLOYEES OF THE CONTRACTOR WITH AS LITTLE DISTURBANCE AS
- MATERIALS RESULTING FROM THE DEMOLITION OPERATIONS SHALL NOT BE ALLOWED TO ACCUMULATE ON THE FLOORS AND ROOF SURFACES, EXTERIOR GRADE SURFACES OR OTHER PARTS OF THE PREMISES, AND SHALL BE PROMPTLY REMOVED AND DISPOSED OF AWAY FROM THE PREMISES.
- INCLUDE ALL DEMOLITION OF SYSTEMS AND COMPONENTS WHERE SYSTEMS SHALL BE REPLACED BY NEW WORK. REFER TO THE DRAWINGS AND SPECIFICATIONS FOR THE SCOPE OF NEW AND RECONNECTED WORK. THE INTENT OF THIS REQUIREMENT IS TO HAVE THE CONTRACTOR DISCONNECT, DEMOLISH AND REMOVE ALL EXPOSED AND CONCEALED WORK WHERE BEING REPLACED OR CONNECTED TO THE NEW LAYOUTS.
- COORDINATE ELECTRICAL POWER DISCONNECTION PRIOR TO DEMOLITION WITH ELECTRICAL CONTRACTOR.
- 10. PROTECT ALL HVAC WORK AND WORK OF OTHER TRADES WHICH IS TO REMAIN, FROM DAMAGE DURING DEMOLITION.
- ALL PIPING AND DUCTWORK TO REMAIN SHALL HAVE ENDS TERMINATED IN A NEAT MANNER READY FOR CONNECTION OF NEW WORK. ALL EXPOSED ENDS OF PIPING AND DUCTWORK SHALL BE CAPPED. SCREWED PIPING SHALL END ON A SCREWED JOINT. FLANGED PIPE SHALL END WITH A FLANGED JOINT. WELDED PIPING SHALL BE MECHANICALLY CUT, CLEANED OF BURRS AND A CAP WELDED TO THE PIPE. DUCTWORK SHALL BE CAPPED WITH SHEET METAL CONNECTED TO THE DUCT TO REMAIN.
- REMOVAL OF EQUIPMENT, PIPING AND DUCTWORK SHALL INCLUDE ALL HANGERS & SUPPORT ASSOCIATED WITH THE EQUIPMENT, PIPING AND DUCTWORK TO BE REMOVED.

SCOPE OF WORK

- RENOVATION OF CLASSROOM D442 INCLUDES INSTALLATION OF NEW
- DEMOLITION OF EXISTING SECURITY OFFICES D441 & D442 INCLUDES DEMOLITION OF EXISTING RETURN AND SUPPLY DUCTWORK.

DRAWING LIST

M-001.00 MECHANICAL SYMBOLS, ABBREVIATIONS, NOTES AND DRAWING LIST M-104.00 FOURTH FLOOR MECHANICAL PLAN M-501.00 MECHANICAL DETAILS

M-701.00 MECHANICAL SCHEDULES M-801.00 MECHANICAL CONTROL DIAGRAMS

M-904.00 FOURTH FLOOR MECHANICAL DEMOLITION PLAN

/ ¹ \ 06/29/23 ISSUED FOR ADDENDUM #2 WEST 28TH STREET WEST 27TH STREET Co-Ed Nagler WEST 26TH STREET RENOVATION SPACE EXIT TO STREET BLOCK: 776 LOT: 55

rev. no. date revisions

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D442 CLASSROOM RENOVATION POMERANTZ 300 7TH AVE NEW YORK NY 10001

DRAWING TITLE:

MECHANICAL SYMBOL LIST, ABBREVIATIONS, NOTES AND DRAWING LIST

DEPARTMENT OF BUILDING JOB #

SEAL & SIGNATURE:

116 West 32nd Street, 12th Floor, New York, N.Y. 10001

DATE: 06.07.2023 PROJECT No: 22320,3 DRAWING BY: AB CHK BY: DN

SCALE: NTS


M-001.00

NEW YORK CITY BUILDING DEPARTMENT APPROVAL NOTE

THIS PLAN IS APPROVED ONLY FOR WORK INDICATED ON THE APPLICATION SPECIFICATION SHEET. ALL OTHER MATTERS SHOWN ARE NOT TO BE RELIED UPON. OR TO BE CONSIDERED AS EITHER BEING APPROVED OR IN ACCORDANCE WITH APPLICABLE CODES.

TO THE BEST OF MY KNOWLEDGE, BELIEF AND PROFESSIONAL JUDGMENT, THESE PLANS AND SPECIFICATIONS ARE IN COMPLIANCE WITH THE 2020 NEW YORK CITY ENERGY CONSERVATION CODE.

NEW YORK CITY ENERGY CONSERVATION CODE

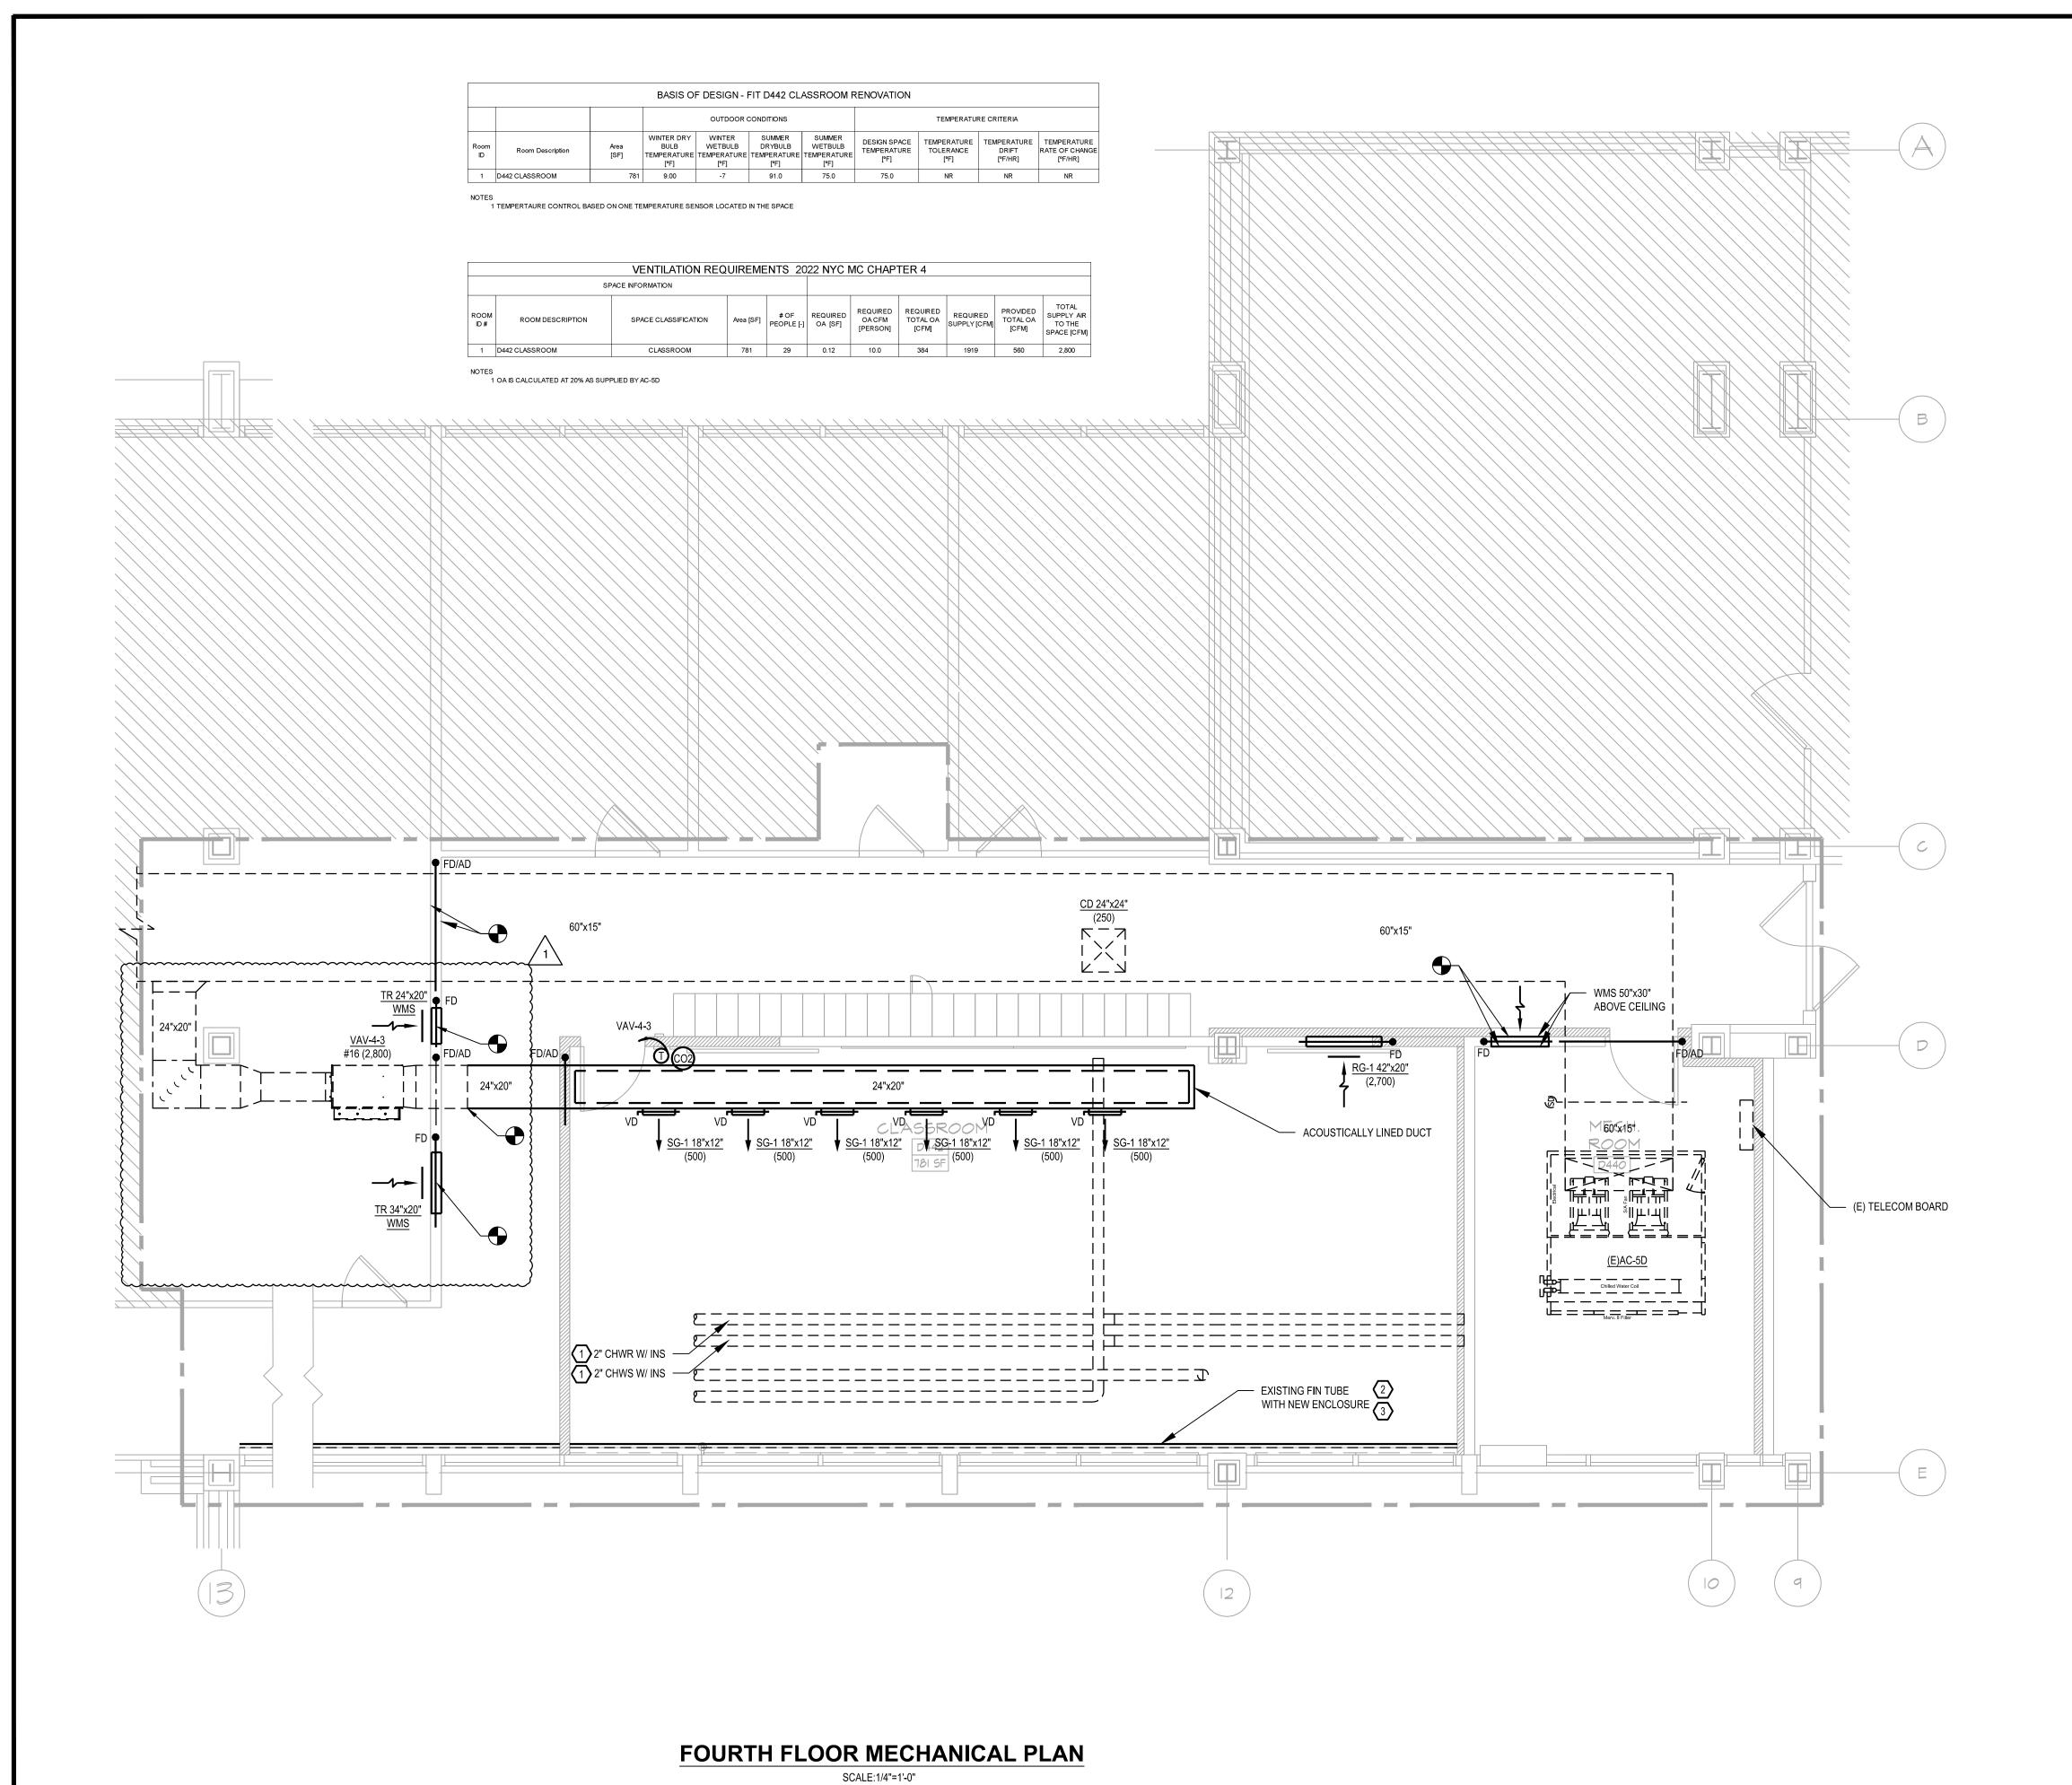

WORK NOTES:

- ADD PVC JACKET FOR 2" CHW WITH INSULATION EXPOSED INSIDE CLASSROOM D442
- REPLACE EXISTING FIN TUBE RADIATION
 ENCLOSURE WITH NEW FIN TUBE RADIATION ENCLOSURE
 ALONG THE WINDOWS UP TO COLUMN #13
- VACUUM CLEAN THE EXISTING FIN TUBE RADIATION
 ELEMENTS ALONG THE WINDOWS UP TO COLUMN #13
 BEFORE INSTALLING THE NEW ENCLOSURE

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\ 06/29/23 ISSUED FOR ADDENDUM #2

WEST 26TH STREET

BLOCK: 176 LOT: 55

RENOVATION SPACE

EXIT TO STREET

WEST 28TH STREET EAST COURTYARD

116 West 32nd Street

New York, NY 10001 / (212) 643-9898

Fashion Institute of Technology 340 8TH AVENUE NEW YORK, NY 10001

David Smotrich & Partners LLP Architects/Planners

Fax 212 889 3672

443 Park Avenue South New York, NY 10016

212 889 4045

PROJECT:

D442 CLASSROOM RENOVATION POMERANTZ 300 1TH AVE NEW YORK NY 10001

DRAWING TITLE:

FOURTH FLOOR MECHANICAL PLAN

DEPARTMENT OF BUILDING JOB #

M00896064-II

SEAL & SIGNATURE:

DATE: 06.07.2023
PROJECT No: 22320.3
DRAWING BY: AB
CHK BY: DN

DWG No:

M-104.00

SCALE: NTS 2 OF 6

M6 iEngineerinīg DcPn Q. oʻwe gingirseer Quorens 116 West 32nd Street, 12th Floor, New York, N.Y. 10001 P 212.643.9055 www.nggadp.comet

NEW YORK CITY BUILDING DEPARTMENT NOTE
THIS PLAN IS FOR ECC SCOPE AND APPROVAL ONLY.


(NOTE IS APPLICABLE ONLY TO NYC DOB REVIEW PROCESS. CONTRACTOR MUST PROVIDE ALL WORK SHOWN ON PLAN)

NEW YORK CITY BUILDING DEPARTMENT APPROVAL NOTE

THIS PLAN IS APPROVED ONLY FOR WORK INDICATED ON THE APPLICATION SPECIFICATION SHEET. ALL OTHER MATTERS SHOWN ARE NOT TO BE RELIED UPON, OR TO BE CONSIDERED AS EITHER BEING APPROVED OR IN ACCORDANCE WITH APPLICABLE CODES

SCALE: 1/4" = 1'-0"

ISSUED FOR ADDENDUM #2 06.29.2023

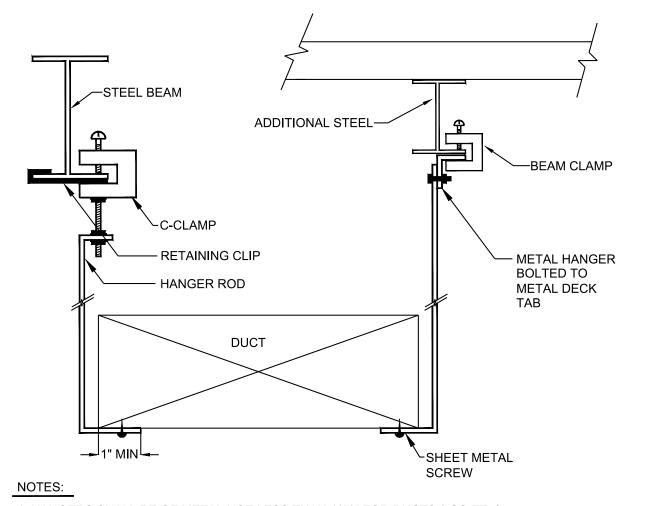


- 1. HANGERS SHALL BE OF METAL NOT LESS THAN 1/16" FOR DUCTS 2 SQ.FT. & LESS, AND NOT LESS THAN 1/8" FOR DUCTS LARGER THAN 2 SQ.FT.
- 2. WHERE CROSS-SECTIONAL AREA OF DUCT EXCEEDS 8 SQ.FT., HANGERS SHALL BE SPACED NOT MORE THAN 4 FT. ON CENTERS. 3. C-CLAMP FOR DUCTS UP TO 36" MAXIMUM DIMENSION.

DUCT SUPPORT ATTACHMENT TO STRUCTURE

[DUCT S	SUF	PPORT	sc	CHEDU	JLE		
HALF OF	PAIR AT 10 FT. SRACII	NG	PAIR AT 8 FT. SRACIN	IG	PAIR AT 5 FT. SRACIN	lG	PAIR AT 4 FT. SRACIN	IG
DUCT PERIMETER	STRAP	WIRE/ ROD	STRAP	WIRE/ ROD	STRAP	WIRE/ ROD	STRAP	WIRE/ ROD
30"	1" x 22 GA	10 GA (.135")	1" x 22 GA	10 GA (.135")	1" x 22 GA	12 GA (.135")	1" x 22 GA	12 GA (.135")
72"	1" x 18 GA	3/8"	1" x 20 GA	1/4"	1" x 22 GA	1/4"	1" x 22 GA	1/4"
96"	1" x 16 GA	3/8"	1" x 18 GA	3/8"	1" x 20 GA	3/8"	1" x 22 GA	1/4"
120"	1Ô" x 16 GA	1/2"	1" x 16 GA	3/8"	1" x 18 GA	3/8"	1" x 20 GA	1/4"
168"	1Ô" x 16 GA	1/2"	1Ô" x 16 GA	1/2"	1" x 16 GA	3/8"	1" x 18 GA	3/8"
192"	-	1/2"	1Ô" x 16 GA	1/2"	1" x 16 GA	3/8"	1" x 16 GA	3/8"
1		1	l			1		1

DUCT SUPPORT SCHEDULE

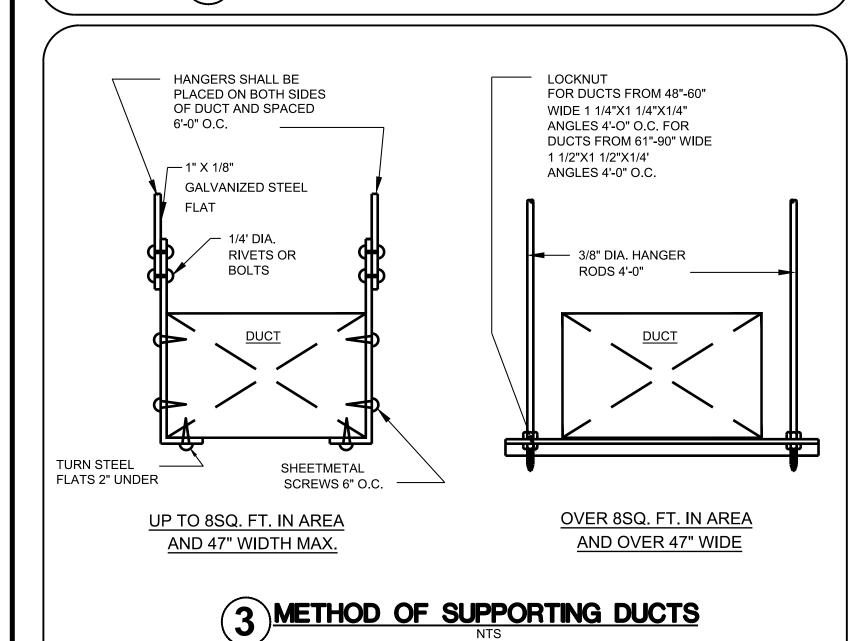

ENCLOSURE -

WALL TO WALL

AIR VENT —

HOT WATER RETURN —

— BALANC**I**NG VALVE

- CONTROL VALVE

ELEMENT ACTIVE LENGTH

(SEE PLANS FOR LENGTH)


FINNED TUBE RADIATION DETAIL


GATE VALVE —

- IN FURRED CHASE,


— HOT WATER SUPPLY

WALL OR COLUMN

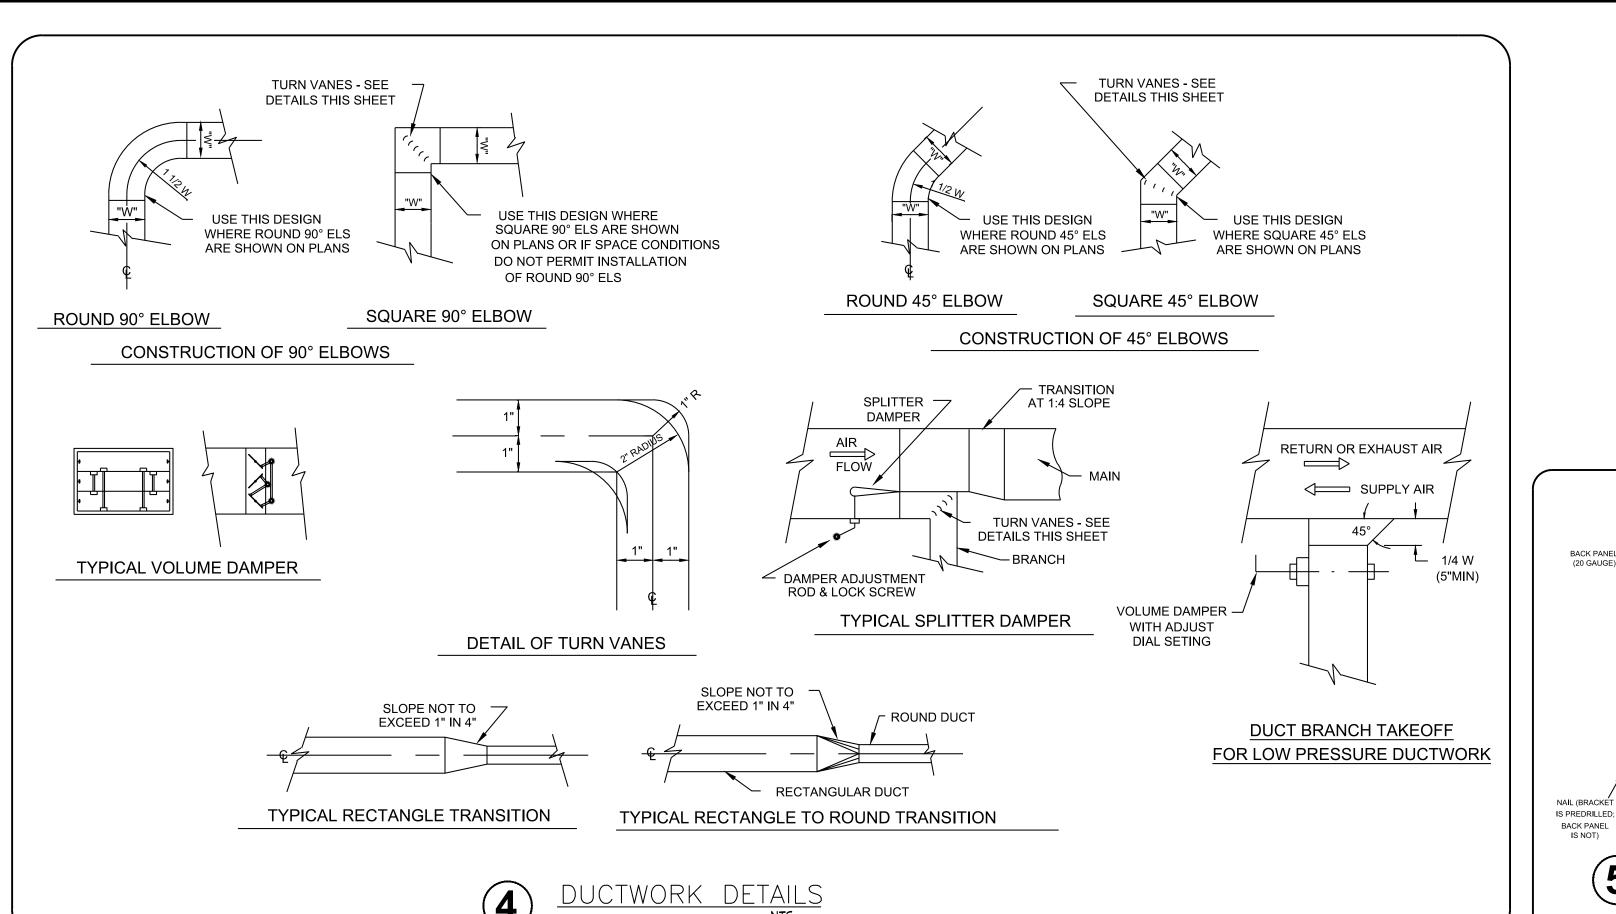

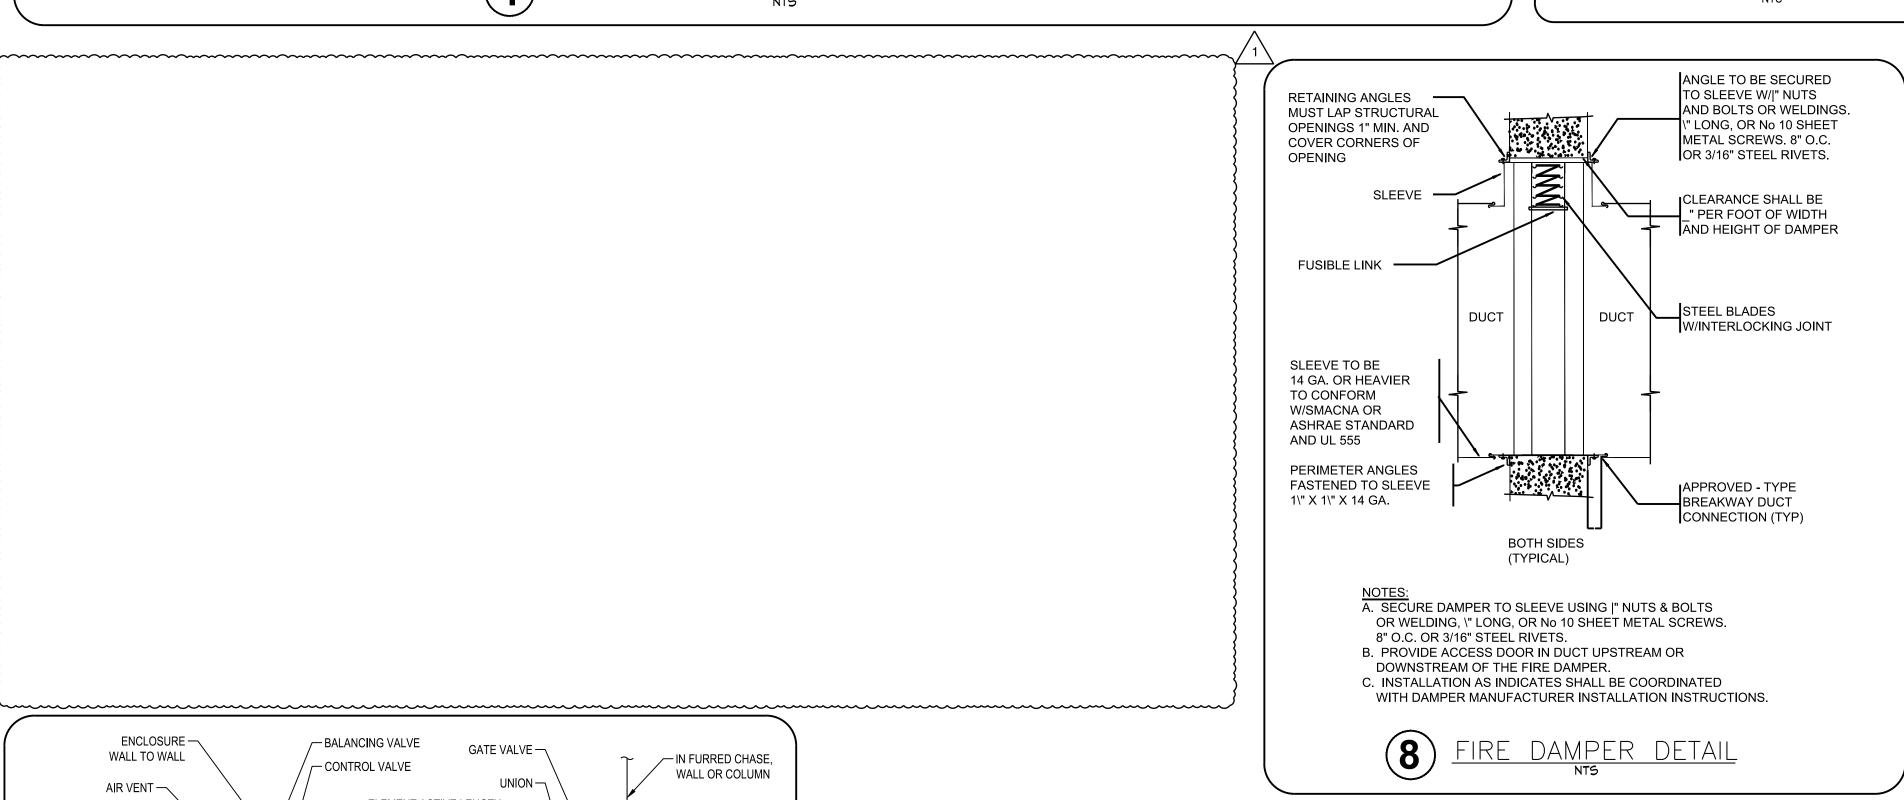

FINNED TUBE RADIATION **ENCLOSURE DETAIL**

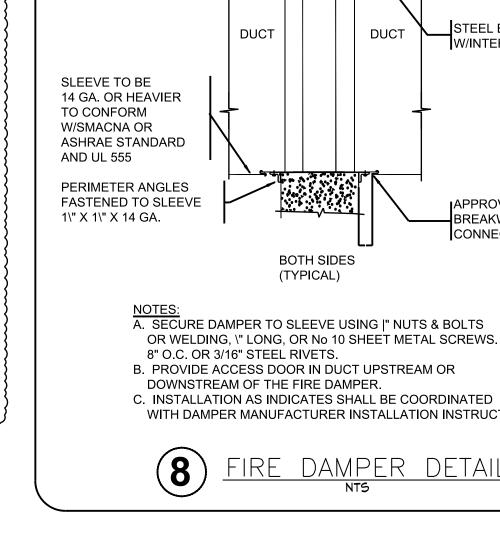



UPON, OR TO BE CONSIDERED AS EITHER BEING APPROVED OR IN ACCORDANCE





M-501.00

SCALE: NTS

rev. no. date revisions

		AIF	ROUTLET	SCHEDUL	E		"TITU	S" AS STANE	TANDARD								
MARK	SERVICE	CFM	SIZE (IN.)	TOTAL PRESSURE DROP (Pt) AT MAX FLOW (IN. WC)	SOUND LEVEL (NC)	DAMPER STYLE	BORDER TYPE	MANUFACTURER	MODEL	NOTES							
SG-1	SUPPLY	500	18X12	0.016	12	NONE	DUCT MOUNTED	TITUS	112RL 18X12	SEE NOTES							
RG-1	RETURN	2700	42X20	0.087	39	NONE	DUCT MOUNTED	TITUS	23RL 42X20	SEE NOTES							

1. ALL DIFFUSERS & DAMPERS TO BE PER SCHEDULE. PROVIDE WHITE COLOR AND COORDINATE WITH ARCHITECTURAL DRAWINGS FOR COLOR FINISHING.

2. ALL DIFFUSERS TO BE STANDARD FACTORY POWDER COATED. PROVIDE CONCEALED FASTENERS FOR ALL AIR OUTLETS. 3. COORDINATE WITH THE ARCHITECTURAL DRAWINGS.

		FIN TU	BE RAD	IATION	ENCLOS	SURE SCH	EDULE				
GENERAL DATA			ELEME	NT						ENCLOSURE	
UNIT NO	LENGTH [FT]	FIN SIZE	FIN MATERIAL	PIPE MATERIAL	NO OF FINS PER FT.	NO OF ROWS	AVG WATER TEMP [F]	EAT [F]	BTU/H PER LINEAR FT.	HEIGHT	REMARKS
F-1	AS NOTED IN DRAWING	EXISTING	ALUMINUM	COPPER	EXISTING	EXISTING	EXISTING	EXISTING	EXISTING	SEE NOTE 5	SEE NOTES


1. 18 GAUGE ENCLOSURE. COORDINATE WITH ARCHITECT FOR THE COLOR FINISHING.

2. THE ENCLOSURE SHALL BE FACTORY POWDER COATED. 3. 20 GAUGE FULL BACK PANEL, PRIME COATED FOR MOUNTING

4. 16 GAUGE GALVANIZED FOR HANGERS WITH FIN CLIP SLIDER AND LINEAR EXPANSION FOR QUIET OPERATION

5. EXISTING HEIGHT TO BE VERIFIED IN FIELD BY CONTRACTOR.

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Architects/Planners

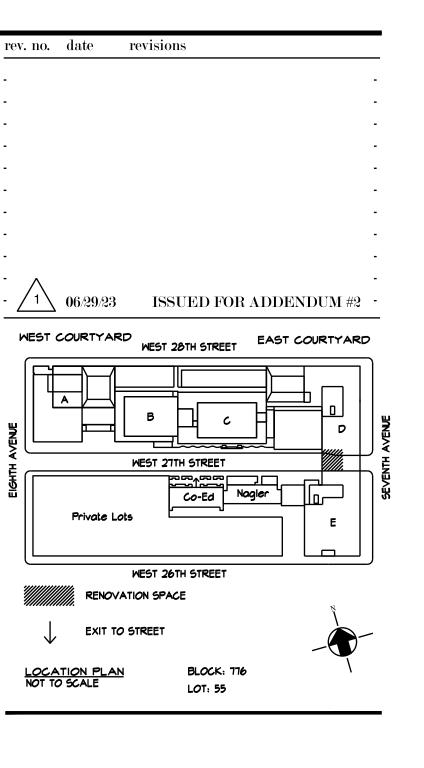D442 CLASSROOM RENOVATION POMERANTZ 300 7TH AVE NEW YORK NY 10001

DRAWING TITLE:

MECHANICAL SCHEDULES

DEPARTMENT OF BUILDING JOB #

SEAL & SIGNATURE:

DATE: 06.07.2023 PROJECT No: 22320.3 DRAWING BY: AB CHK BY: DN

M-701.00


SCALE: NTS

4 OF 6

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NEW YORK CITY ENERGY CONSERVATION CODE



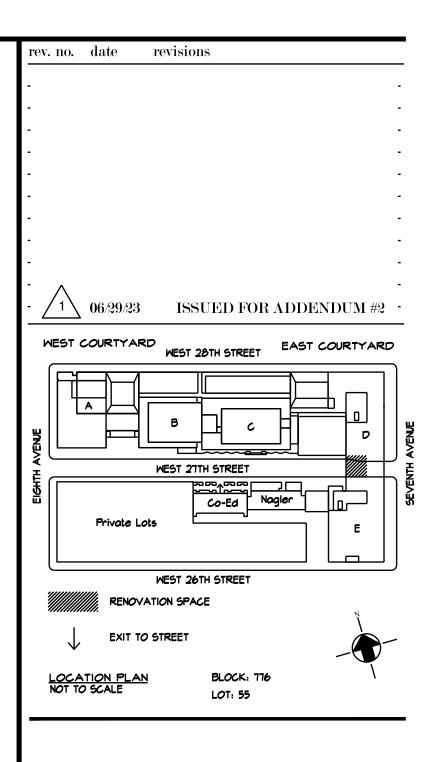

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DIAGRAMS

D442 CLASSROOM RENOVATION POMERANTZ 300 7TH AVE NEW YORK NY 10001

DRAWING TITLE: MECHANICAL CONTROL

DEPARTMENT OF BUILDING JOB #

MO0896064-11


SEAL & SIGNATURE:

DATE: 06.07.2023 PROJECT No: 22320.3 DRAWING BY: AB CHK BY: DN M-801.00

SCALE: NTS

5 OF 6

NEW YORK CITY ENERGY CONSERVATION CODE TO THE BEST OF MY KNOWLEDGE, BELIEF AND PROFESSIONAL JUDGMENT, THESE PLANS AND SPECIFICATIONS ARE IN COMPLIANCE WITH THE 2020 NEW MG Engineering D.P.C. / we engineer success 116 West 32nd Street, 12th Floor, New York, N.Y. 10001 YORK CITY ENERGY CONSERVATION CODE.

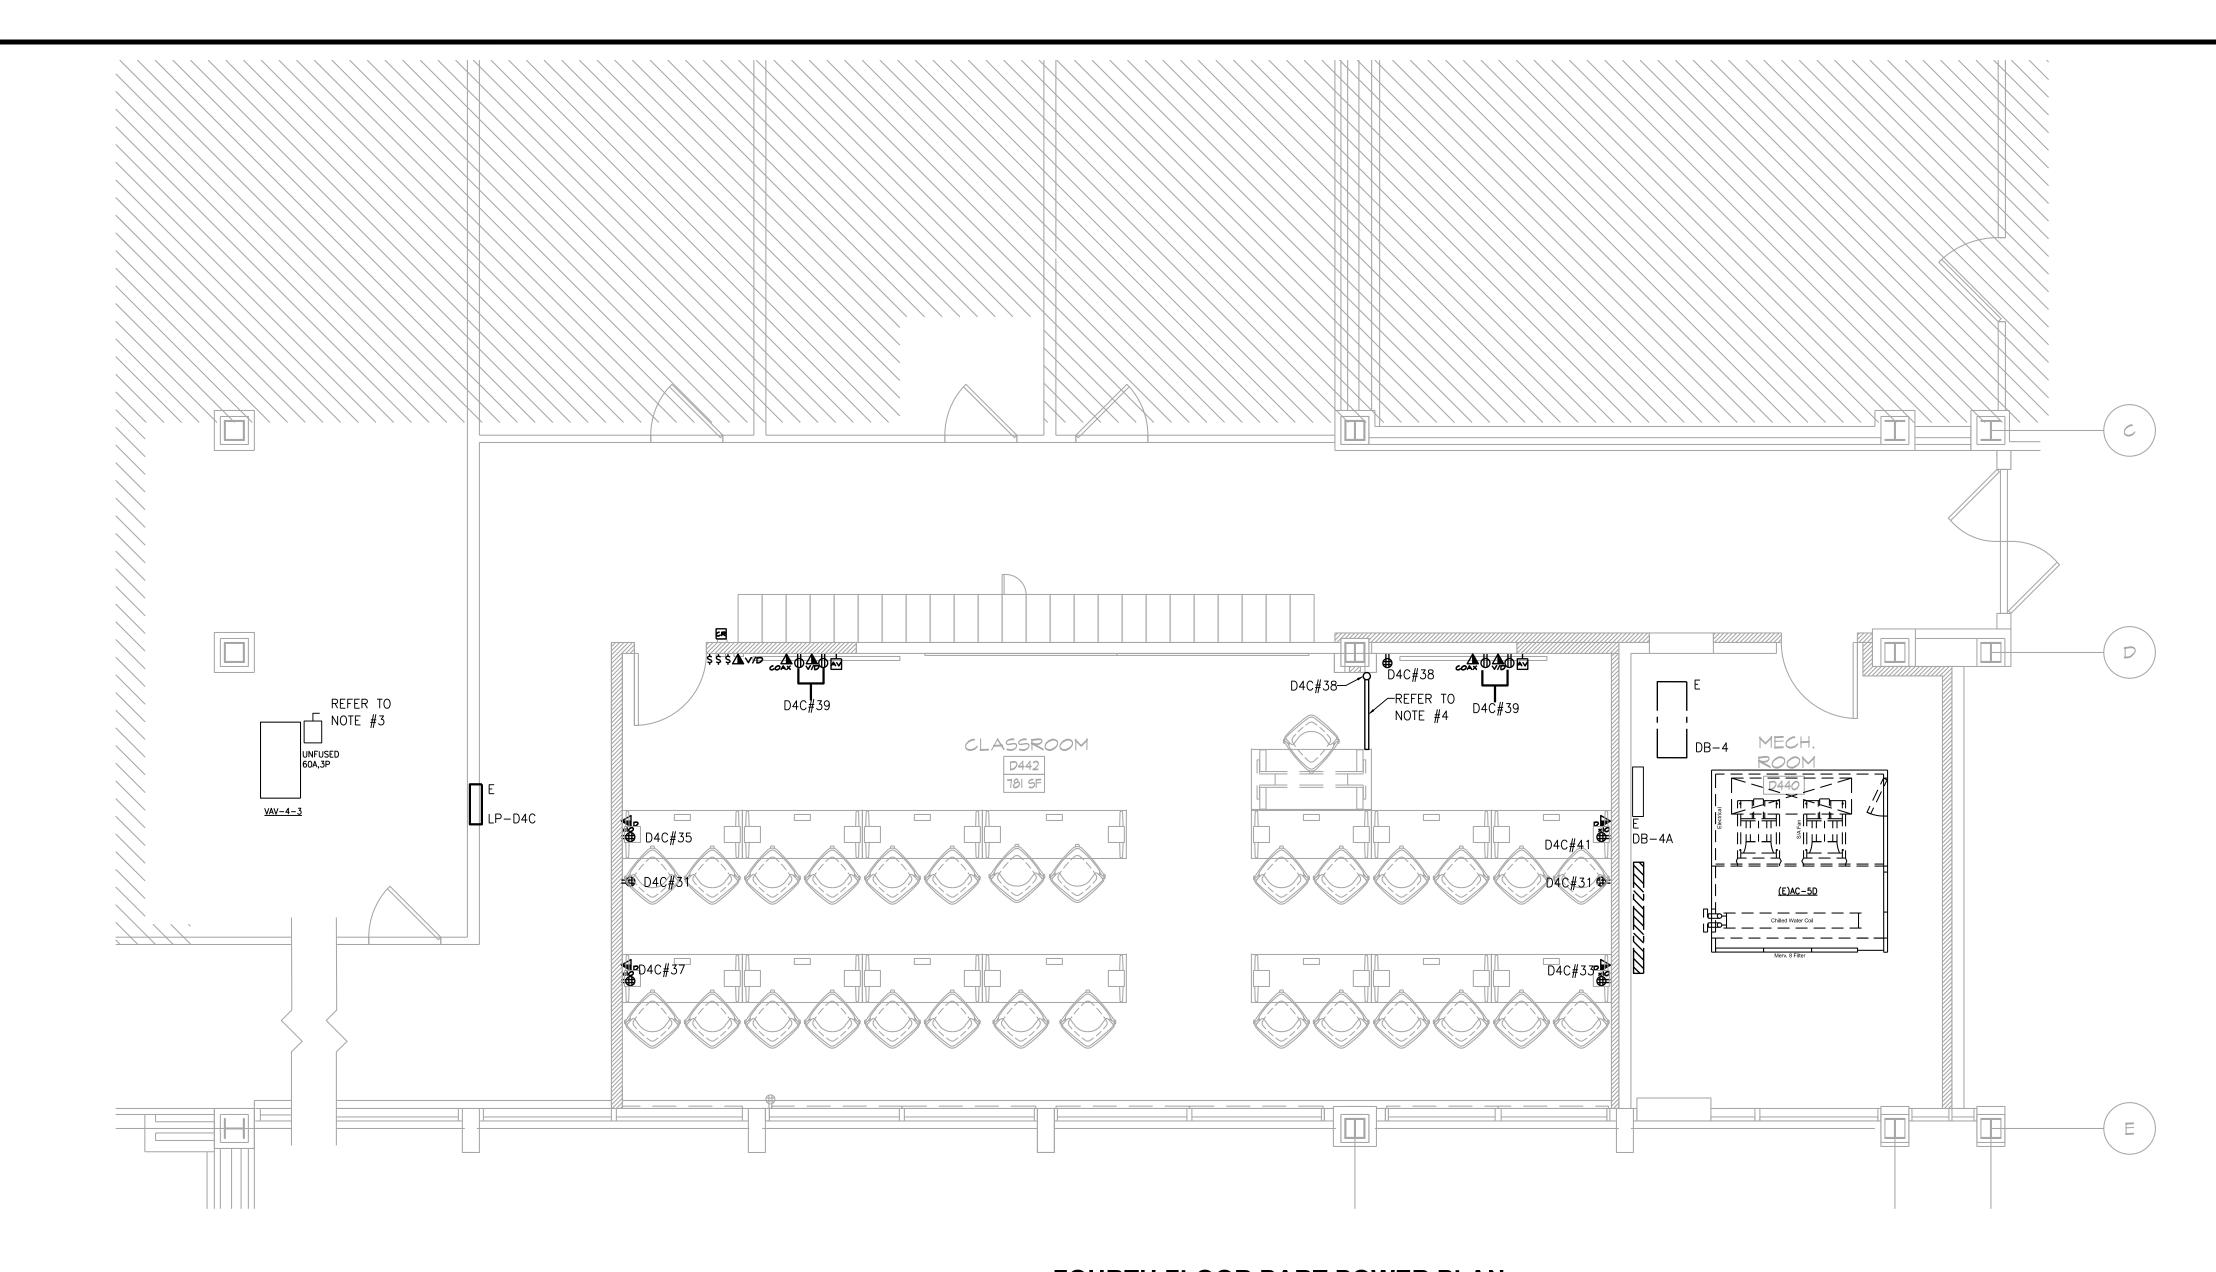

### FOURTH FLOOR PART POWER PLAN

SCALE:1/4"=1'-0"

#### POWER NOTES:

- 1. REFER TO ARCHITECTURAL DRAWINGS FOR THE EXACT LOCATION AND MOUNTING HEIGHTS OF ALL
- 2. CIRCUIT NUMBERS ARE INDICTED FOR GROUPING INTENT ONLY. THE ELECTRICAL CONTRACTOR SHALL REUSE EXISTING CIRCUIT BRANCH WIRING PREVIOUSLY FEEDING LIGHTING FIXTURES IN THE AREA.. ALL BRANCH CIRCUIT WIRING ORIGINATES IN A NEW 20A/1P CIRCUIT BREAKER IN PANEL INDICATED U.O.N. PROVIDE 2# 12 & 1# 12G-3/4"C. UON FOR BRANCH WIRING FEEDERS U.O.N. SPARE BRANCH CIRCUITS WILL BE PRODUCE FROM THE SCOPE OF THIS PROJECT. CONTRACTOR MAY UTILIZE EXISTING BRANCH CIRCUIT WIRING FOR INDICATED WORK WERE FEASIBLE.
- 3. EQUIPMENT SHALL BE ENERGIZED UNDER A SEPARATE CONTRACT. CONTRACTOR SHALL MAINTAIN POWER FEEDER
- 4. CONTRACTOR SHALL PROVIDE SURFACE MOUNTED CONDUIT SYSTEM WITH 2 DUPLEX OUTLETS, AND THE ABILITY TO HOUSE 8 OR MORE DATA CABLES. PROVIDE A CONNECTRAC FLEX SYSTEM OR


SCALE: 1/4" = 1'-0"

WITH APPLICABLE CODES.

#### NEW YORK CITY ENERGY CONSERVATION CODE

TO THE BEST OF MY KNOWLEDGE, BELIEF AND PROFESSIONAL JUDGMENT, THESE PLANS AND SPECIFICATIONS ARE IN COMPLIANCE WITH THE 2020 NEW YORK CITY ENERGY CONSERVATION CODE.



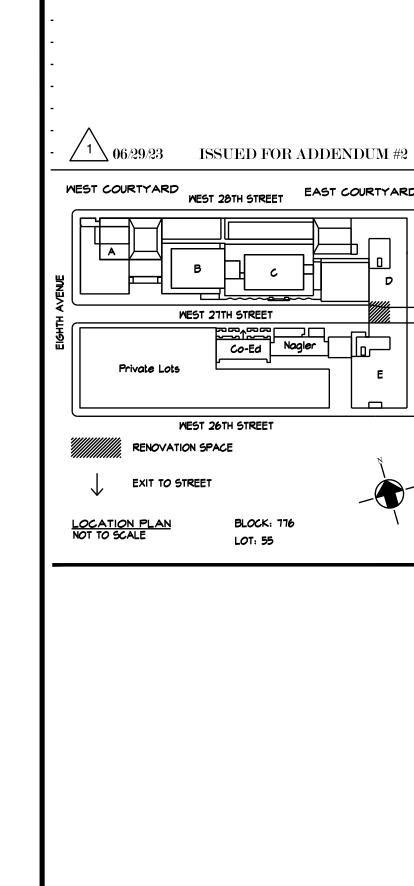

rev. no. date revisions

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D442 CLASSROOM RENOVATION POMERANTZ 300 7TH AVE NEW YORK NY 10001

DRAWING TITLE:

ELECTRICAL

4TH FLOOR PART POWER PLAN


DEPARTMENT OF BUILDING JOB #


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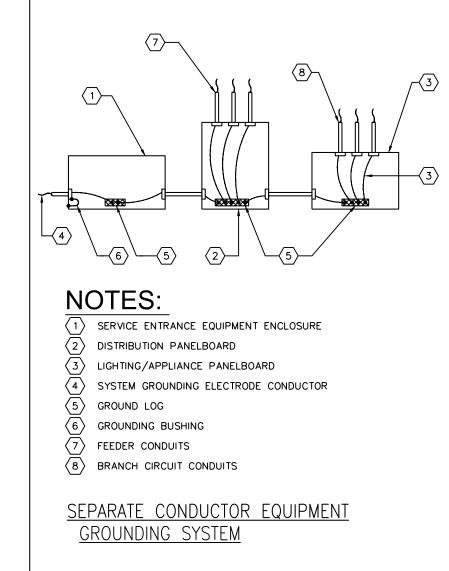
DATE: 06.07.2023 PROJECT No: 22320.3 DRAWING BY: DG CHK BY: KB


E-200.00


3 OF 5 SCALE: NTS



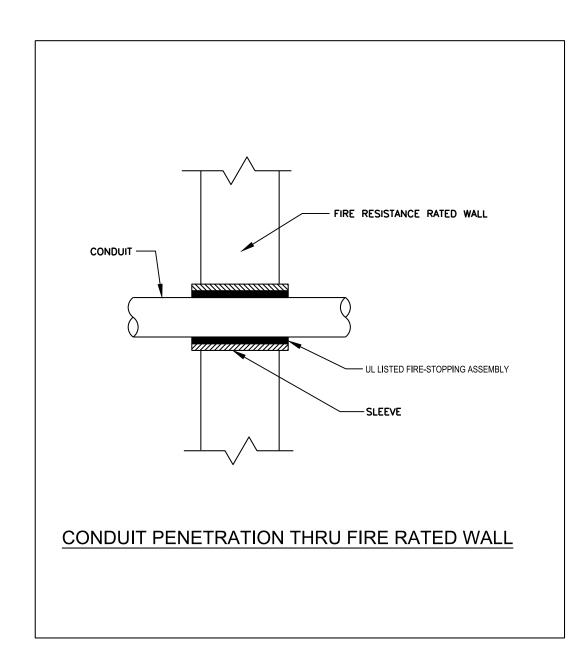


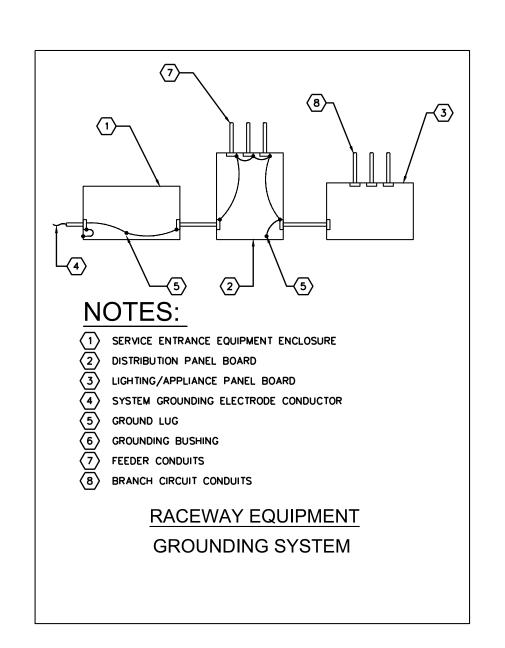

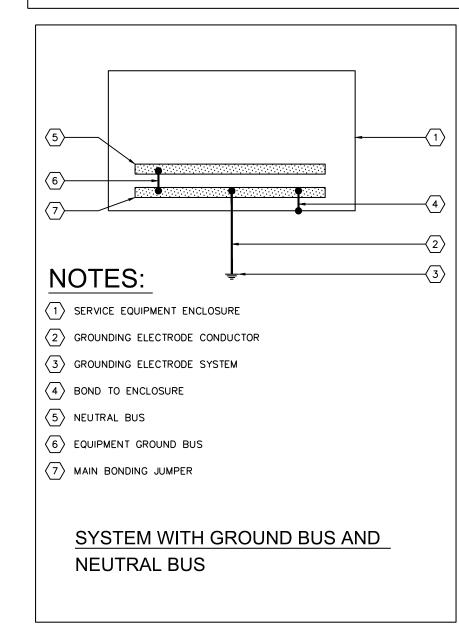

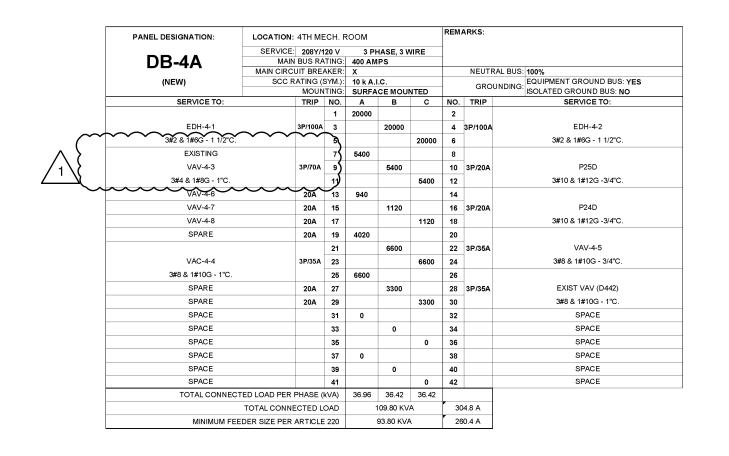

PANEL DESIGNATION:	LOCATION:	4TH M	ECH.	ROOM			REM	ARKS:	
	SERVICE:	208Y/	120 V	3 PI	IASE, 4 V	VIRE	1		
LP-D4C		BUS RA		225 AN			1		
2. 2.0	MAIN CIRCU			Х				NEUTR	AL BUS: 100%
(EXISTING)	SCC R	ATING (		10 k A.				GRO	UNDING: EQUIPMENT GROUND BUS: YES
055) (05.70		MOUN	_		ACE MOL				ISOLATED GROUND BUS: NO
SERVICE TO:		TRIP	NO.	Α .	В	С	NO.	TRIP	SERVICE TO:
EXISTING			1	0			2		EXISTING
EXISTING			3		0		4		EXISTING
EXISTING			5			0	6		EXISTING
EXISTING			7	0			8		EXISTING
EXISTING			9		0		10		EXISTING
EXISTING			11			0	12		EXISTING
EXISTING			13	0			14		EXISTING
EXISTING			15		0		16		EXISTING
EXISTING			17			0	18		EXISTING
EXISTING			19	0			20		EXISTING
EXISTING			21		0		22		EXISTING
EXISTING			23			0	24		EXISTING
EXISTING			25	0			26		EXISTING
EXISTING			27		0		28		EXISTING
EXISTING			29			0	30		EXISTING
DUPLEX		20A	31	400			32		EXISTING
DUPLEX FOR FURNITURE S	YSTEM	20A	33		1400		34		EXISTING
DUPLEX FOR FURNITURE S	YSTEM	20A	35			1400	36		EXISTING
DUPLEX FOR FURNITURE S	YSTEM	20A	37	1800			38	20A	DUPLEX
DUPLEX FOR FURNITURE S	YSTEM	20A	39		1400		40		EXISTING
DUPLEX FOR FURNITURE S	YSTEM	20A	41			1400	42		EXISTING
TOTAL CONNECTE	D LOAD PER F	PHASE (	kVA)	2.20	2.80	2.80			
•	TOTAL CONNEC	CTED LO	DAC		7.80 KVA		21	1.7 A	
MINIMUM FEED	ER SIZE PER A	RTICLE	220		6.00 KVA		16	8.7 A	

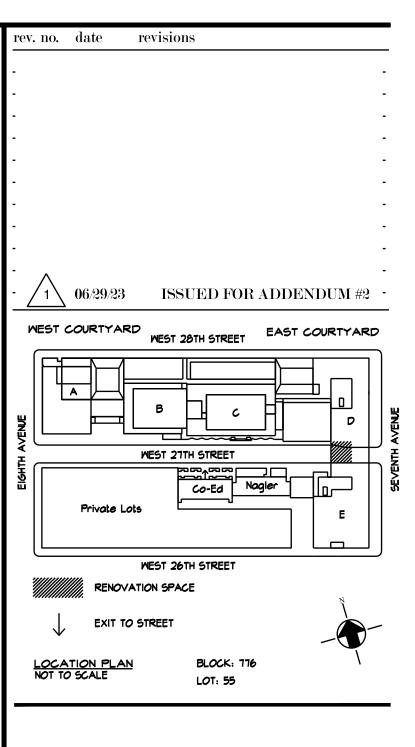

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DRAWING TITLE: ELECTRICAL PARTIAL POWER RISER DIAGRAM AND DETAILS

DEPARTMENT OF BUILDING JOB #

SEAL & SIGNATURE:

DATE: 06.07.2023 PROJECT No: 22320.3 DRAWING BY: AB CHK BY: WM E-600.00

SCALE: NTS

NEW YORK CITY BUILDING DEPARTMENT APPROVAL NOTE NEW YORK CITY ENERGY CONSERVATION CODE THIS PLAN IS APPROVED ONLY FOR WORK INDICATED ON THE APPLICATION

TO THE BEST OF MY KNOWLEDGE, BELIEF AND PROFESSIONAL JUDGMENT, SPECIFICATION SHEET. ALL OTHER MATTERS SHOWN ARE NOT TO BE RELIED THESE PLANS AND SPECIFICATIONS ARE IN COMPLIANCE WITH THE 2020 NEW UPON, OR TO BE CONSIDERED AS EITHER BEING APPROVED OR IN ACCORDANCE YORK CITY ENERGY CONSERVATION CODE.