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NOTICE TO ALL FIRMS

Date:	January 27,	2025
Duio.	oundary \mathbb{Z}^{r} ,	2020

From:	Sam Li	
	Director of Procurement Services	

Re:	Addendum Number 5
	IFB # C1592 – Goodman Lower Level Gallery New HVAC Unit

Notes:

1) An updated bid analysis form is attached to Addendum 5 below. Please complete and submit this updated bid analysis form with your bid.

Questions:

- Q1. The bid breakdown form provided is missing several items related to the scope of work on this project. Examples include, but are not limited to, steel work, GC work, rigging and water treatment. May we please add an additional line to the form labeled "Miscellaneous" to include these?
- A1. A line for miscellaneous items has been added to the updated bid analysis form. See attached.
- Q2. Drawings M600 shows "pipe support columns" at the base of the risers. Please provide a detail of these support columns.
- A2. See sketches provided for pipe supports.
- Q3. M503 and M504 show details for pipe anchors and guides. Please show where these are applicable, including quantities, on the drawings.
- A3. Anchors are not required. See sketches provided for pipe supports.
- Q4. Drawings M401 calls for the relocation of existing reheat piping as needed to allow for installation of the new risers. Please indicate on the drawings what piping is in conflict and would need to be removed or include an allowance in the contract for these relocations.
- A4. The contractor shall include in his bid an allowance for all the floors. The need to remove the reheat pipes will be determined during construction.

THIS ADDENDUM IS PART OF THE CONTRACT DOCUMENT AND SHALL BE INCLUDED WITH YOUR REQUEST FOR PROPOSAL SUBMITTAL. YOUR SIGNATURE BELOW WARRANTS THAT YOU UNDERSTAND THIS ADDENDUM AND THAT YOU HAVE MADE THE APPRORIATE ADJUSTMENTS IN YOUR PROPOSAL AND CALCULATIONS.

Signature

Print Name and Title of Authorized Representative

Print Name of Company/Partnership/Individual

Date

ATTACHMENT C – BID ANALYSIS FORM (1/27/2025)

FASHION INSTITUTE OF TECHNOLOGY & GOODMAN LOWER LEVEL GALLERY NEW HVAC UNIT INVITATION FOR BID NUMBER C1592 NYS PREVAILING WAGE SCHEDULE PRC # 2024015597

BID BREAKDOWN

Line	Description	Total Labor Cost	Total Materials, Tools & Equipment	Line Total
1	DEMOLITION	\$	\$	\$
2	FIRE STOPS	\$	\$	\$
3	VALVES FOR HVAC	\$	\$	\$
4	VIBRATION ISOLATION	\$	\$	\$
5	HVAC SPECIALTIES	\$	\$	\$
6	TESTING AND BALANCING	\$	\$	\$
7	INSULATION FOR HVAC	\$	\$	\$
8	COMMISSIONING	\$	\$	\$
9	HVAC AUTOMATIC TEMPERATURE CONTROLS	\$	\$	\$
10	HVAC INTEGRATION ON BMS	\$	\$	\$
11	PIPING FOR HVAC	\$	\$	\$
12	PUMPS FOR HVAC	\$	\$	\$
13	SHEET METAL DUCTWORK	\$	\$	\$
14	FANS AND GRAVITY VENTILATORS	\$	\$	\$
15	AIR FILTERS	\$	\$	\$
16	AIR HANDLING UNITS	\$	\$	\$
17	VARIABLE FREQUENCY DRIVE	\$	\$	\$
18	HUMIDIFIER	\$	\$	\$
19	COOLING TOWER	\$	\$	\$
20	ELECTRICAL	\$	\$	\$
21	PLUMBING	\$	\$	\$
22	STRUCTURAL STEEL	\$	\$	\$
23	MISCELLANEOUS	\$	\$	\$
24	FIRE ALARM	\$	\$	\$
25	GENERAL REQUIREMENTS	\$	\$	\$
26	GENERAL CONDITIONS	\$	\$	\$

TOTAL BID PRICE (1-26)

\$

As stated in Section IV of the front-end documents: Subcontracting shall be permitted not to exceed 50% of the work of the project. Please provide the ratio of the contractors and subcontractors work that will be used on this project.

Contractor _____%, Subcontractor(s) _____%

For Bidding Purposes: the following sections pricing should cover the following items:

General Requirements: permits & licenses; project meetings; administrative overhead for submissions and shop drawings; progress photos; temporary facilities & controls; storage & protection of materials; project closeout; and project record documents.

General Conditions: supervision of work; all testing; coordination drawings; safety programs; insurance and performance & payment bonds.

The undersigned, having carefully examined all Contract Documents, including Notice to Bidders, Bid Terms and Conditions, Contract Terms and Conditions, General Requirements, General Conditions, Labor & Material Payment Bond, Performance Bond, Form of Bid, Non-Collusive Bidding Certification, Substitution Form Request, Contract, Affirmative Action Form, Change Order, Form, Contractor's Trade Payment Breakdown, Safety EHS Plan, Prevailing Wage Schedule, Specifications, and Drawings and having examined the existing conditions by on-site visit(s), hereby submits this Bid Analysis, covering all labor, materials, equipment, tools, machinery, licensing, insurance, taxes, and fees required to perform the specified work at the above-referenced site, in accordance with the Contract Documents. **No exclusions & no exceptions**.

Company Name and Address of Bidder:

Signature of Bidder	Date	
Printed Name and Title of Representative:		
Telephone #:		
Email Address:		
EIN#:		

IMPORTANT:

This bid analysis form is the **only** pricing format acceptable. Bidders **must** submit pricing

using this form. FIT will not accept bid responses on any other form.

NOTE:

FIT will not sign any bidder generated contract, agreement or scope of work. FIT Bid and Terms and Conditions apply. Bidder requirement for FIT to sign any document will be grounds for rejection. Bidder inclusion of any conditions, clarifications, exceptions or changes which are not in compliance with FIT Bid and Terms and Conditions will be grounds for rejection.


GENERAL NOTES

- 1. THE GENERAL NOTES APPLY TO ALL DRAWINGS UNDER THIS CONTRACT. REFER TO INDIVIDUAL DRAWINGS FOR ADDITIONAL NOTES.
- DRAWINGS ARE DIAGRAMMATIC AND INDICATE GENERAL ARRANGEMENT OF SYSTEMS AND WORK, FOLLOW DRAWINGS IN LAYING OUT WORK, MAINTAIN HEADROOM AND SPACE CONDITIONS CONSISTENT WITH PROJECT CRITERIA.
- 3. JUNCTION AND PULL BOXES SHALL GENERALLY BE LOCATED FOR FLUSH MOUNTING IN FINISHED SPACES. WHERE NECESSARY, CONDUIT SHALL BE REMOUTED OR OTHER ARRANGEMENTS SHALL BE MADE FOR CONCCALMENT. PULL BOXES SHALL BE PROVIDED AS INDICATED AND WHEREVER NECESSARY TO FACILITATE PULLING OF WHE AND COORDINATE LOCATION WITH OTHER TRADES. COVERS OF JUNCTION AND PULL BOXES SHALL BE ACCESSBILE.
- 4. ALL SUPPORTS TO BUILDING STRUCTURE SHALL BE SECURED AS NOTED IN THE SPECIFICATIONS. HORIZONTAL RUNS OF METALLIC CONDUIT SHALL BE SUPPORTED AT INTERVALS OF NOT MORE THAN ID FEET APART. RACEWAY RISERS SHALL BE SUPPORTED AT EACH FLOOR LEVEL EXPOSED RACEWAYS SHALL RUN PARALLEL WITH OR AT RIGHT ANGLES TO WALLS.
- 5. JUNCTION BOXES AND PULL BOXES SHALL BE SUPPORTED INDEPENDENTLY TO BUILDING STRUCTURE WITH NO WEIGHT BEARING ON CONDUIT.
- 6. NO RACEWAYS SHALL BE INSTALLED WITHIN 3 INCHES OF STEAM OR HOT WATER PIPES, OR APPLIANCES, EXCEPT FOR CROSSINGS WHERE RACEWAYS SHALL BE AT LEAST 1 INCH FROM PIPE COVER.
- CONDUIT ENDS SHALL BE CUT SQUARE AND REAM SMOOTH. MALE THREADS OF FIELD THREADED CONDUIT SHALL BE PAINTED WITH GRAPHITE BASED PIPE COMPOUND AND DRAWN UP TIGHT WITH CONDUIT COUPLINGS.
- 8. WIRE COLOR CODING SHALL CONFORM TO CODE REQUIREMENTS.
- IN UNFINISHED PORTIONS OF THE BUILDING, SUCH AS BUILER ROOM, FAN ROOMS, PIPE SPACES, ETC., LICATIONS OF EDHOLIT ARE APPROXIMATE AND SHALL CLEAR PIPING AND ALL OTHER CONSTRUCTION. CONDUITS IN THESE PORTIONS OF THE BUILDING SHALL BE RUN EXPOSED.
- 10. ALL DUTLET BOXES RECEIVING 1-1/4" CONDUIT SHALL BE A MINIMUM OF 2-1/2"DEEP.
- 11. SUFFICIENTLY LONG WIRE SLACK SHALL BE LEFT IN RUNS TO PERMIT MAKING PROPER FINAL CONNECTIONS. ALL EMPTY CONDUIT SHALL BE PROVIDED WITH #12 AWG STEEL DRAG WIRE.
- 12. ALL WIRING, POWER, CONDUCTORS, CONDUITS ETC. SHALL MEET THE NYC ELECTRICAL CODE.
- 13. ALL WORK SHALL BE IN ACCORDANCE WITH THE NYS BUILDING CODE AND NFPA 72.
- 14. ALL FIRE ALARM EQUIPMENT SHALL BE APPROVED (MEA, BSA OR COA APPROVED). 15. ALL FIRE ALARM CIRCUITS SHALL BE SIZED TO A MAXIMUM OF 80% OF CAPACITY.
- 16. ALL FIRE ALARM CIRCUITS SHALL BE WIRED NEPA STYLE 4/Y/B (CLASS B) WITH THE EXCEPTION OF
- ALL THE ALAMA GINOUTS SHALL BE WINED WITH STILL 4/7/3 (LASS B) WITH NOLLAIN). DUAL CLASS B THE NETWORK CROLIT WHICH SHALL BE NFPA STILL 7 (CLASS A WITH SOLLAITIN). DUAL CLASS B NETWORKING IS NOT STYLE 7 AND WILL NOT BE APPROVED. ALL AUDIBLE AND VISUAL CROUTS SHALL BE STILL Y/CLASS B AND SPILL A/B CROLITS SHALL BE WIRED SO THAT EVERY OTHER DEVICE IS WIRED ON AN ALTERNATE CIRCUIT.
- 17. ALL FIRE ALARM WRE SHALL BE CLEARLY LABELED IN JUNCTION BOXES AND CABINETS. ALL TERMINALS BALL BE NUMBERED AND LABELED. ALL CONNECTIONS SHALL BE EITHER SOLDERED, 70DBA APPROVED TERMINAL STRIPS OR SOCIOT LOXOS.
- 18. ALL LOW VOLTAGE FIRE ALARM CONDUCTORS SHALL BE PROTECTED BY EITHER BUILDING CONSTRUCTION OR CONDUIT TO 8 FEET ABOVE THE FINISHED FLOOR. LGADING DOCKS, GARAGES, SUPPRESSION AND EXTINGUISHING SYSTEM WIRING, MECHANICAL AND ELECTRICAL ROOMS AND OTHER LOCATIONS SUBJECT TO MECHANICAL DAMAGE SHALL BE IN FULL RIGID CONDUIT, IN ALL OTHER AREAS APPROVED WIRE MAY BE RUN WITHOUT CONDUIT ABOVE 8 FT. ALL WIRING INSTALLATION EXPOSED IN FINISHED AREAS SHALL BE AS FOLLOWS: A) ON WALLS IN SINGLE PICEC 1/2° SURFACE MOUNTED STEEL RACEWAY. B) WHERE CEILING IS NOT ACCESSIBLE IN SINGLE PIECE SURFACE MOUNTED STEEL RACEWAY.

- 22. FIRE ALARM CABLES SHALL NOT BE MIXED WITH NON FIRE ALARM CABLING, LOW VOLTAGE FIRE ALARM CABLING SHALL NOT BE MIXED OR WIRED NEAR ANY AG CIRCUIT
- ALL LOW VOLTAGE WIRING SHALL BE FPLP ISO DEGREE C. ALL NOTIFICATION CIRCUITS SHALL BE A MINIMUM OF 14 AWG AND ALL OTHER LOW VOLTAGE FIRE ALARM CIRCUITS SHALL BE 16 ANG MINIMUM. 23.
- 24. POLARITY SHALL BE OBSERVED IN ALL CIRCUITS. T-TAPPING SHALL NOT BE ALLOWED ON ANY NOTIFICATION CIRCUITS (HORN, STROBE OR SPEAKER). T-TAPPING SHALL NOT BE PERMITTED ON ADDRESSABLE CIRCUITS.
- 25. ALL WIRING SHALL BE INSPECTED TO ASSURE THERE ARE NO OPENS, SHORTS OR EARTH CROUNDS,
- 26. SHIELDED CONDUCTORS OR RUNNING IN SEPARATE RACEWAY SHALL BE AS INSTRUCTED BY THE FIRE ALARM MANUFACTURER'S DOCUMENTATION. ALL NON-POWER LIMITED WIRING SHALL BE RUN IN A SEPARATE RACEWAY.
- 27. ALL AREA OR DUCT SMOKE DETECTORS SHALL BE PHOTO-ELECTRIC TYPE.
- 28. SMOKE DETECTORS MUST BE MOUNTED AT LEAST 3 FT AWAY FROM ANY AIR REGISTER.
- 29. DEVICE LOCATIONS MUST BE READILY ACCESSIBLE TO ALLOW FOR MAINTENANCE AND REPAIR. 30. DUCT MOUNTED SMOKE DETECTORS SHALL BE MOUNTED ON THE DUCTWORK IN STRICT ACCORDANCE WITH THE MANUFACTURERS INSTRUCTIONS. ALL DUCT DETECTORS SHALL BE PROVIDED WITH A REMOTE LED IN AN OBSERVABLE AREA, EACH LED STATION TO BE LABEL PER UNIT AND DEVICE MONITORY.
- 31. ALL AUXILIARY RELAYS FOR FAN SHUTDOWN, DOOR RELEASE, DAMPER CONTROL, ELEVATOR CONTROL, ETC. SHALL BE WIRED A MAXIMUM OF 3 FT FROM THE CONTROLLED DEVICE. THE AUXILIARY RELAY SHALL FUNCTION WITHIN THE REQUIRED VOLTAGE AND CURRENT OF THE CONTROLLED DEVICE. SLAVE OR INTERPOSING RELAYS SHALL BE INCLUED AND POWERED BY THE FIRE ALARM CONTROL PAVEL IN A FAIL-SAFE (FIRE FUNCTION) POSITION. POWER TO THE INTERPOSING RELAY SHALL BE MONITORED BY THE FIRE ALARM SYSTEM.
- 32. OBTAIN APPROVAL OF PLANS BY THE FIRE DEPARTMENT PRIOR TO THE BEGINNING OF ANY WORK.
- 33. THE CONTRACTOR SHALL BE RESPONSIBLE FOR REMOVING ANY AND ALL ABANDONED FIRE ALARM CABINETS, DEVICES, AND WIRE. PAINT, PATCH AND CLEANUP SHALL ALSO BE INCLUDED.
- 34. COORDINATE WITH MECHANICAL DRAWINGS FOR LOCATION AND CONNECTION OF POWER AND CONTROL TO THE EXISTING AND NEW FSD AND DUCT SMOKE DETECTOR DEVICES.
- 35. THE CONTRACTOR IS REQUIRED TO COORDINATE THE SCHEDULING OF ALL INSPECTIONS WITH THE NYC FIRE DEPARTMENT WITH:
- High RISE FIRE & SECURITY 703 3RD AVE BROOKLYN, NY 11232
- IN ORDER TO OBTAIN THE FINAL FONY LETTER OF APPROVAL AND SIGNOFF THE DOB APPLICATION AS PART OF THE SCOPE OF FIRE AND BUILDING CODE SERVICES, INC. AT EACH INSPECTION, A MINIMUM OF TWO FIRE ALARM TECHNICANS WITH SAY OR SAY ECRIFICATIONS AND ONE ELECTRICIAN SHOULD BE PRESENT.
- 36. THE CONTRACTORS PRESENCE AT ALL OF THE OWNERS PRE-INSPECTIONS PRIOR TO THE FDNY INSPECTION AND ALL FDNY INSPECTIONS. A MINIMUM OF ONE ELECTRICAL CONTRACTOR AND TWO (2) FIRE ALARM TECHNICIANS SHALL BE PRESENT AT ALL INSPECTIONS.
- 37. THE CONTRACTOR IS RESPONSIBLE TO PREPARE AND PROVIDE THE AS-BUILT RISER PLAN AND THE APPLICANT OF RECORD IS PETER GERZADUNIS WILD WILL BE SIGNING AND SEALING THE FUNCTIONALITY STATEMENT IN ACCORDANCE WITH THE REQUIREMENTS OF SRCHY RID5.01(C) (2) (A) (3) AND (4).
- EXISTING DEVICES AND FIRE ALARM EQUIPMENT SHALL BE PROPERLY PROTECTED DURING DEMOLITION AND CONSTRUCTION.

SEQUENCE OF OPERATION

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		STSTEM CUTIOUS Activity County Activity activity a Local Audrie Activity Status Status Staticula and Franti Amandation have a Percasa	VSLULLY ANUNCAIE THE DEVICE IN ALARM AT THE PRE COMMAND STATION AND REMOTE AMUNCATION WHERE APPLICABLE	Actuate common trougle scowi indicator & local audible trougle scowi at the free command staticm and remote anumicator where applicable	VSJULIY AMUNCARE NE DEVCE OR ORCHIT IN Trouble at the free common station and Renote annunciator nhere Applicable	actuate comuch supervisory signal molcator. Bsplay dy Leo and rewote anumcandr where Applicable	actuate local audible superfinisory Scient and revoie annuncator Hhere Applicable	an vit Lidous Vannis Istone Signation - Activity	ACTUATE SPEAKER APPLIANCES TO SOUND EVAC. TONE ON ALL FLOORS IN THE BURDING.	actuate speaker appliances to sound indury tone on all floors	ACTUATE FLASHING FRE SIGN AT THE FIRE COMMAND STATION	PRINT EVENTS AT THE FIRE COMMAND STATION	recall elevators to the deschated level	M ALL AR	CLOSE ALL REQUIRED FIRE/SWOKE DAMPERS	OPERATE ALL DOOR STRIKE RELEASE RELAYS TO OPEN LOCKED DOORS	DPERATE ALL DOOR HOLDER RELEASE RELAYS TO ALLOW DOORS TO CLOSE
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1	MANUAL PULL STATION	-						¢	•	•	•	•		L	L	L	
2	AREA SMOKE DETECTOR	-	•					•	•	•	•	•		•	•	•	•
3	ELEVATOR RELATED SMOKE DETECTOR	•						•	•	•	•	•	•	•	•	•	
4	IN-DUCT SNOKE DETECTOR		•					•	•	•	•	•		•	•	•	- 🌩 🛛
5	HEAT DETECTOR	- •	•					•	•	•	•	•		•	•	•	
6	WATERFLOW SWITCH	- ÷	- 0					÷.	÷.	÷.	- 0-	Ø.	ÎØ	•	Ø.	Ø	9
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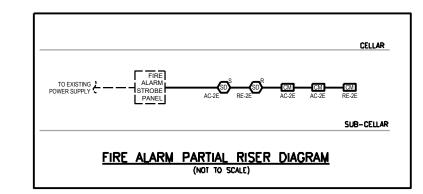


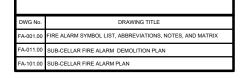SYMBOL LEGEND							
DUCT SMOKE DEFECTOR: R - RETURN FAN DUCT DEFECTOR: S - SUPPLY FAN DUCT DETECTOR							
CM	FAN SHUTDOWN CONTROL MODULES						
/////	NOT IN CONTRACT						

ABBREVIATIONS

	DESCRIPTION
AFF	ABOVE FINISHED FLOOR
C	CONDUIT
DGP	DATA GATHERING PANEL
DWG	DRAWING
Ε	EXISTING TO REMAIN
EC	EMPTY CONDUIT
ELEC	ELECTRICAL
FA	FIRE ALARM
FACP	FIRE ALARM CONTROL PANEL
FCO	FUSED CUTOUT

NЮ	NOT IN CONTRACT
FS	FAN SHUTDOWN




RESIDE BOTES:

AUDIBLE DEVICES SHALL PROVIDE ALARM SIGNALS THAT ARE EDUAL TO 15 DECIDELS ABOVE ANBIENT SOUND PRESSURE LEVEL FOR THE OCCUPANCY. BUSINESS OCCUPENCY HAS AMBIENT SOUND PRESSURE LEVEL 55 DECIDELS PER NFPA 72. THEREFORE, AUDIELE DEVICES SHALL BE 70 DECIDELS OR MORE SOUND PRESSURE LEVEL MECHANICAL SPACES SHALL ROYONE MINIMUM SOUND PRESSURE LEVEL OF DO ECIDELS.

THERE ARE NO CO PRODUCING EQUIPMENT LOCATED IN THIS BUILDING



		Drawing No.
DODMAN LOWER GALLERY NEW HVAC	SK-FA001	
282 7TH AVENUE, NEW YORK, NY 10001		
	Job No.	Date:
ALARM COVER SHEET, MATRIX, AND	01/27/25	
NOTES	Scale:	Reference Dwg.
ISER DIAGRAM ADDED TO COVER PAGE	N.T.S	FA-001.00

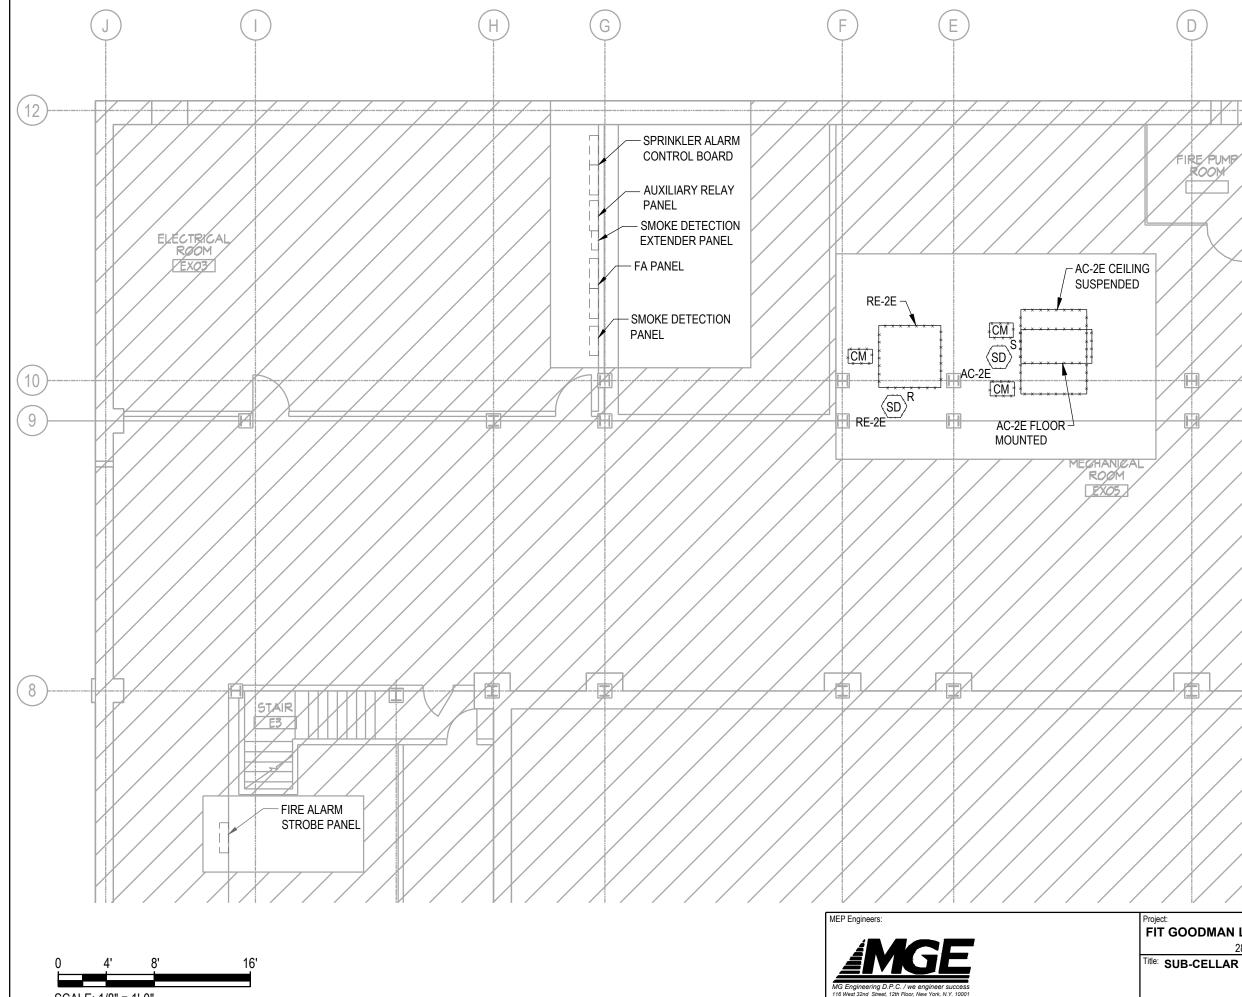

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GENERAL NOTES:


1. REFER TO THE E-000 SERIES FOR NOTES, MATRIX, ABBREVIATIONS, ETC.

WORK NOTES:

ROOM

EXISTING DUCT SMOKE DETECTORS AND CONTROL 1. MODULES ASSOCIATED WITH FAN SHUTDOWN TO BE REMOVED. ASSOCIATED CONDUIT AND WIRING SHALL BE REMOVED BACK TO THE SOURCE.

OODMAN LOWER GALLERY NEW HVAC 282 7TH AVENUE, NEW YORK, NY 10001	Drawing No. SK-FA011	
B-CELLAR FIRE ALARM DEMO PLAN	Job No. 8969.78	Date: 01/27/25
DUCT DETECTORS AND CONTROL MODULES DEMO	Scale: 1/8"=1'-0"	Reference Dwg. FA-011.00

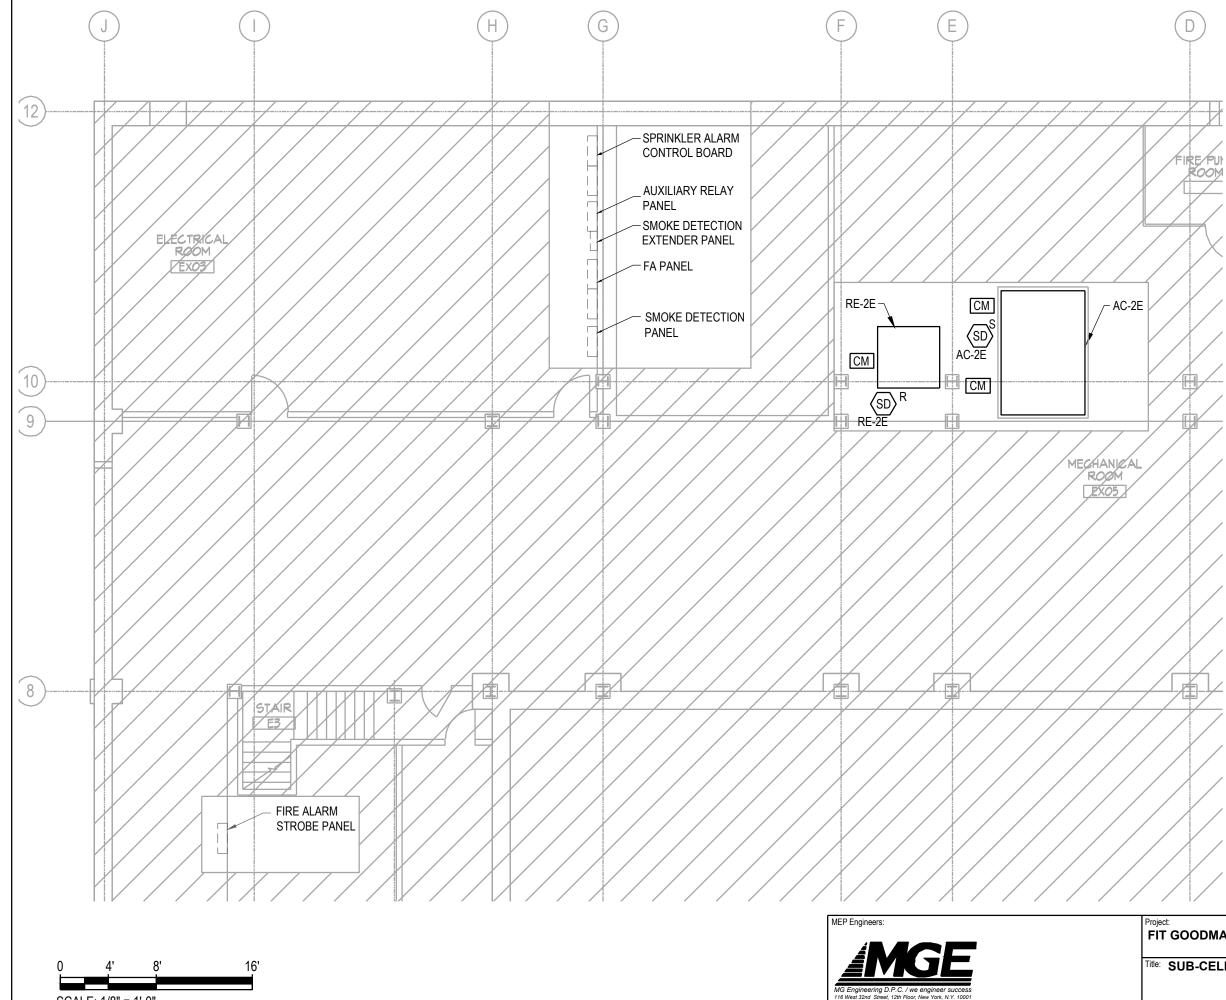

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GENERAL NOTES:

1. REFER TO THE E-000 SERIES FOR NOTES, MATRIX, ABBREVIATIONS, ETC.

WORK NOTES:

CONTRACTOR SHALL PROVIDE CONDUIT AND WIRING TO 1. CONNECT THE DUCT SMOKE DETECTORS AND CONTROL MODULES ASSOCIATED WITH FAN SHUTDOWN FOR UNITS AC-2E AND RE-2E TO THE EXISTING FIRE ALARM STROBE PANEL (NEXT TO STAIR E3).

OODMAN LOWER GALLERY NEW HVAC EQUIPMENT 282 7TH AVENUE, NEW YORK, NY 10001		Drawing No. SK-FA101
JB-CELLAR FIRE ALARM PLAN	Job No. 8969.78	Date: 01/27/25
DUCT DETECTORS AND CONTROL MODULES	Scale: 1/8"=1'-0"	Reference Dwg. FA-101.00

